



Design Rationale

6045 Linley Valley Drive & 6055 Turner Road, Nanaimo, BC.

20 Dec 2024

Project Summary

This project is located in the heart of North Nanaimo, at 6045 Linley Valley Drive, a COR3 Zone lot, and 6055 Turner Road, a CC3 Zone lot. These zones provide for a regional Community Corridor connecting residential areas to the commercial center with a focus on medium to high density residential with secondary retail and service uses. We are proposing two buildings: a 4-storey apartment building and a 6-storey apartment building with a ground floor commercial unit. The South end of the CC3 site will be used for a future phase. We are seeking a setback variance for the lot line between the 2 project lots.

Site Description

The sites are currently undeveloped, providing a great opportunity to introduce medium to high density residential and commercial uses to the existing neighbourhood. To the North of the site there is new residential apartments between which there is access to a public park trail along the creek leading to the nearby school. Heading East is a dead-end for vehicles, however, it has yet more green areas for residents around the creek wetlands. To the south of the site there is a new residential development that has a public path leading to Uplands Road and the nearby Nanaimo North Shopping Mall. Finally, to the West is the Longwood and Northridge malls beyond which is the Island Highway. We believe introducing this residential project in this location can contribute to the vibrancy of the neighbourhood.

The residential entries for the two buildings are off a centralized plaza along Linley Valley Drive. On the ground floor next to the plaza, in Building A, there is an amenity room for use by residents of both buildings. While in Building B there is a site manager's office and a fitness room also for use by both buildings. The project's refuse room is located within the underground under parking of Building A, allowing residents of both buildings' direct interior access. The CRU entry is on the Turner Road corner for visibility and street engagement. The site location offers residents options to use existing transit, bike, and pedestrian infrastructure for needs further away. As for vehicles, the two buildings are connected by an underground parking level containing just under 40% of the required parking. Only 32% of the total stalls are designed for small cars. Surface oriented auto courts are located to the rear of the buildings and are intersected by a ramp leading to the underground stalls. The rear surface auto courts are accessible off both

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unnamed side streets and are flanked by significant landscape elements to provide visual screening.

The two buildings use a cohesive materiality and design methodology. All the entries are highlighted with brick detailing for its durability and texture. The materials change at the decks and partitions to add contrast and depth to the exterior. Where the occupants and public are in close proximity to the building there is horizontal siding to add texture and human scale to the facade. The same horizontal siding is repeated on the ends where it can be seen at a distance on the larger wall areas to soften the appearance. Highlighting the corners of the building and drawing you to the entries, wood-like materials are used on the soffits and fin walls facing the decks. Warm greys are used to highlight the wood tones and divide the massing. The railings are designed to have clean lines and link units together along the length of the building.

Building A (6055 Turner Road) Description

The apartment on 6055 Turner Road is located on the North edge of the CC3 site along Linley Valley Drive. The building offers 63 rental units with 33% being 2 bed units, as well as 1 bed and studio units bringing a variety of rental units to the area. Additionally, this apartment has a CRU unit on the ground floor that is accessed from the sidewalk by the Turner Road roundabout.

The entries have been defined with thick overhead canopy elements which serve to block the sightlines into the units above. These wayfinding elements over the principal entries provide weather protection and offer a location for building signage. The entry is further defined with a change in facade material. The residential entry has been placed on the plaza linking it to the adjacent apartment. The CRU building entry, located on the northwest corner, is used to directly access the CRU, while also being located near the rear parking area. The Linley Valley Drive frontages are animated with residential decks overlooking the street. The absence of private unit street entrances is an intentional design choice to prioritize building security and allows the opportunity for larger landscape volumes by sizing up the soft landscaping selections around the building. The upper storeys utilize building elements that shelter the upper decks, and the vertical sections separate units giving the decks privacy while also sectioning the building to break up the facade. The other facades are treated with similar building elements and recesses to generate a dynamic, interesting massing from all viewpoints around the building. The building's refuse room is located in the underground parking, allowing residents direct access without going outside. Building A has 28% of its parking located



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underground, corresponding to a FAR increase of 0.07. On the ground floor next to the plaza, there is a resident amenity room with direct access to a patio for use by residents of both buildings.

Building B (6045 Linley Valley Drive) Description

The building on 6045 Linley Valley Drive is located on the North edge of the Cor3 site along Linley Valley Drive. The building offers 43 rental units with 35% being 2 bed units, as well as 1 bed and studio units bringing a variety of rental units to the area. Similar to Building A, the resident entry has been defined with thick canopy elements, highlighting the doors and serving to block the sightlines into the units above. These wayfinding elements over the principal entries provide weather protection and offer a location for building signage. The entry is further defined with a change in material. The residential entry has been placed on the plaza, linking it to the adjacent apartment. The Linley Valley Drive frontage is animated with residential decks overlooking the street. The absence of private unit street entrances is an intentional design choice to prioritize building security and allows the opportunity for larger landscape volumes by sizing up the soft landscaping selections around the building. The upper storeys utilize building elements that cover the upper decks, and the vertical sections separate units giving the decks privacy, while also sectioning the building to break up the facade. The other facades are treated with similar building elements and recesses to generate a dynamic, interesting massing from all viewpoints around the building. Building B has 55% of its parking located underground, corresponding to a FAR increase of 0.14. On the ground floor next to the plaza, there is a fitness room for use by residents of both buildings.



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Variance Rational

As part of this application, it is proposed that Planning and Council consider the following setback variances. The East Interior Side yard on the CC3 lot is adjacent to the other COR 3 part of the project so there will be 0 lot line underground and a lessened above ground setback on the plaza. Although there are no other required setback reductions, we would like to note it is our intent to use the allowable setback to project supported decks less than 2m over the required setbacks around the buildings on both sites.

Reduction of Allowable Setback

6055 Turner Road - CC3

Reduced Permitted Setback in the CC3 zone


Side Interior (East)

- Min allowable CC3 Side Interior Setback 3m
- Proposed Side Interior Underground Setback 0m
- Proposed Side Interior Setback 1.5m (this is to allow for the projections as they are not allowed on side Interior yards)


End of Letter

Thank you,
Daniel Smith
Architect AIBC

SUBJECT PROPERTY MAP

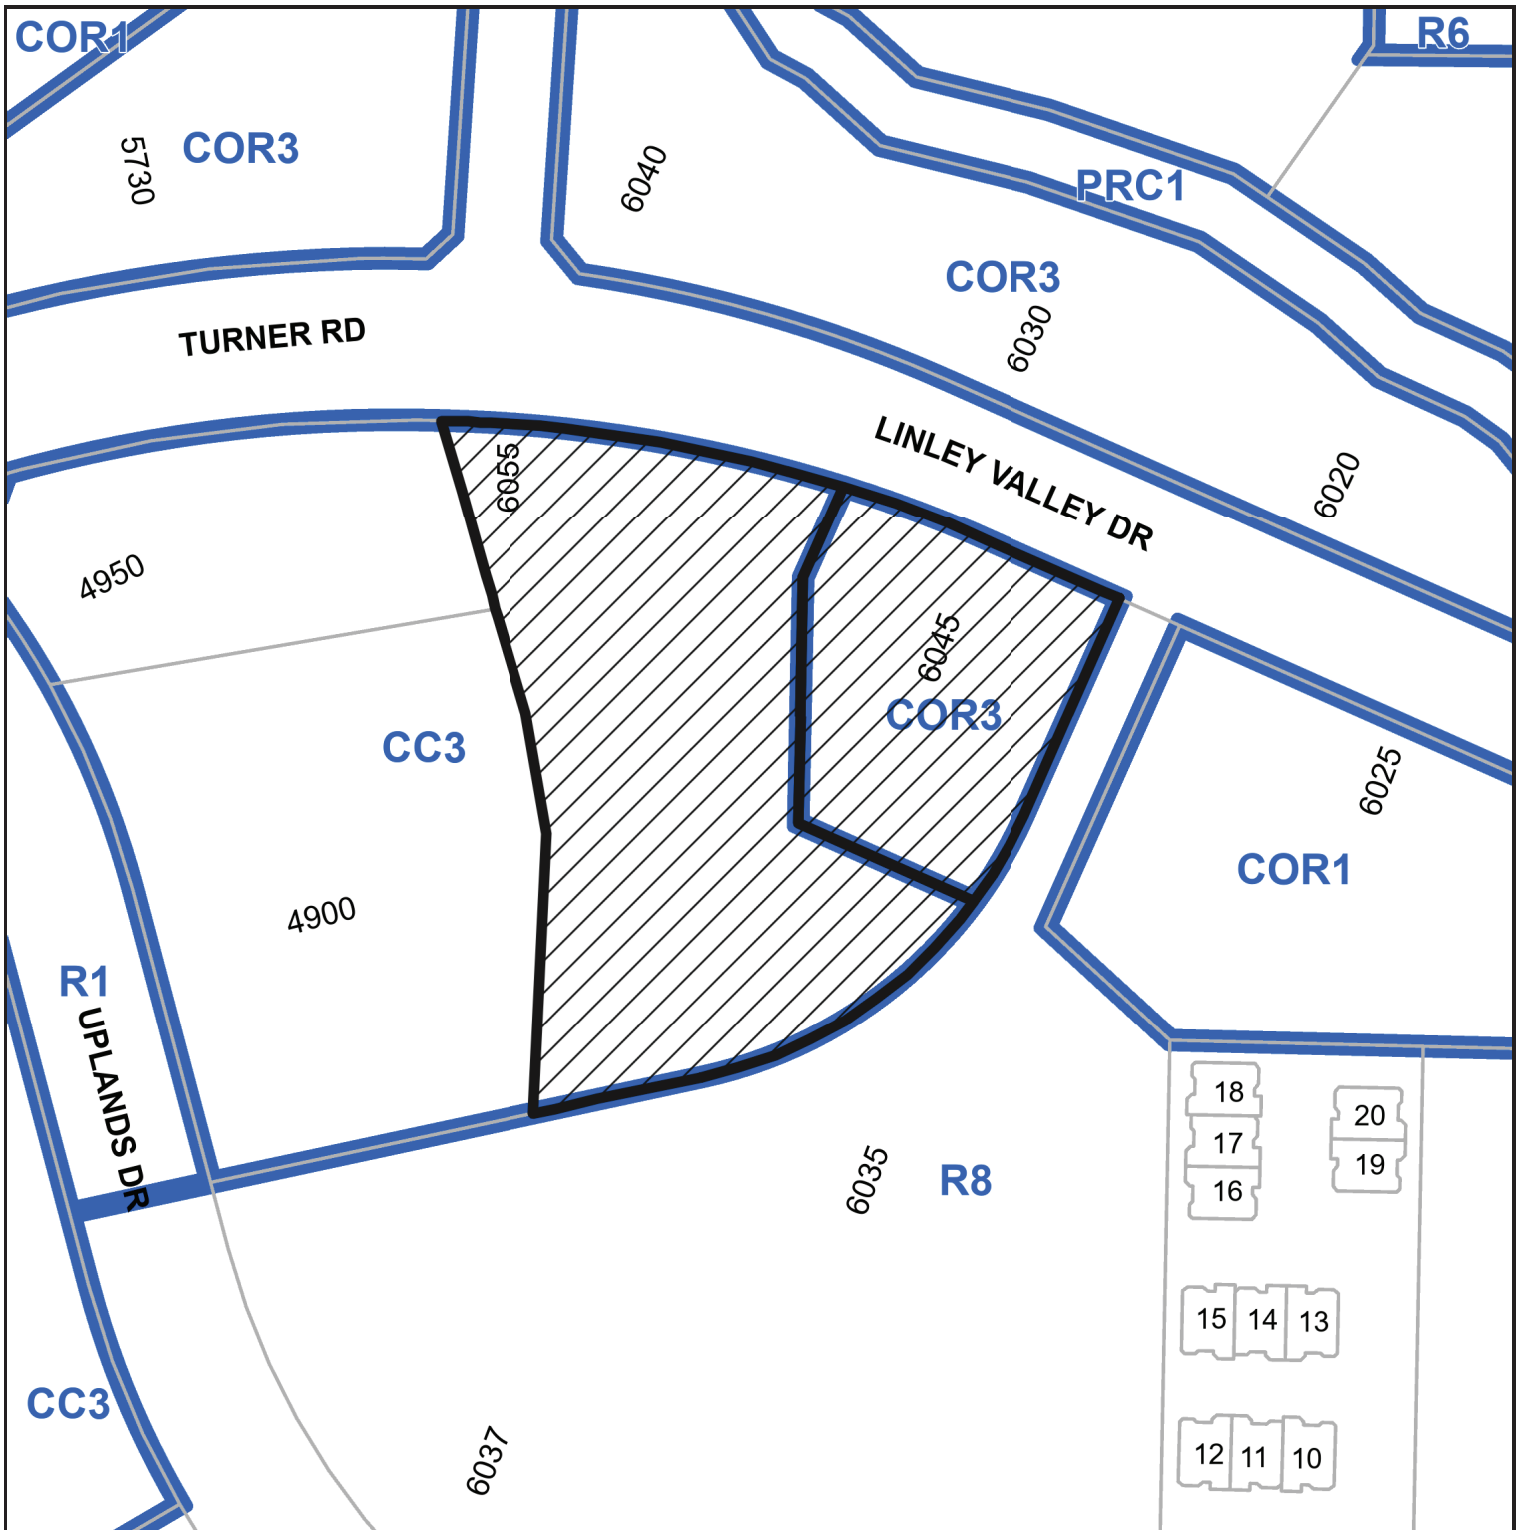

AERIAL PHOTO

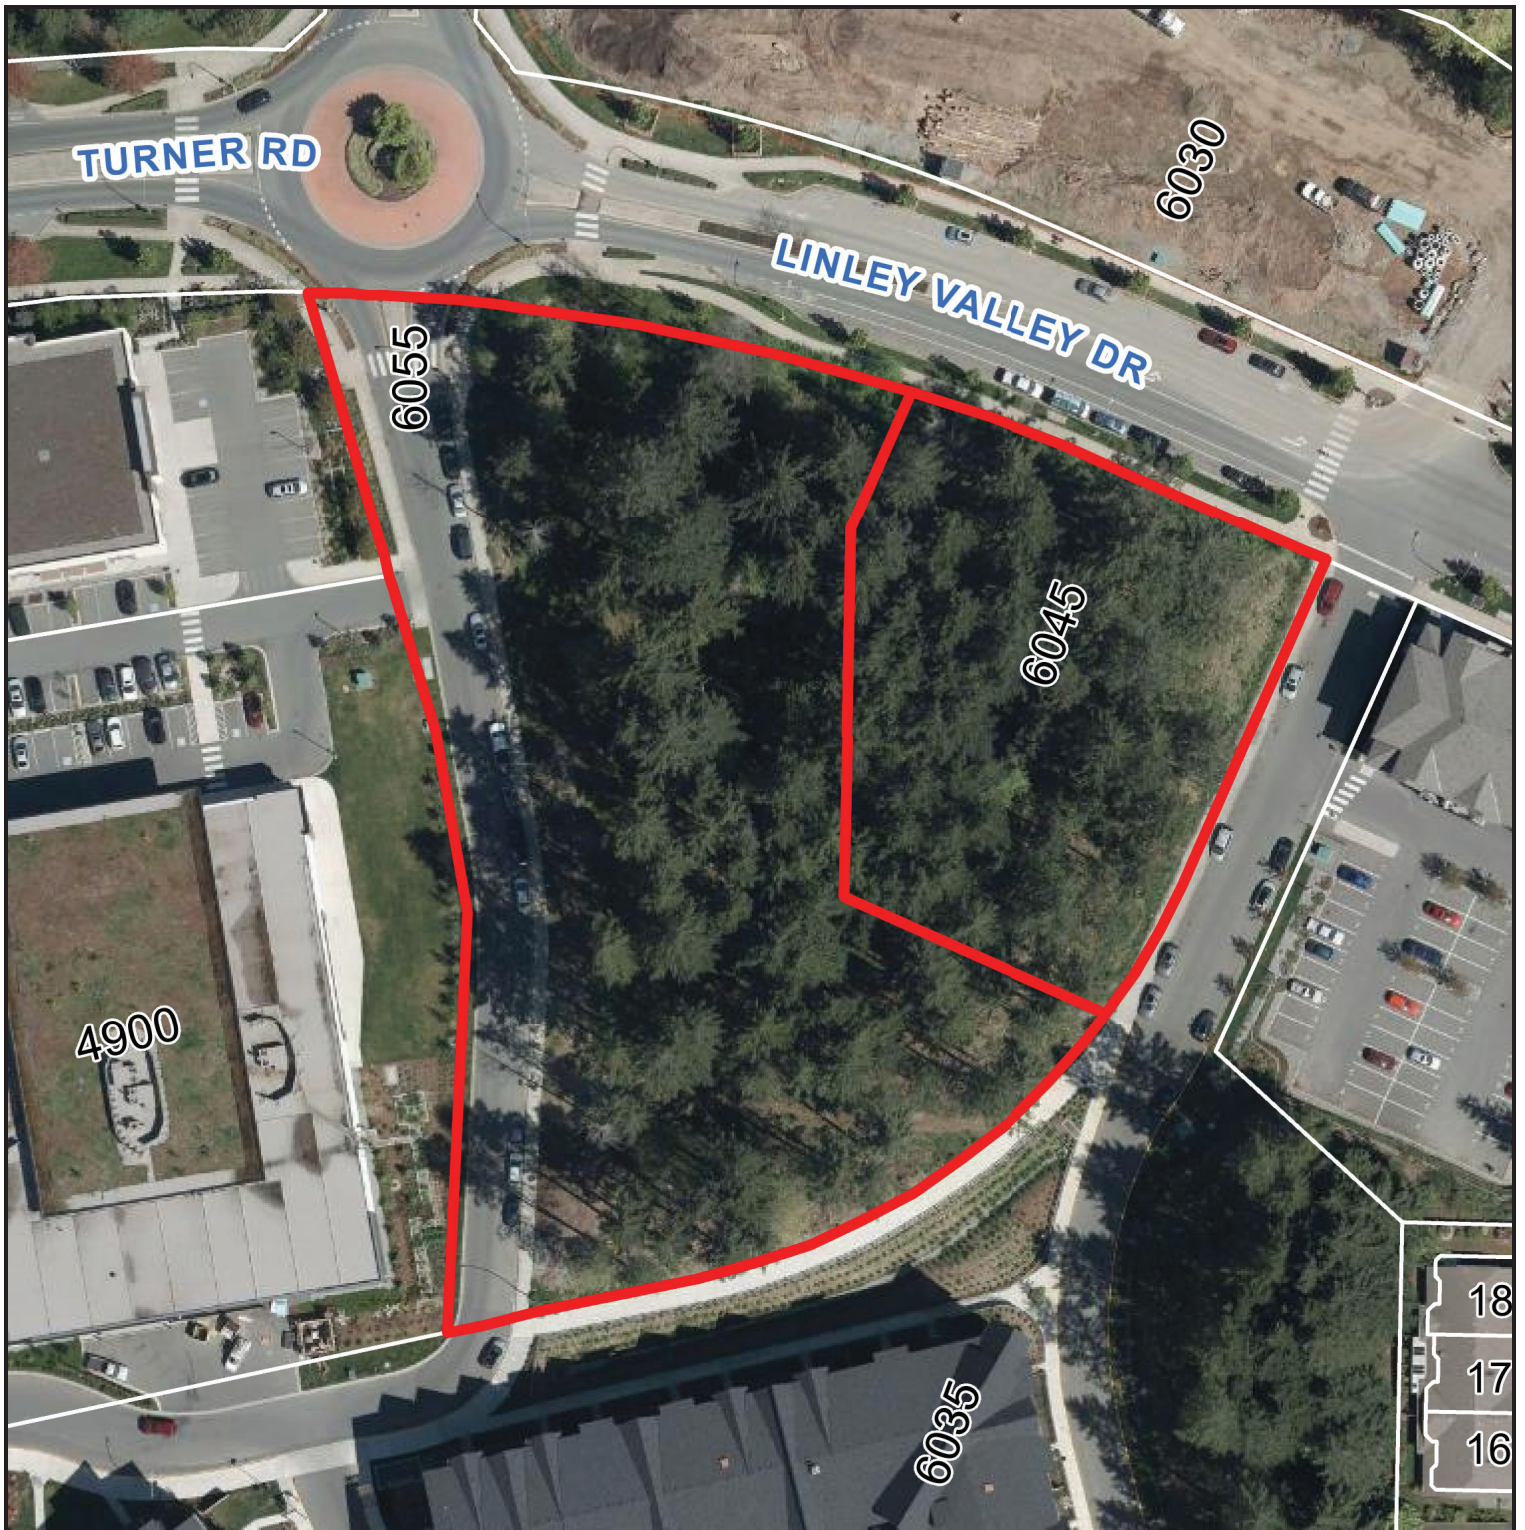

6045 Linley Valley Drive & 6055 Turner Road



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1	24-12-20	ISSUED FOR DP
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01	24-09-04	Issued for DP
02	24-09-04	DRS
03	12-09	DRS
04	12-09	DRS

Linley Valley
6045 Linley Valley Drive &
6055 Turner Road
SITE PLAN A & B



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A100
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MATERIAL PALETTE

- BRICK LIGHT
 - VERTICAL PLANK CEMENT PANEL SIDING LIGHT GREY
 - PERFORATED SOFFIT, IN WHITE
 - PERFORATED SOFFIT WOOD-LOOK PLANK, IN DOUGLAS FIR
 - WOOD-LOOK PLANK GLADDING, IN DOUGLAS FIR
 - FIBRE CEMENT PLANK LAP SIDING, WOOD GRAIN FINISH, IN DARK GREY
 - FIBRE CEMENT PANEL SIDING, SMOOTH FINISH, IN WHITE
 - FIBRE CEMENT PANEL SIDING, SMOOTH FINISH, IN WARM GRAY
 - FIBRE CEMENT PANEL SIDING, SMOOTH FINISH, IN DARK GRAY
 - VINYL DECKING, LIGHT GREY TONES
 - FASCIA MOUNTED ALUMINUM GUARDRAIL AND RAILING, POWDER COATED, BLACK, WITH PICKET GUARDS
 - BLACK SOLID GUARD RAILING
 - BLACK GUARDRAIL AND RAILING GLASS RAILING COLUMNS, WHITE/BLACK
 - COLUMNS, WOOD FEATURE TO MATCH WOOD-LOOK SIDING
 - CONCRETE WALL, SASH FINISHED, PAINT SEALED
- ALUMINUM CURTAINWALL SYSTEM, IN BLACK
 - ALUMINUM STOREFRONT GLAZING, IN BLACK
 - ALUMINUM STOREFRONT DOORS, IN BLACK
 - VINYL SWING GLASS DOOR, IN BLACK
 - VINYL WINDOWS, IN BLACK
 - STEEL DOOR, IN BLACK
 - PARKADE OVERHEAD DOOR, PICKET STYLE, IN BLACK
 - LOW SLOPED MEMBRANE DECK, IN DARK GREY TONES
 - LOW SLOPED MEMBRANE ROOF, IN DARK GREY TONES, WITH PARAPET AND CAP FLASHING
 - FASCIA: FIBRE CEMENT PANEL SIDING, WITH ALUMINUM CAP FLASHING COLOUR TO MATCH FASCIA
 - SIGNAGE
 - PLANTERS, REFER TO LANDSCAPE ARCHITECT PACKAGE
 - ELEVATOR OVER-RUN
 - MECHANICAL ROOM

* NOTE: FLASHING TO COLOUR MATCH MATERIALS
* NOTE: ILLUSTRATED BUILDING SIGNAGE IS PLACEHOLDER AND IS TO BE CONFIRMED IN A SEPARATE SIGNAGE APPLICATION TO MEET CITY OF NANAIMO SIGNAGE REQUIREMENTS

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NOTE: All dimensions are shown in millimeters.

Linley Valley
6045 Linley Valley Drive &
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Building A - N & W
Elevations

dhKa A301

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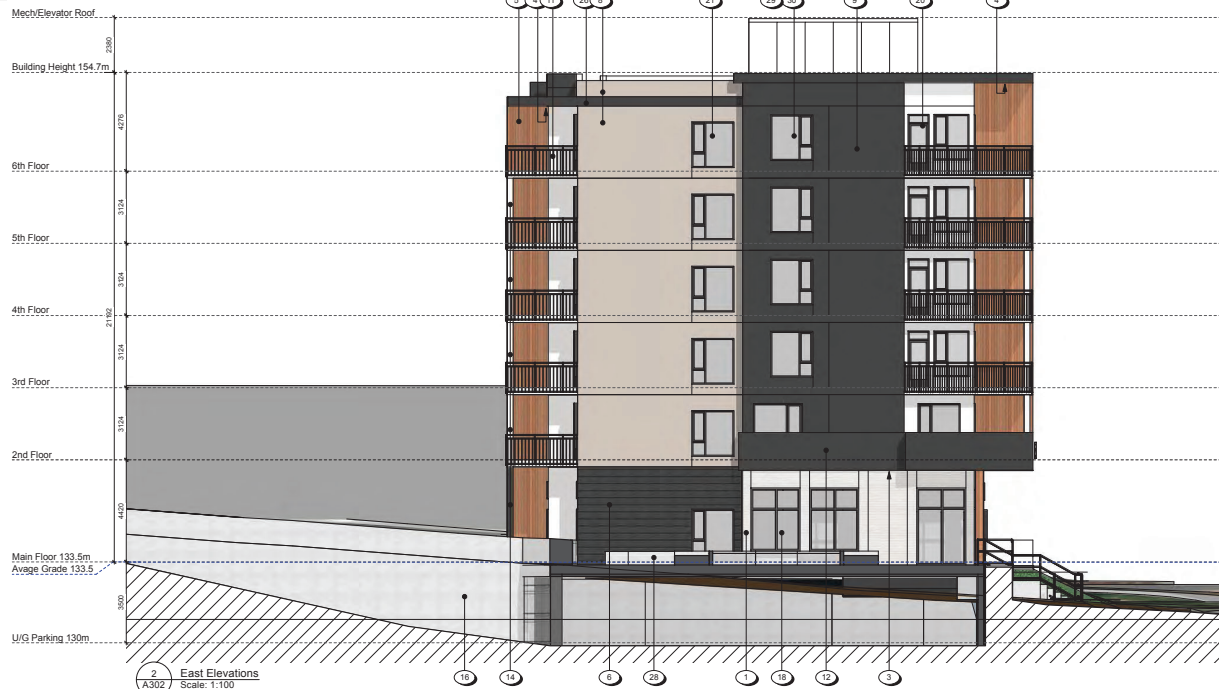
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1 South Elevations
Scale: 1:100



2 East Elevations
Scale: 1:100

MATERIAL PALETTE

- 1 BRICK LIGHT
- 2 VERTICAL PLANK CEMENT PANEL SIDING LIGHT GREY
- 3 PERFORATED SOFFIT IN WHITE
- 4 PERFORATED SOFFIT WOOD-LOOK PLANK, IN DOUGLAS FIR
- 5 WOOD-LOOK PLANK CLADDING, IN DOUGLAS FIR
- 6 FIBRE CEMENT PLANK LAP SIDING, WOOD GRAIN FINISH, IN DARK GREY
- 7 FIBRE CEMENT PANEL SIDING, SMOOTH FINISH, IN WHITE
- 8 FIBRE CEMENT PANEL SIDING, SMOOTH FINISH, IN WARM GRAY
- 9 FIBRE CEMENT PANEL SIDING, SMOOTH FINISH, IN DARK GRAY
- 10 VINYL DECKING, LIGHT GREY TONES
- 11 FASCIA MOUNTED ALUMINIUM GUARDRAIL AND RAILING, POWDER COATED, BLACK WITH PICKET GUARDS
- 12 BLACK SOLID GUARD RAILING
- 13 BLACK GUARDRAIL AND RAILING GLASS RAILING COLUMNS, WHITE/BLACK
- 14 COLUMNS, WOOD FEATURE TO MATCH WOOD-LOOK SIDING
- 15 CONCRETE WALL, SACK FINISHED, PAINT SEALED

- 16 ALUMINIUM CURTAINWALL SYSTEM, IN BLACK
- 17 ALUMINIUM STOREFRONT GLAZING, IN BLACK
- 18 ALUMINIUM STOREFRONT DOORS, IN BLACK
- 19 VINYL SWING GLASS DOOR, IN BLACK
- 20 STEEL DOOR, IN BLACK
- 21 PARKADE OVERHEAD DOOR, PICKET STYLE, IN BLACK
- 22 LOW SLOPED MEMBRANE DECK, IN DARK GREY TONES
- 23 LOW SLOPED MEMBRANE ROOF, IN DARK GREY TONES, WITH PARAPET AND CAP FLASHING
- 24 PASCAL FIBRE CEMENT PANEL SIDING, WITH ALUMINIUM CAP FLASHING COLOUR TO MATCH FASCIA
- 25 SIGNAGE
- 26 PLANTERS, REFER TO LANDSCAPE ARCHITECT PACKAGE
- 27 ELEVATOR OVER-RUN
- 28 MECHANICAL ROOM

* NOTE: FLASHING TO COLOUR MATCH MATERIALS
* NOTE: ILLUSTRATED BUILDING SIGNAGE IS PLACEHOLDER AND IS TO BE CONFIRMED IN A SEPARATE SIGNAGE APPLICATION TO MEET CITY OF NANAIMO SIGNAGE REQUIREMENTS

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Date	Revision	By	Check	Appr
24-09-04	01	DRS		GTW
2024-12-20	02			2436

Linley Valley
6045 Linley Valley Drive &
6055 Turner Road
Building A - S & E
Elevations

dhKa A302

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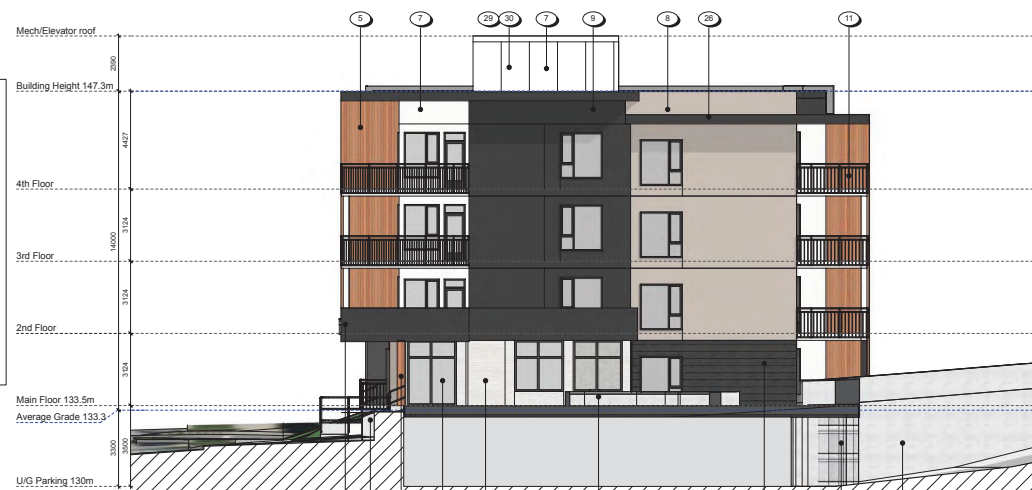


1 North Elevation
Scale: 1:100

MATERIAL PALETTE

- 17 BRICK LIGHT
- 18 VERTICAL PLANK CEMENT PANEL SIDING LIGHT GREY
- 19 PERFORATED SOFFIT IN WHITE
- 20 PERFORATED SOFFIT WOOD-LOOK PLANK, IN DOUGLAS FIR
- 21 WOOD-LOOK PLANK CLADDING, IN DOUGLAS FIR
- 22 FIBRE CEMENT PLANK LAP SIDING, WOOD GRAIN FINISH, IN DARK GREY
- 23 FIBRE CEMENT PANEL SIDING, SMOOTH FINISH, IN WHITE
- 24 FIBRE CEMENT PANEL SIDING, SMOOTH FINISH, IN MEDIUM GRAY
- 25 FIBRE CEMENT PANEL SIDING, SMOOTH FINISH, IN DARK GRAY
- 26 VINYL DECKING, LIGHT GREY TONES
- 27 FASCIA/MOUNTED ALUMINUM GUARDRAIL AND RAILING, POWDER COATED, BLACK, WITH PICKET GUARDS
- 28 BLACK SOLID GUARD RAILING
- 29 BLACK GUARDRAIL AND RAILING GLASS RAILING
- 30 COLUMNS, WHITE/BLACK
- 31 COLUMNS, WOOD FEATURE TO MATCH WOOD-LOOK SIDING
- 32 CONCRETE WALL, SACK FINISHED, PAINT SEALED
- 17 ALUMINUM CURTAINWALL SYSTEM, IN BLACK
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- 25 LOW SLOPED MEMBRANE ROOF, IN DARK GREY TONES, WITH PARAPET AND CAP FLASHING
- 26 FASCIA, FIBRE CEMENT PANEL SIDING, WITH ALUMINUM CAP FLASHING COLOUR TO MATCH FASCIA
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- 30 MECHANICAL ROOM

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2 West Elevation
Scale: 1:100


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1	24-12-20	ISSUED FOR DP	
2	24-09-04	Revised by	GTI
3	2024-12-20	Revised by	2436

Linley Valley
6045 Linley Valley Drive &
6055 Turner Road
Building B - N & W
Elevations

dhKa A303

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Linley Valley
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Building B - S & E
Elevations




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2	BRICK LIGHT	17	ALUMINIUM CURTAIN/LANT SYSTEM, IN BLACK
3	VERTICAL PLANK CEMENT PANEL SIDING LIGHT GREY	18	ALUMINIUM STOREFRONT GLAZING, IN BLACK
4	PERFORATED SOFFIT, IN WHITE	19	ALUMINIUM STOREFRONT DOORS, IN BLACK
5	PERFORATED SOFFIT WOOD-LOOK PANEL, IN DOUGLAS FIR	20	VINYL SWING GLASS DOOR, IN BLACK
6	WOOD-LOOK PLANK CLADDING, IN DOUGLAS FIR	21	VINYL WINDOWS, IN BLACK
7	FIBRE CEMENT PLANK LAD SIDING, STEEL GRAM FINISH, IN WHITE	22	STEEL DOOR, IN BLACK
8	FIBRE CEMENT PANEL SIDING, SMOOTH FINISH, IN WHITE	23	PARADE OVERHEAD DOOR, PICKET STYLE, IN BLACK
9	FIBRE CEMENT PANEL SIDING, SMOOTH FINISH, IN WARM GRAY	24	LOW-SLOPED MEMBRANE DECK, IN DARK GREY TONES, WITH PARAPET AND CAP FLASHING
10	FIBRE CEMENT PANEL SIDING, SMOOTH FINISH, IN DARK GRAY	25	FASCIA FIBRE CEMENT PANEL SIDING, WITH ALUMINIUM CAP FLASHING COLOUR TO MATCH FASCIA
11	VINYL CEILING, LIGHT GREY TONES	26	SIGNAGE
12	FASCIA MOUNTED ALUMINIUM GUARDRAIL AND RAILING, POWDER COATED, BLACK, WITH PICKET GUARDS	27	PLANTERS, REF. TO LANDSCAPE ARCHITECT PACKAGE
13	BLACK SOUNDED GUARD RAILING	28	ELEVATOR OVER-RUN
14	BLACK GUARDRAIL AND RAILING GLASS RAILING	29	MECHANICAL ROOM
15	COLUMNS, WHITE/BLACK		
16	COLUMNS, WOOD FEATURE TO MATCH WOOD-LOOK SIDING		
	CONCRETE WALL, SASH FINISHED, PAINT SEALED		

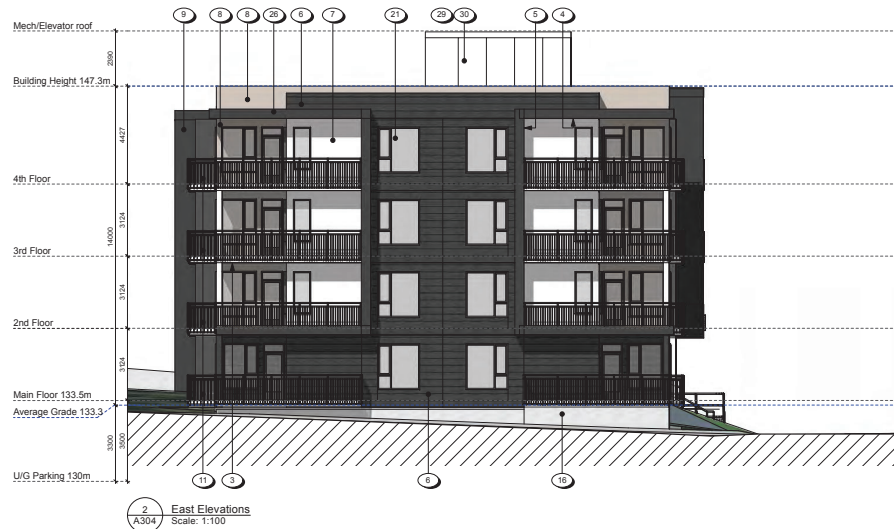* NOTE: FLASHING TO COLOUR MATCH MATERIALS

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1	24-12-20	ISSUED FOR DP	
Rev	Date	Description	
plot date	24-09-04	drawing file	
drawn by	DRS	checked by	GTH
scale	=	project number	2436

NOTE: All dimensions are shown in millimeters.

2004-12-20

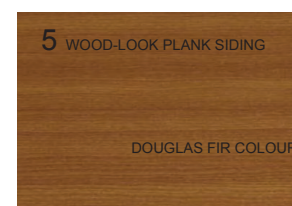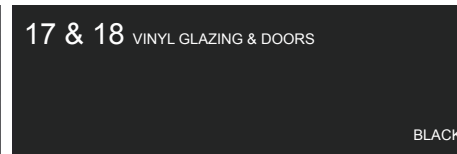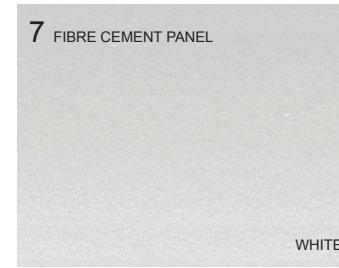Younghwan

BRITISH COLUMBIA

dHKA A401

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View Of Plaza And Entry From Linley Valley Drive



View From Linley Valley Drive



View From Turner Road to Linley Valley Drive



View From West Street Looking Toward Linley Valley Drive



View From Parking

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6045 Linley Valley Drive &
6055 Turner Road
Building A View Analysis



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Building A Above

Legend

■ - Common Area



Building B Above

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Rev	Date	Description
001	24-09-04	Issued for DP
002	01-10-24	Revised for DP
003	01-10-24	Revised for DP
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100	01-10-24	Revised for DP

Linley Valley
6045 Linley Valley Drive &
6055 Turner Road
U/G Parking Plan



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Nanaimo
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Building A

Building B

Legend

- Commercial
- 2 Bed
- 1 Bed
- Studio
- Amenity
- Common Area



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24-12-20	ISSUED FOR DP
24-09-04	24-09-04
DRS	DRS
1:150	2436

NOTE: All dimensions are shown in millimeters.

Linley Valley
6045 Linley Valley Drive &
6055 Turner Road
L1 - Main Floor Plan A&B



A201



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Building A

Building B

Legend

- Commercial
- 2 Bed
- 1 Bed
- Studio
- Amenity
- Common Area

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Current Planning

24-12-20	ISSUED FOR DP
24-09-04	2024-12-20
DRS	GTN
1:150	2436


Linley Valley
6045 Linley Valley Drive &
6055 Turner Road
L2-L6 Building A & B
L2-L4 Building B



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Building A

Building B

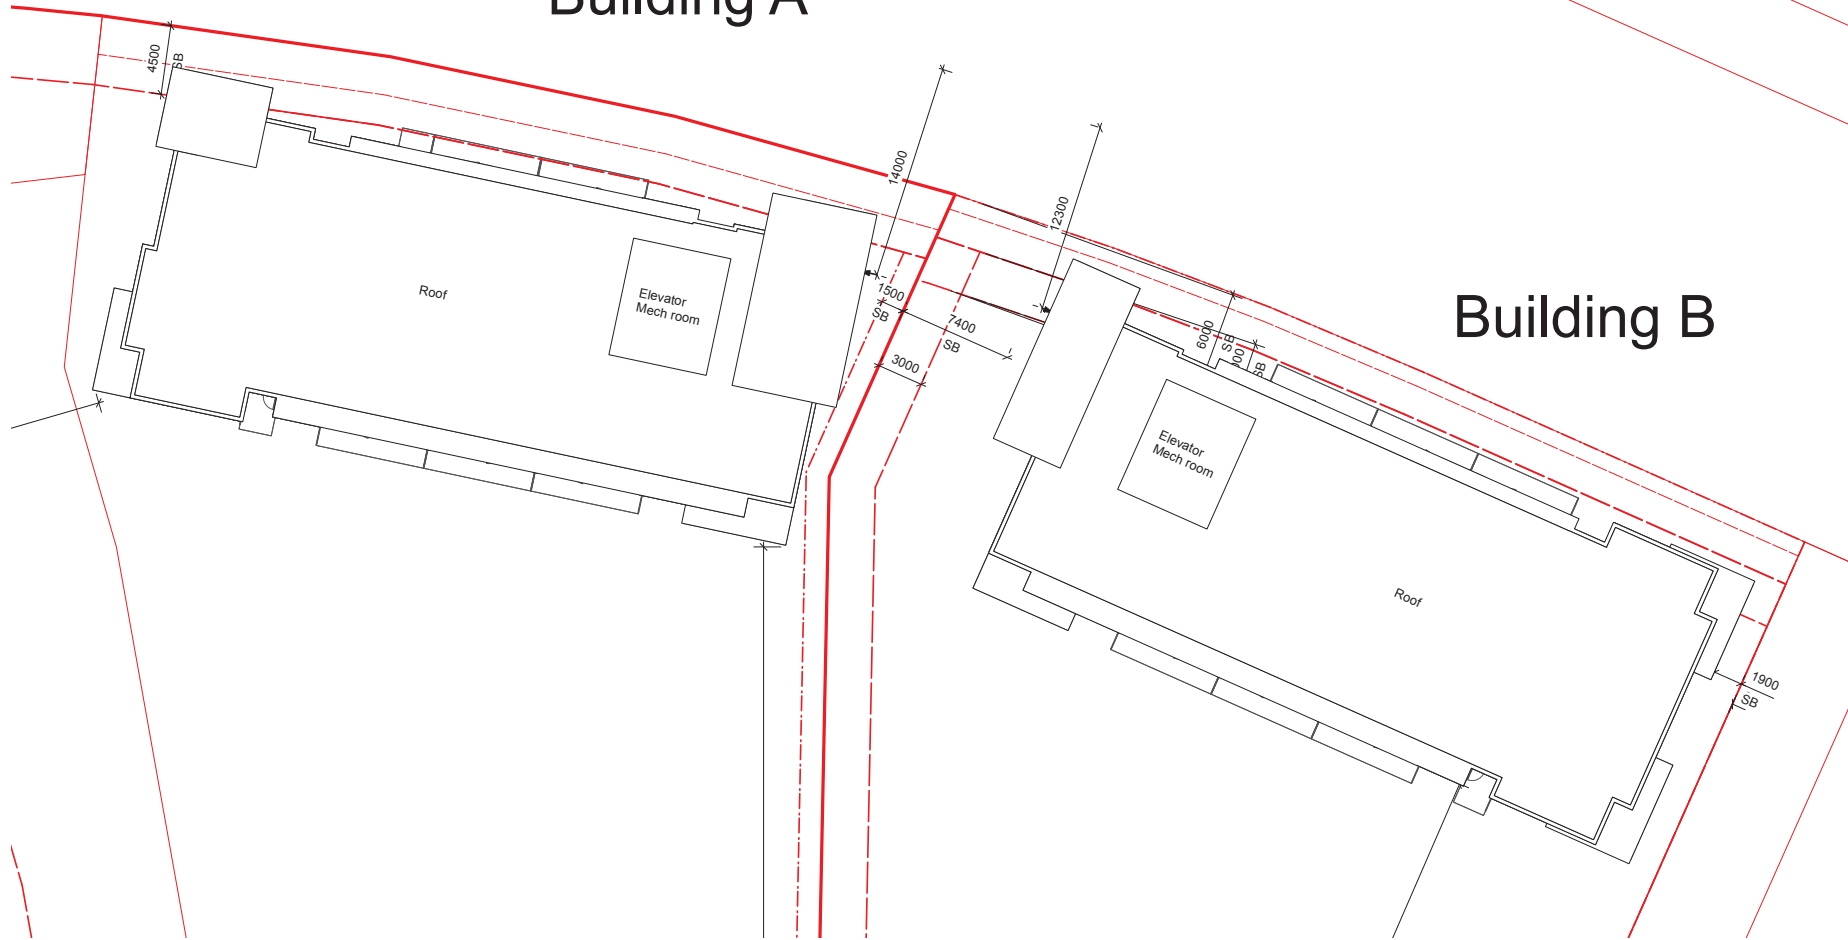

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1	24-12-20	ISSUED FOR DP
Rev	Date	Description
01	24-09-04	Issued for
02	01-10-24	Drawn by
03	01-10-24	Checked by
04	01-10-24	Approved by
05	01-10-24	Drawn by
06	01-10-24	Checked by
07	01-10-24	Approved by
08	01-10-24	Drawn by
09	01-10-24	Checked by
10	01-10-24	Approved by

Linley Valley
6045 Linley Valley Drive &
6055 Turner Road
Roof Plans A & B



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5-Storey Apartment



Office



4-Storey Apartment



Retail



Retail




5-Storey Apartment



4-Storey Apartment



Retail

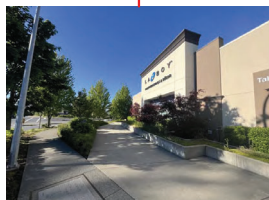

Retail



Retail



4-Storey Apartment



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2025-JAN-14
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Rev	Date	Description	Drawn By	Checked By	GTW
1	24-09-04	DRS	2405		

Linley Valley
6055 Linley Valley Drive &
6045 Turner Road
Neighbourhood Context
Streetscape

dhKa A002

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● MARKETS & RESTAURANTS

● RETAIL STORES

● OFFICE


● COMMUNITY CENTRE / SCHOOL

— PUBLIC TRANSIT AND STOPS

— PEDESTRIAN & BIKEWAY

● PARK

— STREAM

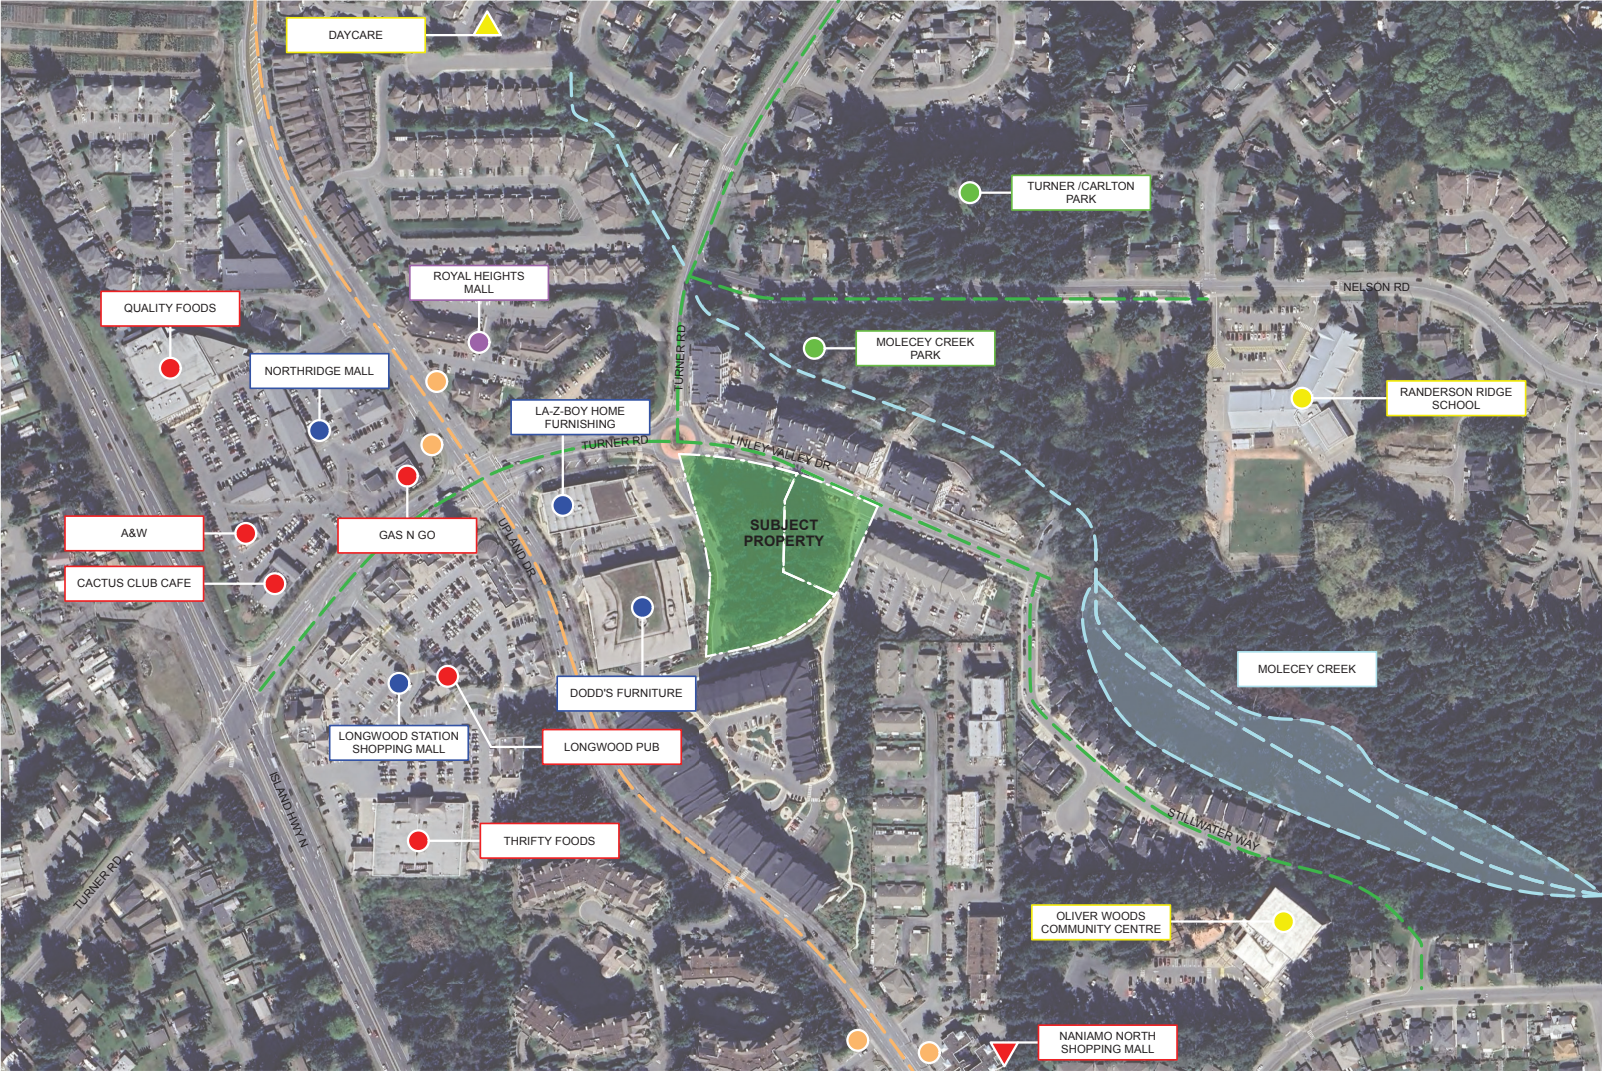

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2025-JAN-14

Current Planning

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24-09-04

DRS

2405

Linley Valley

6055 Linley Valley Drive &
6045 Turner Road

Neighbourhood Context
Streetscape

2024-12-20

2024-12-20

A003

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6045 Linley Valley Drive - Phase 1 District Group Nanaimo, BC

NOTES & LEGENDS

Date: December 13, 2024

Drawn: CM

Checked: CM

Scale: AS NOTED

Project Number: 24-0345

DRAWING NUMBER: L2 of 2

REVISION SCHEDULE		NOTES
#	Date	
0	03/01/2024	Draft LA Master Plan
1	14/05/2024	Draft DP
2	12/02/2024	Issued for DP

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2025-JAN-14
Current Planning

PLANTING NOTES

- ALL LANDSCAPE INSTALLATION AND MAINTENANCE SHALL MEET OR EXCEED THE MOST RECENT STANDARDS SET OUT BY THE CANADIAN NURSERY LANDSCAPE ASSOCIATION (CNLA) / CANADIAN SOCIETY OF LANDSCAPE ARCHITECTS (CSLA) CANADIAN LANDSCAPE STANDARD.
- GROWING MEDIUM SHALL MEET OR EXCEED THE PROPERTIES OUTLINED THE CANADIAN LANDSCAPE STANDARD PER SECTION 6. GROWING MEDIUM, TABLE T-6.3.5.2. PROPERTIES FOR GROWING MEDIA:
LEVEL 2 "ORCOMED" - 2P
GROWING MEDIUM DEPTHS: LAWN - 100mm
SHRUBS - 450mm
TREES - 600mm BELOW AND AROUND ROOTBALL
- MULCH SHALL BE COMPOST PER SECTION 10 MULCHING OF THE CANADIAN LANDSCAPE STANDARD. MULCH DEPTH SHALL BE 75mm MINIMUM OVER ALL TREE, SHRUBS AND GROUND COVER PLANTING AREAS.
- PLANT MATERIAL QUALITY, TRANSPORT AND HANDLING SHALL COMPLY WITH CNLA STANDARDS FOR NURSERY STOCK.
- ALL TREE, SHRUB, GROUND COVER AND LAWN AREAS SHALL BE WATERED VIA AN UNDERGROUND AUTOMATIC IRRIGATION SYSTEM UTILIZING SMART (ET) WEATHER-BASED IRRIGATION CONTROL. IRRIGATION EMISSION DEVICES SHALL BE HIGH EFFICIENCY LOW VOLUME ROTARY NOZZLES OR DRIP IRRIGATION EQUIPMENT.
- PLANT QUANTITIES ARE FOR INFORMATION ONLY. IN CASE OF ANY DISCREPANCY THE PLAN SHALL GOVERN.
- ALL PLANT MATERIAL SHALL MATCH TYPE AND SPECIES AS INDICATED ON THE PLANTING LEGEND. CONTACT THE LANDSCAPE ARCHITECT FOR APPROVAL OF ANY SUBSTITUTIONS. NO SUBSTITUTIONS WILL BE ACCEPTED WITHOUT PRIOR WRITTEN APPROVAL OF THE LANDSCAPE ARCHITECT.
- CHECK FOR LOCATIONS OF WATER LINES AND OTHER UNDERGROUND SERVICES PRIOR TO DIGGING TREE PITS. EXCAVATED PLANT PITS SHALL HAVE POSITIVE DRAINAGE. PLANT PITS WHEN FULLY FLOODED WITH WATER SHALL DRAIN WITHIN ONE HOUR AFTER FILLING.
- NO PLANTS REQUIRING PRUNING OF MAJOR BRANCHES DUE TO DISEASE, DAMAGE OR POOR FORM WILL BE ACCEPTED.

IRRIGATION NOTES

- THE IRRIGATION SYSTEM SHALL BE DESIGN-BUILD BY THE OWNER.
- IRRIGATION SYSTEM INSTALLATION SHALL MEET OR EXCEED THE REQUIREMENTS SET OUT IN THE MOST CURRENT VERSION OF THE CANADIAN NURSERY LANDSCAPE ASSOCIATION (CNLA) / CANADIAN SOCIETY OF LANDSCAPE ARCHITECTS (CSLA) CANADIAN LANDSCAPE STANDARD.
- ALL PROPOSED ON-SITE PLANTING AND LAWN AREAS SHALL BE WATERED VIA AN UNDERGROUND, AUTOMATIC IRRIGATION SYSTEM UTILIZING A "SMART" (ET) WEATHER-BASED IRRIGATION CONTROLLER.
- IRRIGATION EMISSION DEVICES SHALL BE LOW VOLUME ROTARY NOZZLES OR MICRO DRIP EQUIPMENT.
- THE CONTRACTOR SHALL ADJUST THE PLACEMENT AND RADIUS OF SPRINKLERS AS REQUIRED BY FIELD CONDITIONS TO ACHIEVE FULL COVERAGE OF ALL PLANTED AREAS AND TO MINIMIZE OVER-SPRAY ONTO ADJACENT HARD SURFACES, FENCES AND PROPERTY LINES.
- ALL PIPING UNDER PAVING SHALL BE INSTALLED IN SEPARATE SCHEDULE 40 SLEEVES AT A MINIMUM DEPTH OF 600mm WITH 150mm OF SAND BACKFILL ABOVE AND BELOW PIPE. ALL WIRING UNDER PAVING SHALL BE INSTALLED IN SEPARATE SCHEDULE 40 PVC CONDUIT. ALL SLEEVES AND CONDUIT SHALL BE INSTALLED PRIOR TO PAVEMENT INSTALLATION AND SHALL EXTEND 50mm BEYOND EDGE OF PAVEMENT OR CURB. BACKFILL FOR SLEEVES SHALL BE COMPACTED TO THE SPECIFIED DENSITY FOR THE SURGRADE.
- OPERATE IRRIGATION CONTROLLER WITHIN THE CITY OF NANAIMO WATER RESTRICTION SCHEDULE.

PLANT LEGEND


SYMBOL	BOTANICAL / COMMON NAME	SIZE	SPACING	QUANTITY	NOTES
TREES					
1.5m BUFFER					
	ACER RUBRUM 'REDPOINTE' FRANK JR. RED MAPLE	6cm CAL.	6.0m O.C.	10	NATIVE CANADIAN CULTIVAR
	CARPINUS BETULUS 'FRANS FONTAINE' FRANS FONTAINE HORNBEAM	4cm CAL.	SEE PLAN	2	PLAZA PLANTERS
	CORNUS 'EDDIE'S WHITE WONDER' EDDIE'S WHITE WONDER DOGWOOD	6cm CAL.	4.5m O.C.	4	NATIVE CULTIVAR
	PICEA PUNGENS 'HOOPSII' HOOPSII BLUE SPRUCE	2.5m	3.0m O.C.	10	DROUGHT TOLERANT CONIFEROUS
	PINUS FLEXILIS 'VANDERWOLF'S PYRAMID' VANDERWOLF'S PYRAMID PINE	2.5m	4.5m O.C.	5	NATIVE CULTIVAR, CONIFEROUS
	PSEUDOTSUGA MENZIESII DOUGLAS FIR	2.5m	5.0m O.C.	9	NATIVE SPECIES CONIFEROUS
	QUERCUS COCCINEA SCARLET OAK	6cm CAL.	SEE PLAN	2	DROUGHT TOLERANT
	SYRAK JAPONICA JAPANESE SNOWBELL	4cm CAL.	SEE PLAN	6	DROUGHT TOLERANT
SHRUBS					
	ACER CIRCINATUM MINE MAPLE	#5 POT	SEE PLAN	13	NATIVE SPECIES
	BUXUS 'GREEN VELVET' GREEN VELVET BOXWOOD	#1 POT	1.0m O.C.	35	
	CEANOTHUS THYRSIFLORUS 'VICTORIA' VICTORIA CALIFORNIA LILAC	#3 POT	1.5m O.C.	16	DROUGHT TOLERANT
	COTINUS COGGYGRIA 'ROYAL PURPLE' ROYAL PURPLE SMOKEBUSH	#7 POT	SEE PLAN	5	DROUGHT TOLERANT
	LONICERA NITIDA 'MAYGREEN' MAYGREEN BOX HONEYSUCKLE	#1 POT	1.0m O.C.	46	DROUGHT TOLERANT
	NANDINA DOMESTICA 'MOON BAY' COMPACT HEAVENLY BAMBOO	#1 POT	1.0m O.C.	60	NATIVE SPECIES
	PIERIS JAPONICA 'LITTLE HEATH' LITTLE HEATH PIERIS	#1 POT	1.0m O.C.	76	DROUGHT TOLERANT
	PINUS MUGO VAR. PUMILIO DWARF MUGO PINE	#2 POT	1.2m O.C.	8	DROUGHT TOLERANT
	POLYSTICHUM MUNIUM SWORD FERN	#1 POT	1.0m O.C.	93	DROUGHT TOLERANT
	PRUNUS LAUROCERASUS 'OTTO LUYKEN' DWARF ENGLISH LAUREL	#1 POT	1.0m O.C.	184	NATIVE SPECIES
	RHODODENDRON SSP. 'MIK COLOUR' BLOOM TIME	#5 POT	SEE PLAN	16	DROUGHT TOLERANT
	SPIRAEA JAPONICA 'GOLDMOUND' GOLDMOUND SPIREA	#1 POT	1.2m O.C.	30	DROUGHT TOLERANT
	TAXUS X MEDIA 'H.M. EDDIE' H.M. EDDIE YEW	#2 POT	1.0m O.C.	143	DROUGHT TOLERANT
PERENNIALS, VINES & GROUNDCOVERS					
	CALLUNA VULGARIS 'SPRING TORCH' LAVENDER SCOTCH HEATHER	#1 POT	0.6m O.C.	206	DROUGHT TOLERANT
	ERICA CARNEA 'SPRINGWOOD WHITE' WHITE HEATHER	#1 POT	0.6m O.C.	48	DROUGHT TOLERANT
	FESTUCA GLAUCA 'ELJAH BLUE' ELJAH BLUE FESCUE	#1 POT	0.9m O.C.	25	DROUGHT TOLERANT
	HELICTOTRICHON SEMPERVIRENS BLUE OAT GRASS	#1 POT	0.9m O.C.	25	DROUGHT TOLERANT
	PACHYSANDRA TERMINALIS 'GREEN SHEEN' GREEN SHEEN JAPANESE SPURGE	#1 POT	0.9m O.C.	200	
	PENNISETUM ALOPECUROIDES 'HAAMELI' DWARF FOUNTAIN GRASS	#1 POT	0.75m O.C.	57	DROUGHT TOLERANT
	LAWN	SOD		345 sq.m.	

LAYOUT LEGEND

ABBREVIATIONS	DESCRIPTION
(E) TYP. E PA	EXISTING TYPICAL PROPERTY LINE PLANTING AREA
SYMBOL	DESCRIPTION
	PROPERTY LINE
	BROOM FINISH CONCRETE PAVING
	DECORATIVE PAVING OVER SLAB
	450mm LEAVE STRIP: 38mm MINUS ROUND WASHED RIVER COBBLE OVER LANDSCAPE FABRIC (EXTEND UNDER FRONT BALCONIES)
	RAINGARDEN: 200mm MINUS ROUND WASHED RIVER ROCK OVER LANDSCAPE FABRIC
	BENCH MANUFACTURER: WISHBONE SITE FURNISHINGS (PH: 866-626-0476) STYLE: BAYVIEW BACKLESS WALL TOP BENCH MODEL: B5WBTB-2 FRAME COLOUR: BLACK SLAT COLOUR: WALNUT
	2-STALL BIKE RACK MANUFACTURER: GREENSPOKE BIKE PARKING SOLUTIONS (844-888-9999) STYLE: SINGLE ARCH BIKE RACK MODEL: 850020 COLOUR: BLACK QTY: 8
	RAINGARDEN LANDSCAPE BOULDERS: 0.5m - 1.5m DIA.
	BOLLARD LIGHT REFER TO ELECTRICAL PLANS
	DARK SKY COMPLIANT LED PARKING LOT LIGHT (FULL CUT-OFF, FLAT LENS) REFER TO ELECTRICAL PLANS

IRRIGATION EQUIPMENT LEGEND

SYMBOL	MANUFACTURER	MODEL	DESCRIPTION
	HUNTER	TBD	AUTOMATIC IRRIGATION CONTROLLER IN MECHANICAL ROOM
	HUNTER	WS5-SEN	WIRELESS SOLAR-SYNC SENSOR ON SOUTH-FACING EAVE
	BY CIVIL	BY MECHANICAL	38mm (1.5") DOUBLE CHECK BACKFLOW PREVENTER AND WATER SUPPLY IN MECHANICAL ROOM.
		SCHEDULE 40	38mm (1.5") PVC MANLINE
		SCHEDULE 40	PVC SLEEVES UNDER ALL PAVING AND THROUGH WALLS MIN. TYP (EXACT LOCATION TBD). MANLINE & CONTROL WIRE: 150mm (6") LATERALS: 100mm (4") BURIAL DEPTH TO MATCH DEPTH OF CARRIED PIPE.

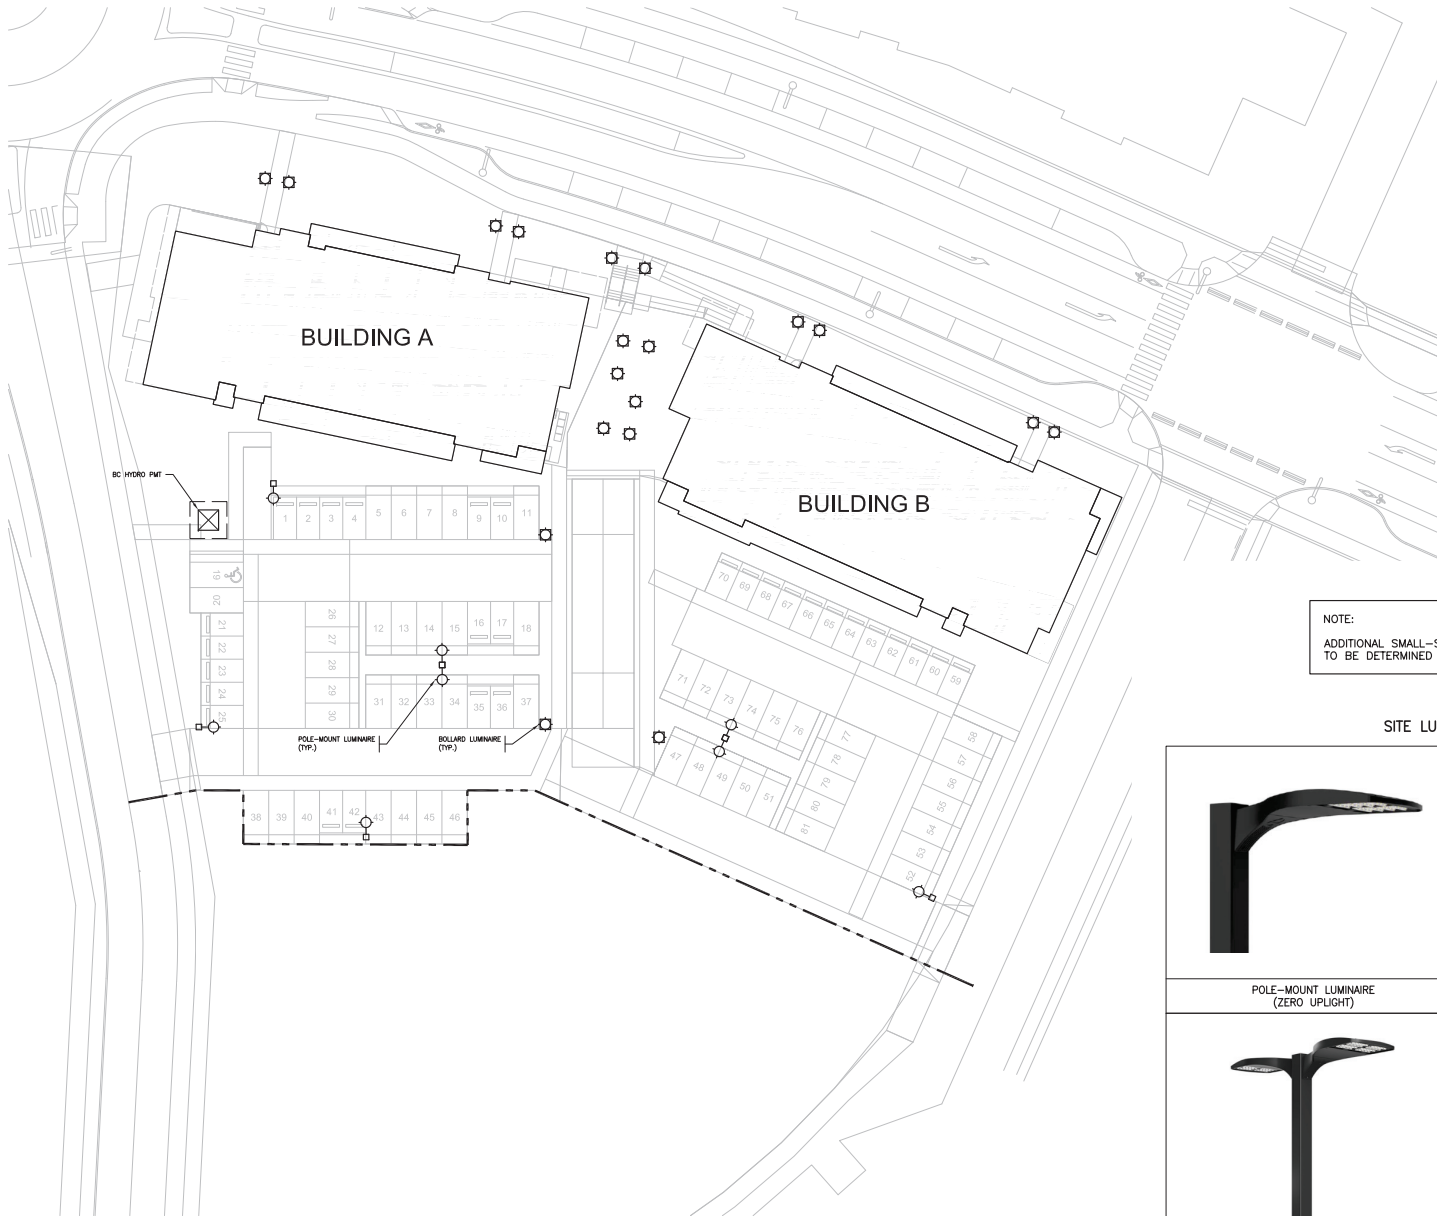

NOTE:
ADDITIONAL SMALL-SCALE BUILDING-MOUNTED LIGHTING
TO BE DETERMINED DURING DETAILED DESIGN.

SITE LUMINAIRE GUIDE

POLE-MOUNT LUMINAIRE (ZERO UPLIGHT)	BOLLARD (ZERO UPLIGHT)
POLE-MOUNT DOUBLE LUMINAIRE (ZERO UPLIGHT)	

1	DEC 13 2024
ISSUED FOR DEVELOPMENT PERMIT	
NO. DATE TITLE	
REVISION	
KB ENGINEERING LTD. <small>TRUSTEES CONSULTING ENGINEERS 41155 NORTHFIELD ROAD TEL: 250-754-4444 NANAIMO, BC V9X 6J1 WWW.KBENGINEERING.CA</small> EGBC PERMIT #1001907 <small>THIS DRAWING IS SOLELY INTENDED TO BE USED FOR THE PURPOSE OF THE DRAWING REVISION TITLE AND SHALL NOT BE USED FOR ANY OTHER PURPOSE.</small>	
CLIENT	
PROJECT	
6045 LINLEY VALLEY DRIVE PHASE 1	
TITLE	
DP SITE PLAN LIGHTING LAYOUT	
PROJECT NO. 24-4889	SEAL
DATE NOVEMBER, 2024	
SCALE 1:250	
DRAWING NO.	
E1.01	

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 Current Planning

Map ID	DBH (cm)	Species (H)
1	50	Douglas Fir
2	50	Douglas Fir
3	80	Douglas Fir
4	100	Douglas Fir
5	110	Douglas Fir
6	70	Douglas Fir
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29	50	Douglas Fir
30		Douglas Fir

Map ID	DBH (cm)	Species (#)
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Map ID	DOB (cm)	Species (#)
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85	60	Douglas Fir
86	65	Douglas Fir
87	60	Douglas Fir
88	60	Douglas Fir
89	60	Cedar
90	55	Douglas Fir
91	60	Douglas Fir
92	55	Douglas Fir
93	45	Douglas Fir

1. PRIOR TO TREE REMOVAL, THE PROJECT ADROBIST¹ IS TO REVIEW ALL TREES NOT BEING REMOVED AND CONFIRM PROTECTIVE FENCING/LOCATION
2. TREES TO BE RETAINED (PHASE 1) = 0
TREES TO BE RETAINED UNTIL PHASE 2 = 33 TREES
TREE DIAMETER AND SPECIES AS PER TREE ASSESSMENT REPORT PREPARED BY
AMP TIMBER RIGGING LTD
3. TREES TO BE REMOVED = 60 + 0 = 60 (Onsite trees + City Trees)
REPLACEMENT TREES REQUIRED = 67* + 0 = 67 (Onsite trees + City Trees)


* AS THE REPLACEMENT NUMBER EXCEEDS THE MAXIMUM NUMBER REQUIRED (100 TREES/A), THE REPLACEMENT REQUIREMENTS MOST LIKELY BE BASED ON THE AREA OF THE PROPERTY (0.67 HA X 100 TREES/A = 67 REPLACEMENT TREES).

4. REPLACEMENT TREES REQUIRED
TOTAL NUMBER OF REPLACEMENT TREES PROPOSED = 48

TREE REPLACEMENT DEFICIT = 67 - 48 = 19

Species	DBH (mm)	Number of trees to be removed	Number of Replacement Trees
Deciduous			
Douglas Fir	0-300	0	0
Douglas Fir	301-500	32	64
Cedar	301-500	0	0
Douglas Fir	>601	28	84
Totals:		60	148

Replacement trees required = 0.67 ha (Phase 1 area) x 100 trees/ha = **67 trees**

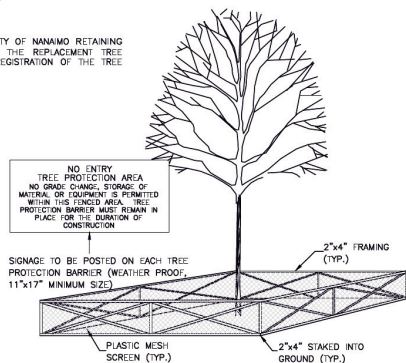

N.T.S.

MINIMUM PROTECTION REQUIRED AROUND TREE	
TRUNK DIAMETER (cm)	DISTANCE FROM TRUNK (m)
20	1.2
25	1.5
30	1.8
35	2.1
40	2.4
45	2.7
50	3.0
55	3.3
60	3.6
75	4.5
90	5.0
100	6.0

NO ENTRY
TREE PROTECTION AREA
NO GRADE CHANGE, STORAGE OF
MATERIAL OR EQUIPMENT IS PERMITTED
WITHIN THIS FENCED AREA. TREE
PROTECTION BARRIER MUST REMAIN IN
PLACE FOR THE DURATION OF
CONSTRUCTION

SIGNAGE TO BE POSTED ON EACH TREE PROTECTION BARRIER (WEATHER PROOF, 11"x17" MINIMUM SIZE)

2 x4 FLOORING
(TYP.)


"x4" STAKED INTO

 TREE TO BE REMOVED

 TREE TO BE RETAINED

AREA OF PROPOSED TREE PROTECTION FENCING

TREES RETAINED UNTIL DEVELOPMENT (PHASE 2)

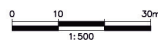

ISSUED FOR PERMIT
PURPOSES ONLY

RECEIVED
DP1373
2025-JAN-14
Current Planning

NOTES:

1. SEE DRAWING 1079-004-100 FOR GENERAL NOTES.
2. THE LOCATIONS OF EXISTING SERVICES ARE SHOWN APPROXIMATELY AND SHALL BE CONFIRMED IN THE FIELD BY THE CONTRACTOR PRIOR TO THE COMMENCEMENT OF WORK. EXISTING & PROPOSED SERVICES MAY REQUIRE ADJUSTMENT WHERE A CONFLICT OCCURS. THE ENGINEER SHALL BE NOTIFIED OF ANY CONFLICT.

[illegible]

NE
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