

29. August. 2024

Project Summary

This project is located at 5730 Turner Road in the heart of North Nanaimo in a COR3 Zone. This zone provides for a regional Community Corridor connecting residential areas to the commercial center with a focus on medium to high density residential with secondary retail and service uses. We are proposing 2 buildings, one 5-storey apartment building and a commercial building. The density of the project requires us to meet Tier 1 requirements.

Site Description

The site is currently undeveloped and provides a great opportunity to introduce a medium to high density residential use and commercial uses to the existing neighbourhood. The site is well serviced by public transit with a direct route to VIU and the downtown core. Although we are seeking height and parking variances, we believe introducing a high-density residential project in this location can contribute to the vibrancy of the neighbourhood because the area has a vast range of existing retail, services, and businesses within a walkable distance to support the project. The site will also offer residents options to use existing transit, bike, and pedestrian infrastructure for needs further away.

This application proposes a Mixed-Use Residential development comprised of two structures, one 5 Storey Apartment with under building parking and a commercial building with offices, a bank, and a cafe. The two buildings are separated by a plaza along Turner Road and a rear surface parking severing both occupancies. The entries for each building are along Turner Road activating the street edges, with the apartment entry off the more residential section of Turner (running north) and the bank and cafe off the plaza to further engage the plaza. The rear surface parking, also accessed off Turner, is flanked with landscape elements to provide visual screening including a large center naturalized area to buffer the building from the rear parking area. Significant landscape elements including a stormwater bioswale animate the streetscape terminating at a retention pond. There is another bioswale behind the commercial space located on the north side of the building both have been used to help with building stormwater management.





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Apartment Description

The Apartment is located on the southeast corner of the site flanking both sections of Turner Road at the roundabout. The building offers 82 rental units with 29% being 2 bed units as well as 1 bed and studio units bringing a variety of rental units to the area. The resident entries have been defined with thick canopy elements over them which also serve to block the sightlines into the units above. These wayfinding elements over the principal entries are intended to provide weather protection and offer a location for building signage. The entry is further defined with a change in material to highlight the entry. For the residential use the main street entry has been placed on the residential section of Turner. The secondary building entry, located on the north side, is used to directly access the rear parking area from the building lobby. The Turner Road frontages are animated with residential decks overlooking the street. The upper storeys utilize building elements that cover the upper decks and the vertical sections separate units giving units deck privacy while also sectioning the building to break up the facade. The other facades are treated with similar building elements and recesses to generate a dynamic interesting massing from all viewpoints around the building. The apartments parking has 37% of the stalls located below the apartment building with access provided off the internal street. The Apartments refuse room is located in the underground parking allowing direct access to the residents without going outside. On the ground floor next to the plaza there is a resident amenity room for use by the residents with direct access to a patio.

Commercial Building Description

The commercial building offers an edge conditions in the West corner of the site. In this location the building acts as a landmark for the Turner and Upland intersection. The commercial space has a large overhang over the entries off the plaza to provide weather protection. The commercial car parking area is in the rear parking lot as close to the building as possible. The garbage and recycling enclosure has been designed to be enclosed behind the commercial building. The plaza along Turner has been placed for use by both buildings with the upper section mainly used by the Cafe and Office. The massing of the building's roof has been raised on the Uplands Drive side of the building to announce its presence on the corner. Along Turner, the facade has glassing to activate the street along the newly upgraded Turner shared walk and bikeway. On the back of the building offices face the Bioswale collecting the roofs stormwater.



29. August. 2024

City of Nanaimo Zoning Bylaw No 4500.

Schedule D - Amenity Requirements for Additional Density

To: Development Approvals Planner.

City of Nanaimo.

Re: Confirmation of Schedule D – Tier 1 Density.

The following is signed confirmation that Turner Road Limited Partnership will carry out the following tasks in order to achieve Schedule D – Tier 1 added density for the proposed development project.

Project: 82 Unit Residential Building.

&

6,400 sf Commercial Building.

Civic Address: 5730 Turner Road, Nanaimo, BC.

Owner Name: Turner Road Limited Partnership

September 5, 2024

Owner / signature: Date:



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In order for a development to include the additional Tier 1 density provided for within City of Nanaimo Zoning Bylaw 4500, the proposed development must achieve sufficient minimum points required in at least three of the categories set out in the following table which allocates points for amenities, affordable housing and the location of the development.

Density Rationale:

The proposed development uses Schedule $D-Tier\ 1$ to gain additional density. The following summary indicates where the proposed development achieves minimum points in at least three of the categories.

Tier 1 Proposed Categories

The proposed development is achieving the points required in the following three categories;

- 1 Site Selection,
- 5 Energy Management,
- 6 Water Management.

Achieving these 3 categories allows for an additional 0.25 FAR on the site required for the proposed density.

Category 1: Site Selection (10 points required)

Amenity B:

The proposed development is on an existing street that does not require any new infrastructure such as storm drains, curbs or sidewalks. Although we are opting to follow the city request to widen the sidewalks and add bike lanes, it is not required to make the site functional.

Total - 3 Points

Amenity C:

The proposed development is within 200m of a park or trail network. Just across the street, 22m away, there is access to the Molecy Creek Park and Walkway.

Total - 1 Point



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Amenity D:

The proposed development is located within 400m of the following amenities allowing for 1 point each:

- Retail store; (5800 Turner Road 58m) 1 Point
- Daycare facility: (6177 Parkwood Dr 330m) 1 Point
- Nanaimo Regional District transit bus stop; (at 5070 Uplands Dr 70m) 1 Point
- A PRC (Parks, Recreation and Culture) Zoned property; (Molecy Creek Park 22m) - 1 Point
- and
- A CS-1 Zone (6021 Nelson Rd 380m) (Community Service One) zoned property. - 1 Point

Total - 5 Points

Amenity E:

The proposed development will add the following amenity on the site, as part of the proposed development:

Retail store or public market; (the project adds a cafe to the area) - 1 Point
 Total - 1 Point

Category 1: Site Selection (10 points required) - 10 points provided.

Category 5: Energy Management (11 points required)

Amenity A:

The proposed development will meet the requirements of Step 3. BCBC Step 3 is one step above the requirement specified in the Nanaimo Building Bylaw. - 10 Points Total - 10 Points

Amenity D:

The development will include permanent education signage or display(s) regarding sustainable energy management practices used onsite to help educate residents and visitors on sustainable design futures used to meet Step 3. - 1 Point

Total - 1 Point

Category 5: Energy Management (11 points required) - 11 points provided.



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Category 6: Water Management (8 points required)

Amenity A:

At least 50% of the property is covered with a permeable surface. To meet this, we have used permeable pavers on the parking stalls in the northern section. This will help the plantings along this edge and is inline with the creek at the base of the site for natural ground water seepage into the creek. - 2 Points

Total - 2 Points

Amenity B:

The proposed buildings on the property will include plumbing features which will use 35% less water than the BC Building Code standard. - 2 Points

Total - 2 Points

Amenity F:

A water efficient irrigation system (such as drip lines) will be installed where watering is required. - 1 Point

Total - 1 Point

Amenity G:

The proposed development includes a few rain gardens with bioswales and storm water retention ponds on the property. These help reduce the roof and parking storm water loads at peak times and passively water the native plants surrounding them. - 2 Points Total - 2 Points

Amenity H:

The development will include permanent educational signage showcasing the sustainable water management practices above used on the project. - 1 Point Total - 1 Point

Category 6: Water Management (8 points required) - 8 points provided.



29. August. 2024

Variance Rationale

As part of this application, it is proposed that Planning and Council consider the following variances for additional allowable height, and Parking stall reduction.

Additional Allowable height


- Permitted height in CC3 Zone: 14.0m (45'-11") from average grade.
- Proposed height of principle buildings: 16.25m (53'-4") from average grade.
- Proposed height variance: 2.25m (8'2").

The rationale for this increase is to allow for 1 additional Storey of residential units in order to take advantage of the allowable density permitted for the site as listed below without increasing the building's footprint.

- Max allowable FAR: 0.75
- Additional density for Under building parking: 0.08
- Additional density for meeting Tier 1 requirements: 0.25
- Total FAR permitted: 1.08
- Total FAR Proposed: .98

The additional height is located on the building along the road away from neighbouring properties. Creating a denser footprint than a 4-storey building of the same FAR and allowing site space for a public plaza along Turner. A shadow study has been provided within the drawing set to show the minimal impact to the adjacent site. There is underbuilding parking with 38% of the apartments parking is under the building. Additionally, we are meeting BCBC Step Code 3 Energy Code and must leave space in the roofing assembly for increased building insulation thickness. Finally, there are architectural details that can reduce the parapet height; however, it is best practice to have details complete with an up stands to mitigate possible water infiltration.


SUBJECT PROPERTY MAP

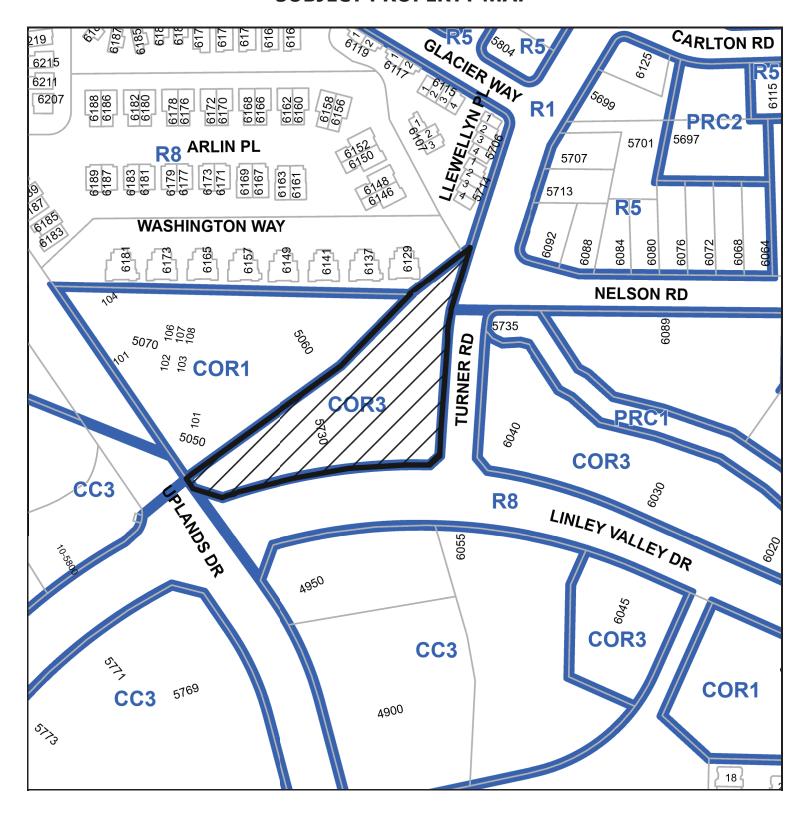






AERIAL PHOTO

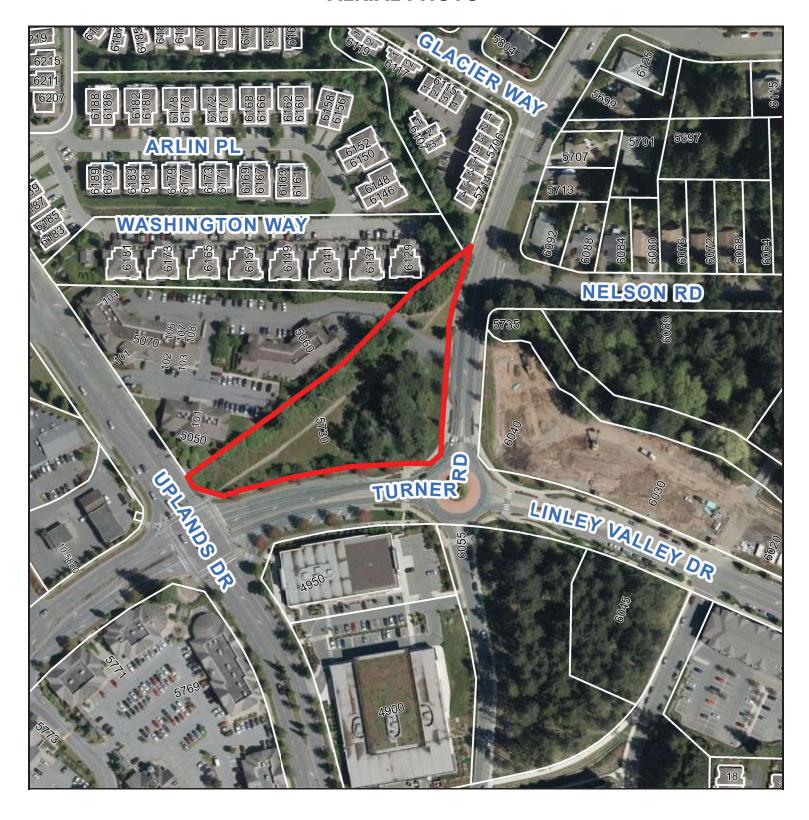





5730 TURNER ROAD

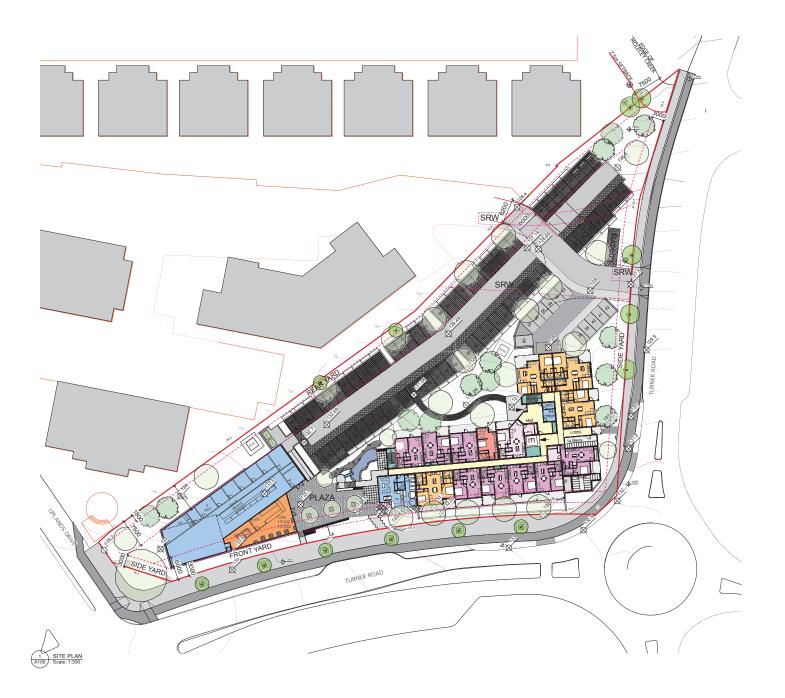



RECEIVED DP1355 2024-SEP-09 Current Planning

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processes	24-08-29	drawing the	Site Plan.vv
drawn by	DRS	sheated by	GT
scale	1:300	project number	240
NOTE: All dim	ensions are shown	in millimeters.	

5730 TURNER

5730 Turner Road Nanaimo BC

Site Plan



dHKarchitects Victoria 977 Fort Street V8V 3K3 Nanaimo 102-5190 Dublin Way V9T 2K8


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PROJECT

5370 TURNER ROAD NANAIMO, BC

ITLE

SITE PLAN LIGHTING LAYOUT


PROJECT NO. 24-4474

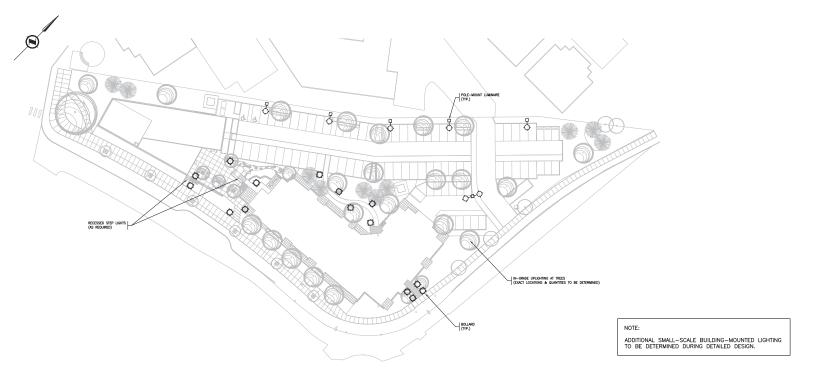DATE
AUGUST, 2024


SCALE
1/32" = 1'-0"

DRAWING N

DP-E1

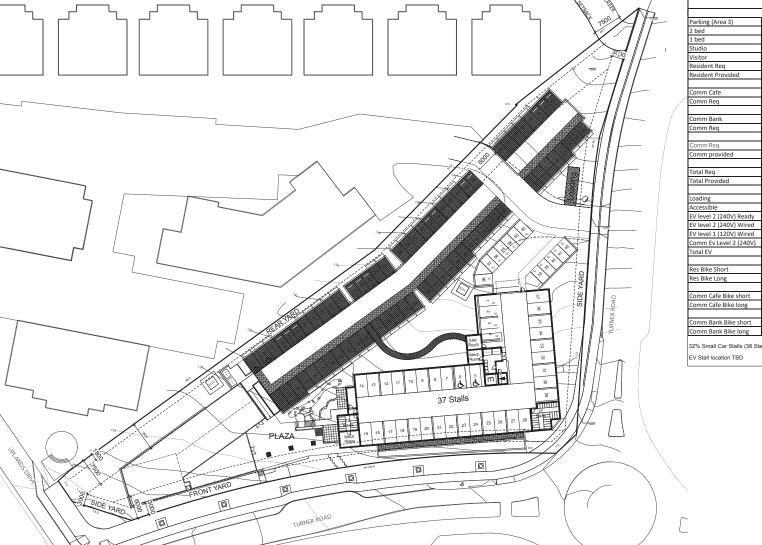

PARKING PLAN A103 Scale: 1:300

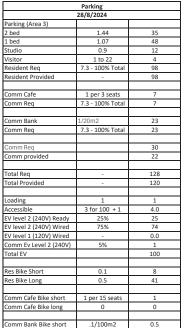

32% Small Car Stalls (38 Stalls noted with "sc")

.35/100m2

1.6

EV Stall location TBD



5730 TURNER

5730 Turner Road Nanaimo BC

Parking Plan



dHKarchitects
Victoria
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LIST OF DRAWINGS

Architec	tural
A001	Cover Page And Project Data.
A002	Neighbourhood Context/Streetscape
A003	Neighbourhood Context/Streetscape
A004	View Analysis
A100	Site Plan.
A101	Grade Plan
A102	Parking Plan
A201	Floor Plans
A301	North and West Elevations - Residential
A302	South and East Elevations - Residential
A303	Elevations - Commercial
A401	Shadow Study
A402	Material Board

5730 Turner Road				
	28/8/2024			
	COR3	Site		
Site area	1000 min	7356		
FAR Total	1.08	0.98		
FAR Base	0.75			
FAR (9.3.2 parking)	0.08			
FAR Tier 1 (meet 3)	0.25	Meet 1, 5, and 6		
FAR - Area	-	7175		
FAR - RES	92%	6580		
FAR - COMM	8%	595		
Lot Coverage	60%	26%		
Storey	-	5		
BLDG Height Res	14m-18m	16.50		
AVG Grade Res	-	131.8		
Units	-	82		
Rear (N)	7.5m	7.5m		
Side Ex (E & W)	3m	3m		
Front (S)	3-6m	3m-6m		
Side In (N/A)	0	NA		



1	24-09-04		ISSUED FOR DP
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processor.	24-09-04	drawing the	Site Plan.vwx
drawn by	DRS	checked by	GTH
scale	1:500	project number	2405
NOTE: All dimen	sions are shown in	millimeters.	

5730 TURNER

5730 Turner Road Nanaimo BC

Cover Page And Project Data







MATERIAL PALETTE

| WERTICAL BOARD AND BATTEN CEMENT PANEL SIDING DARK
| WERTICAL PLANK CEMENT PANEL SIDING LIGHT GREY
| PERFORATE SOFFIT, NO ANK GREY
| PERFORATE SOFFIT WOOD LOK PLANK IN DOUGLAS FIR
| WOOD LOOK PLANK CLADONG, IN DOUGLAS FIR
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FIRST CENTER THAN LIP DESIGN, SMOOTH FIRST, IN WHITE

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FIRST CENTER THAN LIP DANG, SMOOTH FIRST, IN DARK GRAY

VAIV. DECKING LIGHT ORRY TONES

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FASCIA-MOUNTED ALUMINIUM GUARDRAIL AND RAILING, POWDER COATED, BLACK; WITH CLEAR GLASS INFILL VISION PANELS

12 COLUMNS, COLOUR TO MATCH DARK GREY
(3) LOW SLOPED MEMBRANE DECK, IN DARK GREY TONES,

* NOTE: FLASHING TO COLOUR MATCH MATERIALS *NOTE: ILLUSTRATED BUILDING SIGNAGE IS PLACEHOLDER AND IS TO BE CONFIRMED IN A SEPARATE SIGNAGE APPLICATION TO MEET CITY OF NANIMO SIGANGE REQUIRMENTS

ALUMINUM CUTTANWALL SYSTEM, IN BLACK

ALUMINUM STOREFRONT DLAZING, IN BLACK

ALUMINUM STOREFRONT DOORS, IN BLACK

VIEW, SWING GLASS DOOR, IN BLACK

VIEW, SWING GLASS DOOR, IN BLACK

CONCRETE WALL, SACK FINISHED, PAINT SEALED

LIVES OF SERVER MALES MASS COLUMN IN THE SALED

20 LOW SLOPED MEMBRANE ROOF, IN DARK GREY TONES, WITH PARAPET AND CAP FLASHING

21 FASCIA: FIBRE CEMENT PANEL SIDING, WITH ALUMINIUM CAP FLASHING COLOUR TO MATCH FASCIA.

20 SIGNAGE
21 SIGNAGE
22 PLANTERS, REFER TO LANDSCAPE ARCHITECT PACKAGE
23 ELANTOR OVER-RUN
24 ELEVATOR OVER-RUN
25 MECHANICAL ROOM
26 PARKAGE VORHEAD DOOR PICKET STYLE, IN BLACK
27 STEEL DOOR, IN BLACK
27 STEEL DOOR, IN BLACK

2024-SEP-09

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5730 TURNER


5730 Turner Road Nanaimo, BC

North and West Elevations - Residential



| Compared | Compared



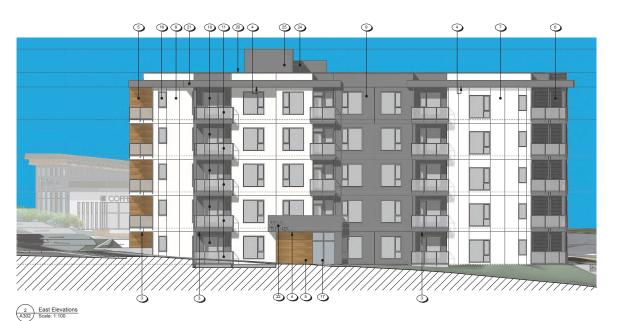

MATERIAL PALETTE 13 ALIMINUM CURTANWALL SYSTEM, IN BLACK (16) ALIMINUM STOREFRONT GUAZNO, IN BLACK (17) ALIMINUM STOREFRONT DOORS, IN BLACK (18) VIVYL SWING GLASS DOOR IN BLACK (18) VINYL WINGOWS, IN BLACK (19) CONCINETE WALL, SACK FINISHED, PARNT SEALED (10) WINGOWS, IN BLACK (10) CONCINETE WALL, SACK FINISHED, PARNT SEALED VERTICAL BOARD AND BATTEN CEMENT PANEL SIDING DARK GREY 2 VERTICAL PLANK CEMENT PANEL SIDING LIGHT GREY 3 PERFORATED SOFFIT, IN DARK GREY 4 PERFORATED SOFFIT WOOD-LOOK PLANK, IN DOUGLAS FIR 5 WOOD-LOOK PLANK CLADDING, IN DOUGLAS FIR WOOD-LOCK FLANK CLADDING, IN DOUGLAS FIR FIRE CEMENT FLANK LAD BINNE, VINCOD GRANF FRIEN, IN DARK DREY. FIRE CEMENT FANK LEDDING, AMOOTH FRIEN, IN WHITE FIRE CEMENT FANK LEDDING, AMOOTH FRIEN, IN LIGHT GRAY. FIRE CEMENT FANK LEDDING, AMOOTH FRIEN, IN LIGHT GRAY. VINT_DECRING, LIGHT GRRY TOMES. LOW SLOPED MEMBRANE ROOF, IN DARK GREY TONES, WITH PARAPET AND CAP FLASHING 21 FASCIA: FIBRE CEMENT PANEL SIDING, WITH ALUMINIUM CAP FLASHING COLOUR TO MATCH FASCIA. CAP FLASHING COLOUR TO MATCH PASCIA. A. SIGNAGE DIAMTERS, REFER TO LANDSCAPE ARCHITECT LEWATOR OVER FILIN MECHANICAL ROOM PARKAGE OVERHEAD DOOR, PICKET STYLE, IN STEEL DOOR, IN BLACK TEEL DOOR, IN BLACK FASCIA-MOUNTED ALUMINIUM GUARDRAIL AND RAILING, POWDER COATED, BLACK; WITH CLEAR GLASS INFILL VISION PANELS 12 COLUMNS, COLOUR TO MATCH DARK GREY 13 LOW SLOPED MEMBRANE DECK, IN DARK GREY TONES, PARKADE OVERHEAD DOOR, PICKET STYLE, IN BLACK * NOTE: FLASHING TO COLOUR MATCH MATERIALS * NOTE: ILLUSTRATED BUILDING SIGNAGE IS PLACEHOLDER AND IS TO BE CONFIRMED IN A SEPARATE SIGNAGE APPLICATION TO MEET CITY OF NANIMO SIGANGE REQUIRMENTS

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South and East Elevations - Residential



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5730 TURNER

5730 Turner Road Nanaimo, BC

Elevations - Commercial



MATERIAL PALETTE

VERTICAL BOARD AND BATTEN CEMENT PANEL SIDING DARK
GREY

2 VERTICAL PLANK CEMENT PANEL SIDING LIGHT GREY
3 PERFORATED SOFFIT, IN DARK GREY
4 PERFORATED SOFFIT WOOD-LOOK PLANK, IN DOUGLAS FIR
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| WAYL DECKING, LIGHT GREY TONES
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44. ALUMINIUM CURTAINWALL SYSTEM, IN BLACK
(15) ALUMINIUM STOREFRONT GOADNO, IN BLACK
(16) ALUMINIUM STOREFRONT DOORS, IN BLACK
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(18) VWYL, VWNDOWS, IN BLACK
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10 NO GORDETE WALL, SACK FINISHED, PAINT SEALED

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20 LOW SLOPED MEMBRANE ROOF, IN DARK GREY TONES, WITH PARAPET AND CAP FLASHING 21 FASCIA: FIBRE CEMENT PANEL SIDING, WITH ALUMINIUM CAP FLASHING COLOUR TO MATCH FASCIA.

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SIGNAGE

PLANTERS REFER TO LANDSCAPE ARCHITECT PAGAGE

ELEVATOR OVER-RUN

MECHANICAL ROOM

PARAMETER OVERHEAD BOOR PICKET STYLE; IN BLACK

STEEL DOOR, IN BLACK

THE PAGE TO THE PAGE TO

11 FASCIA-MOUNTED ALUMINIUM GUARDRAIL AND RAILING, POWDER COATED, BLACK; WITH CLEAR GLASS INFILL VISION PANELS

12 COLUMNS, COLOUR TO MATCH DARK GREY
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 FREE CEMENT PANK, SONG, SOOTH FRIER, IN LIGHT GRAY
 FREE CEMENT PANK, SONG, SOOTH FRIER, IN DARK GRAY
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| FASCIA-MOUNTED ALUMINIUM GUARDRAIL AND RAILING, POWDER COATED, BLACK; WITH CLEAR GLASS INFILL VISION PANELS

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4. ALUMINUM CURTANWALL SYSTEM, IN BLACK
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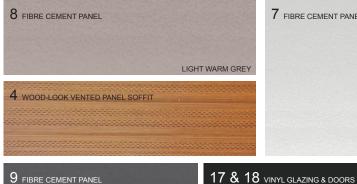
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5730 TURNER 5730 Turner Road Nanaimo, BC

Material Board



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View From Uplands And Turner



View Of Plaza And Commercial Entry



View From Turner Heading South



View From Uplands Heading North





View From Commercial Parking Entry


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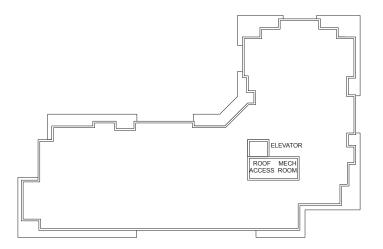
5730 TURNER 5730 Turner Road Nanaimo, BC

View Analysis









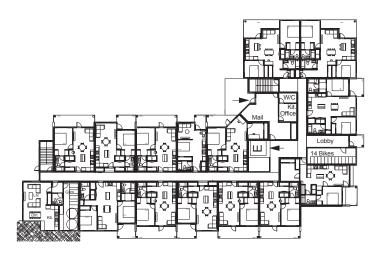



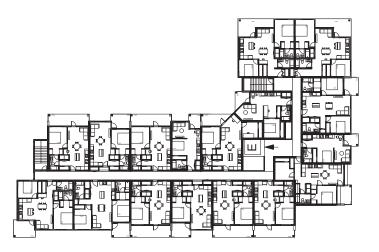

2ND -5TH FLOOR PLAN Scale: 1:200

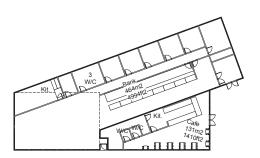





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5730 TURNER

5730 Turner Road Nanaimo BC

Floor Plans



dHKarchitects
Victoria
977 Fort Street V8V 3K3
17 1-250-658-3367
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U55 190 July 190 T 2K8
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U55 190 July 190 T 2K8
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DRAWING LIST

L000 Cover Page L100 Landscape Site Plan 1/32" = 1'- 0" L101.1 Material and Grading Plan Ground Level West L101.2 Material and Grading Plan Ground Level East 1/16" = 1'- 0" L201 Sections AS SHOWN L301 Details AS SHOWN

LANDSCAPE NOTES

- All work shall meet or exceed the requirements as outlined in the current Edition of the Canadian Landscape Standard.
- Plant sizes and related container classes are specified according to the Canadian Landscape Standard current Edition. For container classes #3 and smaller, plant sizes shall be as shown in the plant list and the Standard; for all other plants, both plant size and container class shall be as shown in the plant list. Specifically, when the plant list call for #5 class containers, these shall be as defined in the CNAL (ANSI) Standard.
- Area of search for specified plant material shall include the Lower Mainland of British Columbia, Vancouver Island, Washington and Oregon States.
- 4. All plant material used on this project shall be hardy in this climate. Plant types have been selected with his as a primary crienta. This Contractor shall guarantee that plant material supplied has equal provenance, ie: it is developed from cuttings or seeds collected in an area of similar climatic characteristics.
- Substitutions in plant material will not be considered unless written proof is submitted thirty (30) days prior to scheduled installation stating a specified plant cannot be obtained within the specified area of search.
- 6. All trees to be staked in accordance with CNLA Standards.
- 7. For all existing on site services and survey symbols refer to survey drawings.
- 8. All landscaping and treatment of the open portions of the site shall be completed in accordance with the approved drawings within six (6) months of the date of issuance of any required occupancy permit, or any use or occupancy of the proposed development not requiring an occupancy permit, and thereafter permanently maintained in good conditions.

OFF-SITE PLANTING NOTES

- 1. Street tree final spacing and quantity to the approval of City of Nanaimo Engineering.
- Street tree final species to the approval of City of Nanaimo Parks, Recreation and Culture Department
- Approved root barrier to be installed per City of Nanaimo standard, 8' (2.4m) long and 18" (450mm) deep.

ADDITIONAL NOTES

- 1. All sidewalks between curb and property line are to be reconstructed fully at the applicant's
- 2. This plan is NOT FOR CONSTRUCTION and is to be submitted for review to Enigineering Services a minimum of 8 weeks prior to the start of any construction proposed for public property. No work on public property may begin until such plans receive "For Construction' approval and related permits are issued. Please contact Engineering Development Services and or your Engineering Disting Site Inspector for details.
- 3. Final spacing, quantity and tree species to the satisfaction of the General Manager of Engineering Services. New trees must be of good standard, installed with approved root barriers and appropriate soil. Foot barriers shall be of rigid construction. 8 teet long and 18 inches in depth. Planting depth of root bail must be below sidewalk grade. Call Parks, Recreation and Culture Department for inspection after tree planting completition.

IRRIGATION NOTES

- All on-site 'Soft Landscape Areas' are to be irrigated with high-efficiency automatic irrigation systems, including rain sensors, to IIABC Standards.
- Irrigation stub-outs and hose bib locations will be provided to mechanical and electrical consultants for coordination.
- Irrigation system is a deign-build. Landscape contractor to provide irrigation design/layout for review by Landscape Consultant for approval.
- 4. No visible irrigation lines will be accepted.
- 5. All irrigation boxes to be equipped with quick couplers.
- 6. Irrigation controller to be located in mechanical room.

SOFT LANDSCAPE

Legend

Description

ORNAMENTAL PLANTING NATIVE OR ADAPTIVE

NATURALIZED PLANTING

LAWN AREA

PROPOSED DECIDUOUS TREE



PROPOSED CONIFEROUS TREE



EXISTING TREES TO BE REMAINED

HARD LANDSCAPE

Legend

Description

CIP CONCRETE SIDEWALK Pedestrian only - to CoN Engineering Standard CIP CONCRETE PAVING



HYDRAPRESSED SLABS







GRAVEL Type: 1"-2" Rounded River Rock





ASPHALT - REFER TO CIVIL



BIKE LANE PAVING ASPHALT - REFER TO CIVIL PERMEABLE PAVING PERMEABLE PAVERS



FURNISHING + STRUCTURE

Leaend

Description





WOOD TIMBER BENCH Cedar Wood



PLANT LIST

TREES				
SYMBOL	QTY	BOTANICAL NAME	COMMON NAME	SIZE / SPACING
\odot	4	Acer ruburm 'Red Sunset'	Red Sunset Red Maple	6 cm cal. B+B
0	2	Acer rubrum 'October Glory'	October Glory Red Maple	6 cm cal. B+B
	9	Alnus rubra	Red Alder	6 cm cal. B+B
\odot	3	Cercis canadensis	Eastern Redbud	6 cm cal. B+B
O'	4	Chamaecyparis nootkatensis	yellow cedar	2 mht. B+B
	3	Cornus 'Eddie's White Wonder'	Eddie's White Wonder Dogwood	6 cm cal. B+B
	1	Cornus controversa	Giant Dogwood	5 cm cal. B+B
	3	Cornus nuttallii	Pacific dogwood	5 cm cal. B+B
	2	Magnolia stellata	star magnolia	7 cm cal. B+B
*	9	Psedotsuga menziesii	Douglas fir	2 mht. B+B
	1	Quercus garryana	Oregon white oak	8 cm cal. B+B

SHRUBS				
SYMBOL	QTY	BOTANICAL NAME	COMMON NAME	SIZE / SPACING
Ao	128	Arbutus unedo	Compact Strawberry Bush	#3 pot / 48" O.C.
Ad	13	Arcunus diocius	Goat's Beard	#2 pot / 36" O.C.
Bm	320	Buxus microphylla 'Green Beauty'	Littleleaf Boxwood	#2 pot / 24" O.C.
Cvs	91	Ceanothus velutinus	Snowbrush	#3 pot / 48" O.C.
Fg	120	Fothegilla gardenii	Fothegilla gardenii	#2 pot / 24" O.C.
Hd	18	Holodiscus discolor	Ocean Spray	#2 pot / 48" O.C.
На	26	Hydrangea arborescens	Anabel hydrangea	#2 pot / 24" O.C.
KI	318	Kalmia latifolia 'Alba'	Mountain Laurel	#2 pot / 24" o.c.
Lg	18	Ledum groenlandicum	Bog Labrador Tea Plant	#3 pot / 48" O.C.
Mc	4	Morella californica	Pacific Wax Myrtle	#5 pot / 72" o.c.
My	51	Myrica gale	Sweetgale	#4 pot / 48" O.C.
Rh	202	Rhododendron	Rhododendron	#2 pot / 36" O.C.
Rm	64	Rhododendron macrophyllum	Pacific Rhododendron	#3 pot / 48" o.c.
Rn	208	Rosa nutkana	Nootka Rose	#2 pot / 24" O.C.
Rw	40	Rosa White Meidiland	Groundcove Rose	#2 pot / 24" o.c.
Su	92	Salix purpurea 'Nana'	Dwarf Arctic Blue Leaf Willow	#3 pot / 48" O.C.
Sb	64	Spirea betufolia	Birch-leaf Spirea	#2 pot / 36" O.C.

GROUNDCOVERS, GRASSES, FERNS & VINES

SYMBOL	QTY	BOTANICAL NAME	COMMON NAME	SIZE / SPACING
ai	39	Achillea millefolium	Common Yarrow	#2 pot / 10" O.C.
Ci	98	Calluna vulgaris 'Aurea'	Aurea Heather	#1 Pot / 16" O.C.
cm	274	Cassiope mertensiana	White Mountain Heather	#2 pot / 18" O.C.
Ed	70	Erica x darleyeyensis 'Mediterranean white'	Heath	#1 pot / 24" O.C.
ir	328	Iris missouriensis	Rocy Mountain Iris	#1 pot / 12" O.C.
je	371	Juncus effusus	Rush or Sedge	#1 pot / 12" O.C.
jw	316	Juniperus horizontalis 'Wiltonii'	Blue Rug Juniper	#2 pot / 24" O.C.
KI	2	Kalmia latifolia 'Alba'	Mountain Laurel	#2 pot / 24" o.c.
Lb	32	Lavandula angustifolia 'Blue Cushion'	Blue Cushion Lavender	#2 pot / 24" O.C.
lm	680	Liriope muscari	Big Blue Lily Turf	#1 pot / 18" O.C.
pa1	36	Pennisetum alopecuroides 'Hameln'	Dwarf Fountain Grass	#2 pot / 30" O.C.
pm	662	Polystichum mumtium	sword Fern	#3 pot / 24" O.C.
tc	173	Thymus x citriodorus	Lemon Thyme	#2 pot / 12" O.C.

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2 2024-08-22 ISSUED FOR DP RESUBMISSION 1 2023-10-18 ISSUED FOR DP

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DISTRICT

Revisions

Stamp:

TURNER ROAD

5730 TURNER ROAD, NANAIMO, BC

DC Drawn by: Checked by: nc Date: AUG 27 2024

Cover Page

Drawing Title:

Project No. 23034 Sheet No.

L000





NATIVE PLANTINGS













RAIN GARDENS LOWER LEVELS PATIO SEATING

2024-08-22 ISSUED FOR DP RESUBMISSION 1 2023-10-18 ISSUED FOR DP

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TURNER ROAD

5730 TURNER ROAD, NANAIMO, BC

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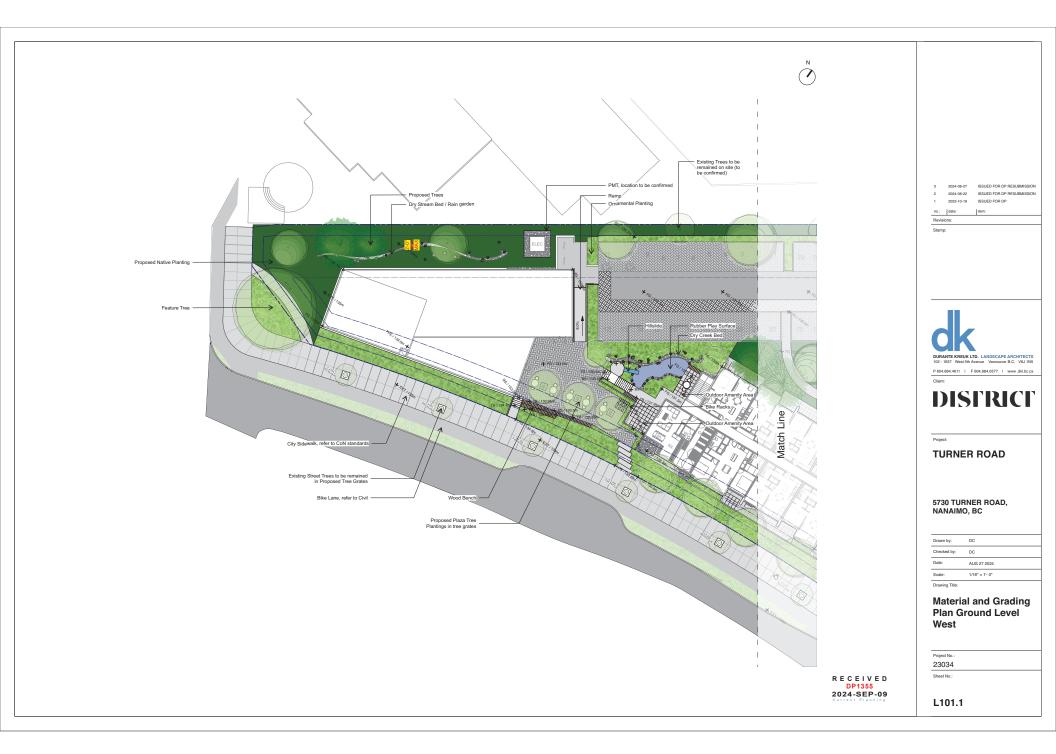
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Landscape Site Plan


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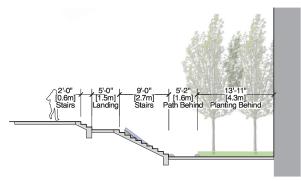
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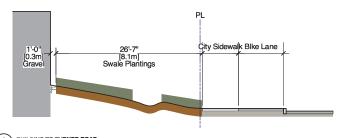






2 PLAZA TO LOWER AMENITY SPACE
L201 Scale = 3/16" = 1'-0"

Bike Lane City Sidewalk 13'-2" Plaza [4m] Path Path Sale=316' = 1'0"

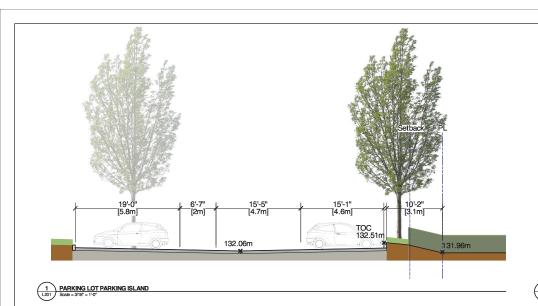

4 BUILDING TO TURNER ROAD
L201 Scale = 3/16" = 1'-0"

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3	2024-08-27	ISSUED FOR DP RESUBINISSION
2	2024-08-22	ISSUED FOR DP RESUBMISSION
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DISTRICT

Project:

TURNER ROAD

5730 TURNER ROAD, NANAIMO, BC

Drawn by:	DC
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Date:	AUG 27 2024
Scale:	AS SHOWN

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Sections

Project No.: 23034

Sheet No.:

