2103 Bowen Apartments | DESIGN RATIONALE /PROJECT DESCRIPTION

November 12, 2021

This 3-story multi-family development has been designed to increase density along one of Nanaimo's primary transportation corridors on Bowen Road. The building consists of 41 total units with a combination of 36 studios and 5 two-bedroom units. The underground parking structure below the building accommodates sufficient parking with access from the rear lane off Meredith Road. This development also offers a large roof top deck amenity for residents to enjoy spectacular views of Mount Benson. Here, a larger number of studio units have been proposed with the intension of making good use of transit and pedestrian facilities along Bowen Road.

• Site & Landscape

- o The main building mass is set along Bowen Road with street access for the ground floor units and a main entrance at the corner of Bowen and Meredith.
- Parking has been provided with a parking structure set into the slope and a small surface parking area accessed from the lane off Meredith Road.
- Landscaping is provided along the edges of the building and integrated with the site slope.
- A roof deck outdoor amenity has been provided on the 4th level as a communal outdoor space.

Building Massing

- o The building is three stories with a roof deck to add additional outdoor space.
- The main entrance has a prominent location at the corner of Bowen and Meredith Road
- o The tall elevator mass acts as an identifying marker with the building's name.
- Individual entries are identified to ground floor units across Bowen Road, giving the building a more residential feel.

Architectural Elements

- A "wrapping wall" feature is used as the main organizing feature for the architectural elevation along Bowen Road. From a functional perspective this wall is creating a divide between the adjacent unit balconies. From an aesthetic perspective the wall provides movement, interest, and scale to the elevation.
- o The wall breaks the long façade into smaller proportions
- Material and colour changes have been used to emphasize where the wall is wrapping.
- The design utilizes multiple flat roofs at varying heights with the idea of creating interest and scale.
- The elevation along Meredith uses a similar more stagnate architectural language but is still cohesive with Bowen Road.



Variances Requested

Setback

- Variance requested if for the front minimum setback for 0.5 m. (Provided 3m; required 3.5 m).
- Variance requested if for the flanking side yard setback for 0.5 m. (Provided 4m; required 4.5 m).

<u>Rational:</u> Some of the covered balconies project into the front minimum setback up to maximum of 0.5 m. This setback variance enables us to efficiently position the building to achieve a balance between unit dimensions and parking requirements. Additionally, the building projects 0.5 m into the flanking side yard setback. Again, this small corner projection into the setback enables us to achieve the required density with maximum efficiency. In the same south-west corner of the building, we have an open balcony projecting 1.44 m into the flanking side yard setback. As we understand from section 6.5 of the 4500-zoning bylaw, there is an allowable projection in the yard for open decks up to a 2 m limit.

Trash Location

Variance of 3 m requested for the trash located at the rear of the property (northwest corner), abutting the lane.

<u>Rational:</u> While trying to find a balance between density and parking on an irregularly shaped lot, we were able to optimise the usability of the site by locating the trash container at the rear of the property, near the lane. We also propose that the trash container directly face the lane as it might make it easer for trash collection and management.

Parking

- Parking Variance requested for 1 car space
 - Requirement: 40 spaces
 - Provided: 39 spaces
- Small car variance requested for 11 cars
 - Requirement std: sm car 60:40
 - Provided 49: 51

<u>Rational:</u> We were able to fit 39 cars and are requesting for a 1 car variance to accommodate the 41 units on this uniquely shaped lot. As 36 of the 41 units are studio units, we feel that many of the residents of this building could potentially use the transit facilities available on Bowen Road. Furthermore, small car spaces might be a better fit for the larger number of studio units proposed in this building.

Height

- o A height variance of 0.95 m is being requested
 - Required 14 m
 - Provided 14.95 m


<u>Rationale:</u> The additional height being requested is for the headroom of the staircase leading to the roof deck amenity space. We feel that is this common outdoor space can potentially provide a lot of value for the residents with great views of Mount Benson.

Retaining Wall Height

- o A retaining wall variance of 0.65 m is being requested
 - Allowed 1.8 m
 - Provided 2.45 m


Rationale: The only section where we require this variance is at the north-west corner of the lot, where we transition the natural slope from Bowen to Meredith Road. This enables us the have access to the parking from the rear lane off Meredith while maintain access to the ground floor units directly from Bowen Road.

CONTEXT MAP

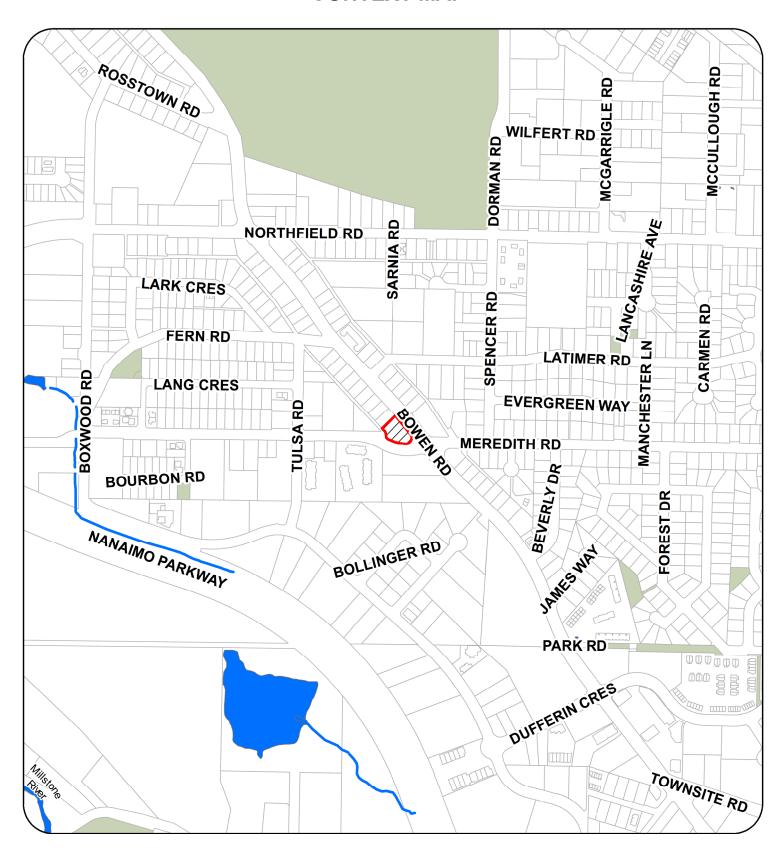



LOCATION PLAN

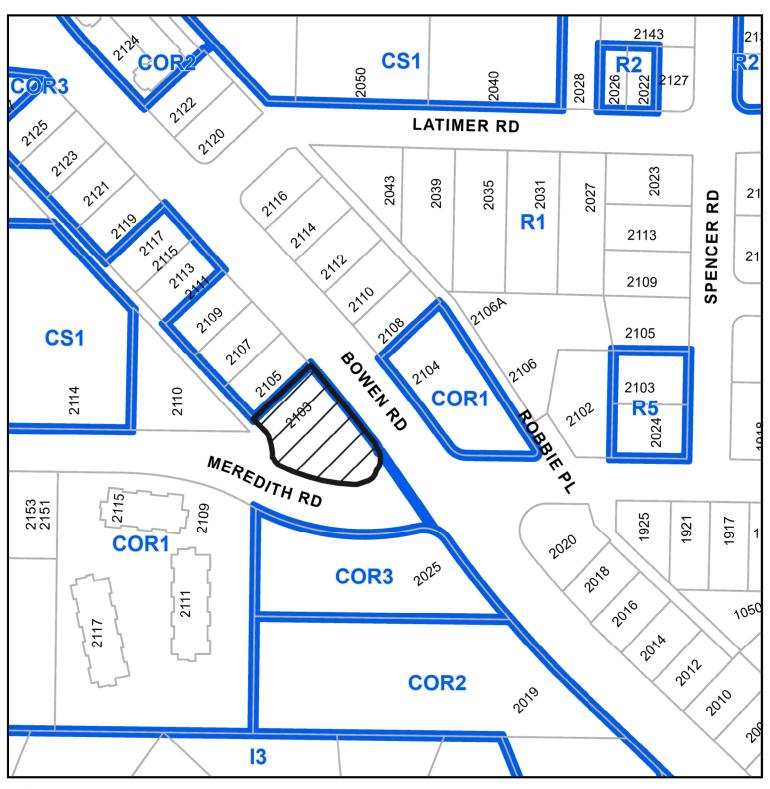



DEVELOPMENT PERMIT APPLICATION NO. DP001253

Subject Property

CIVIC: 2103 BOWEN ROAD

LEGAL: LOT 1, SECTION 16 AND 17, BLOCK 1, RANGE 7, MOUNTAIN

DISTRICT, PLAN EPP23735







JOYCE REID TROOST ARCHITECTURE

250.714.8749

BOWEN APTS.

RECEIVED
DP1253
2021-NOV-15

CAMARGUE PROPERTIES INC.


tEV. DATE NUMBER

NOV 12, 2021 SEE DRAWING

A000

COVER SHEET

2103 BOWEN ROAD, NANAIMO, BC

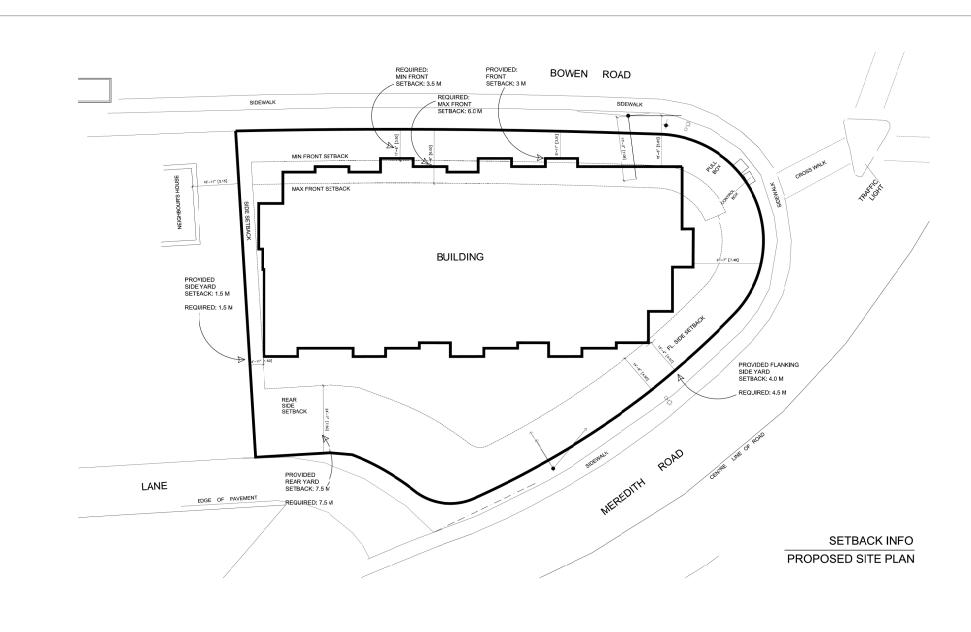








RECEIVED DP1253 2021-NOV-15

ITENI	
CAMARGUE PROPERTIES INC.	

REV. DATE	NUMBER	DESCRIPTION	_
			_
			_
			-
			-

DATE NOV 12, 2021 SCALE	SETBACKS INFO
DRAWN BY JRT	A101

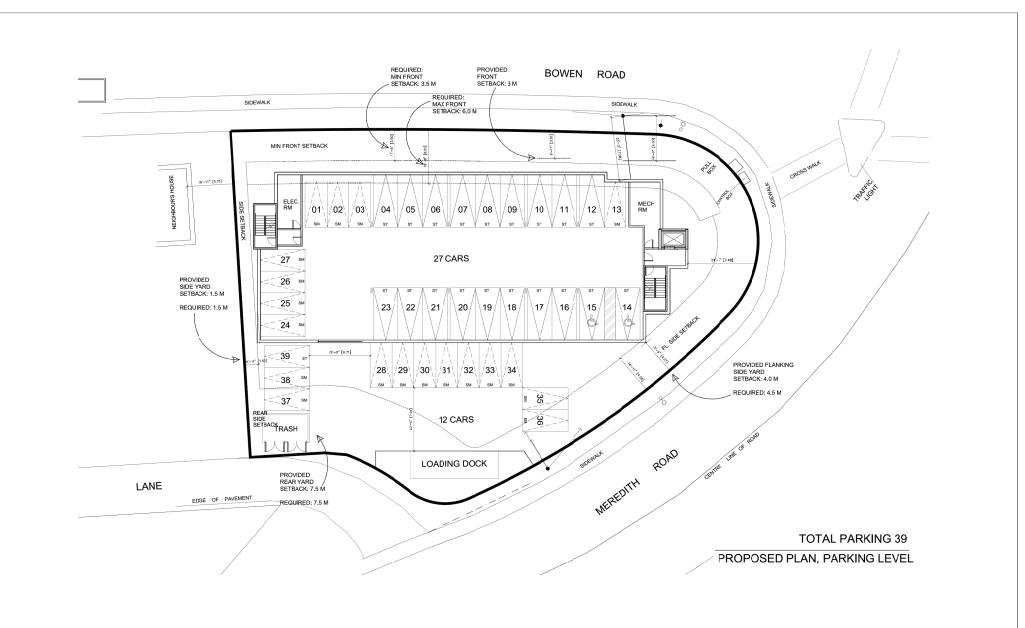





RCH. STAMP

BOWEN APTS. 2103 BOWEN ROAD NANAIMO, BC CAMARGUE PROPERTIES INC.

R E C E I V E D

DP 1253
2021-NOV-15

REV. DATE	NUMBER	DESCRIPTION

ALE NOV 12, 2021 PARKING LEVEL

A 100

MATERIAL LEGEND

(1) HARDIE Arctic W

02

HARDIE lap siding, Pearl Grey

HARDIE panel, Iron Grey

HARDIE panel Dulux, Prussian Bue

Ga Co Me Tex Ce

Galvanised Corrugated Metal Sheet / Textured Fibre Cement Board



FRONT ELEVATION FROM BOWEN ROAD (WEST)



BACK ELEVATION FROM MEREDITH ROAD (EAST)



THE FRANKIOL DESIGN DEAS AND TRANSPORT OF CONSTRUCTION DEPOTED HERBIN ARE THE DECLUSE FRODERY OF THE PROPERTY OF THE PROPERTY



BOWEN APTS. 2103 BOWEN ROAD, NANAIMO, BC



CAMARGUE PROPERTIES INC.

EEV. DATE NUMBER DESCRIPTION	DATE	NOV 12, 2021	55,070
	SCALE	SEE DRAWING	ELEVATION
			1 00
			$\mid AZ($
	DRAWN BY	JRT	1

MATERIAL LEGEND




02 HARDIE lap siding, Pearl Grey

HARDIE panel, Iron Grey

HARDIE panel Dulux, Prussian Bue

Galvanised Corrugated Metal Sheet / Textured Fibre Cement Board

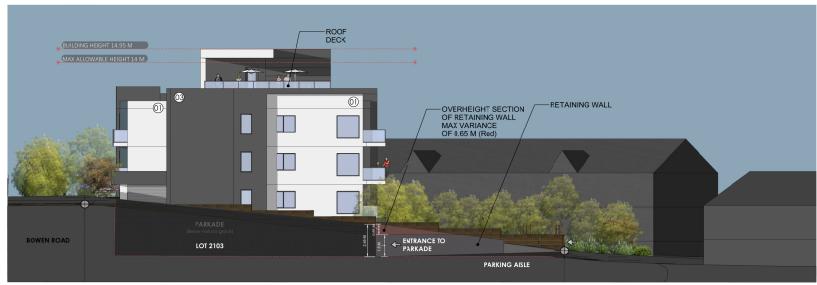

SIDE ELEVATION (NORTH)



SIDE ELEVATION (SOUTH)



JOYCE REID TROOST ARCHITECTURE

2515 GLENAYR DRIVE NANAIMO, BC V9S 3R9

250.714.8749

BOWEN APTS.

2103 BOWEN ROAD, NANAIMO, BC

RECEIVED
DP1253
2021-NOV-15

CAMARGUE PROPERTIES I

tev. Date	NUMBER	DESCRIPTION	
	1		

NOV 12, 2021 ELEVATIONS 2 SCALE SEE DRAWING A201



PERSPECTIVE FROM BOWEN- MEREDITH INTERSECTION



PERSPECTIVE FROM BOWEN ROAD



PERSPECTIVE FROM THE LANE



PERSPECTIVE FROM MEREDITH ROAD



JOYCE REID TROOST ARCHITECTURE

2515 GLENAYR DRIVE

joyce@jrtarchitecture.com 250.714.8749

irtarahitaatura aam

E DRAWNSS, DESCRI DEAS AND AMBRES OF CONSTRUCTOR DESCRIPTION DEPOTED BEING ARE HE EXCLUSIVE PROVERTY OF PACIFIC HE DISCOLAR ACHIRICA, ALI MISTORI DE PROVINCIA DE PROVINCIA DE PRESENCIA, THEY ARE INCR. BE DISCOLAR DE PRESENCIA, THEY ARE INCR. BE ASSIGNED TO A HIDO PARTY DE ASSIGNED TO A HIDO PARTY DE ASSIGNED TO A HIDO PARTY DE PARTY D

ERED ARCHITECTURE

BOWEN APTS. 2103 BOWEN ROAD, NANAIMO, BC

RECEIVED
DP 1253
2021-NOV-15
Current Planning

CAMARGUE PROPERTIES INC.

TEV. DATE NUMBER DESCRIPTION

DATE NOV 12, 2021

SCALE SEE DRAWING

PERSPECTIVES 1

A300



TOP PERSPECTIVE OF BOWEN- MEREDITH INTERSECTION



TOP PERSPECTIVE BACK OF BUILDING



ROOF DECK COMMON AMENITY SPACE



AERIAL PERSPECTIVE OF SITE



JOYCE REID TROOST ARCHITECTURE

BOWEN APTS.

2103 BOWEN ROAD, NANAIMO, BC

RECEIVED
DP1253
2021-NOV-15
Cuirent Planning


CAMARGUE PROPERTIES IN

	tev. DATE	NUMBER	DESCRIPTI
NC.			
140.			

NOV 12, 2021 SEE DRAWING

A301

PERSFECTIVES 2

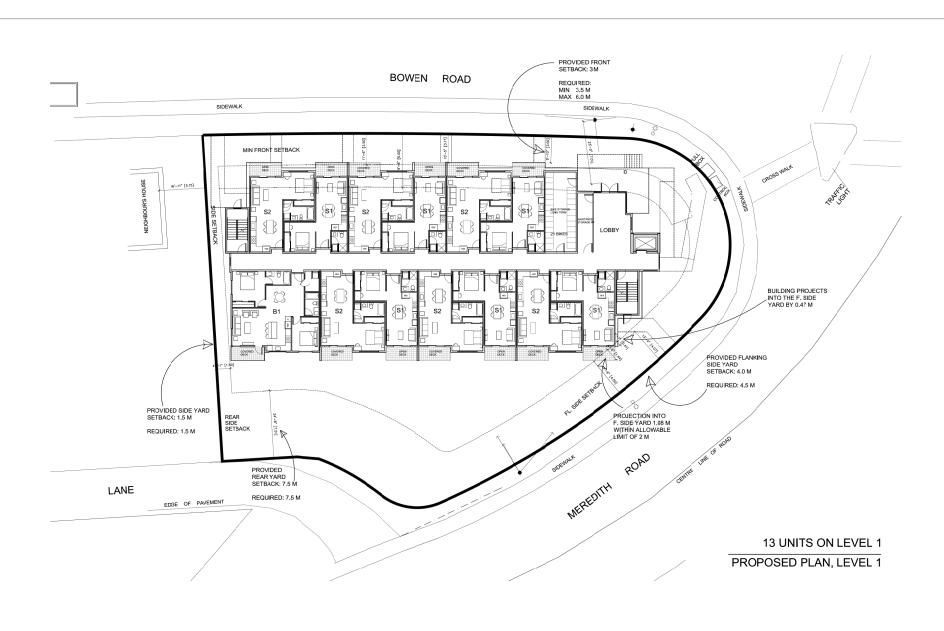






RECEIVED DP1253 2021-NOV-15

CLIENT

	REV. DATE
	1
RGUE PROPERTIES INC.	
TOOL THOT ENTED INTO:	
	I

DESCRIPTION	DATE
	SCALE
	DRAWN BY

NOV 12, 2021 LEVEL 1
A 102

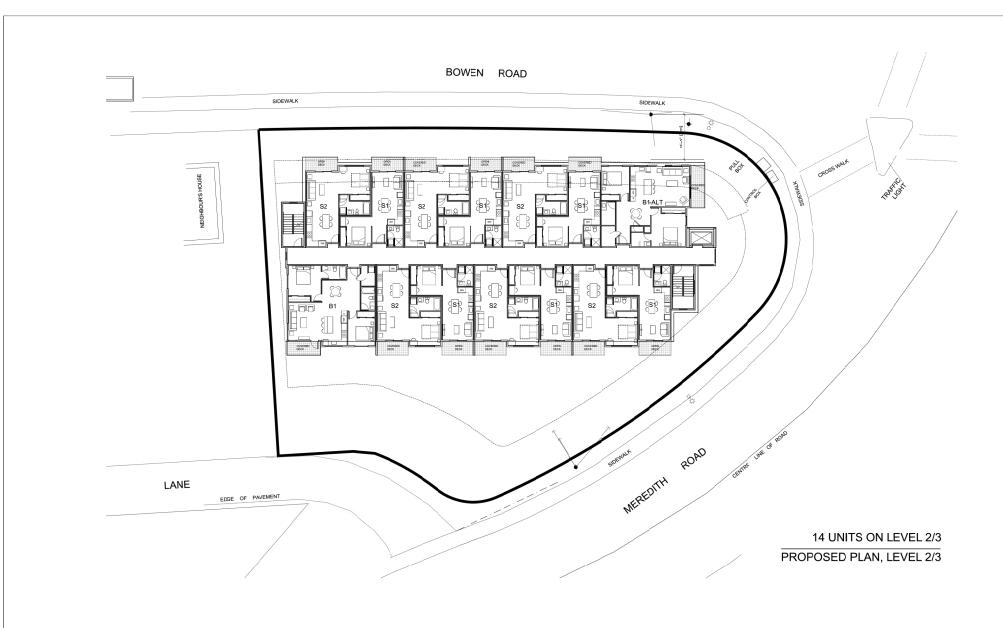








RECEIVED
DP1253
2021-NOV-15
Carrent Plans no

CLIENT
CAMARGUE PROPERTIES INC.

REV. DATE	NUMBER	DESCRIPTION	_
			- 1
	_		-
	_		-
			Ξ.
			- 1

DATE N	OV 12, 2021	LEVEL 2 & 3
SCALE		
		A103
DRAWN BY	IPT	

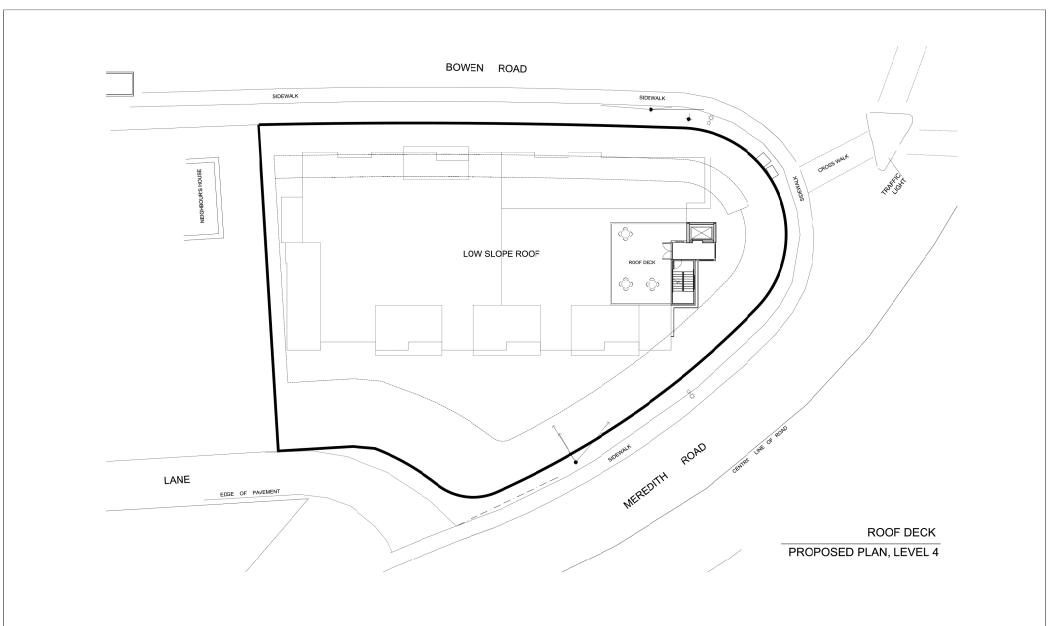







RECEIVED
DP1253
2021-NOV-15

CAMARGUE PROPERTIES INC.
CAMARGUE PROPERTIES INC.

REV. DATE	NUMBER	DESCRIPTION	1
]
			1 +
]
			1
			1
			1
			1
			1 .
			1 [

DATE NOV 12, 2021	ROOF LEVEL
	A104



S1 & S2 UNIT

S1; 458 SF +58 SF DECK; 18 UNITS S2; 552 SF +58 SF DECK; 18 UNITS





BOWEN APTS. 2103 BOWEN ROAD NANAIMO, BC



JENI	
CAMARGUE PROPERTIES INC.	

REV. DATE	NUMBER	DESCRIPTION

DATE NOV 12, 2021 SCALE	UNIT PLANS 1
DRAWN BY JRT	A105





B1- ALT UNIT

B1; 955 SF + 77 SF DECK; 2 UNITS

B1 UNIT

B1; 943 SF + 61 SF DECK; 3 UNITS






BOWEN APTS. 2103 BOWEN ROAD NANAIMO, BC

	CAMARGUE PROPERTIES
RECEIVED DP1253 2021-NOV-15	

CLIENT

REV. DATE	NUMBER	DESCRIPTION

DATE NOV 12, 2021 SCALE	UNIT PLANS 2
	A106

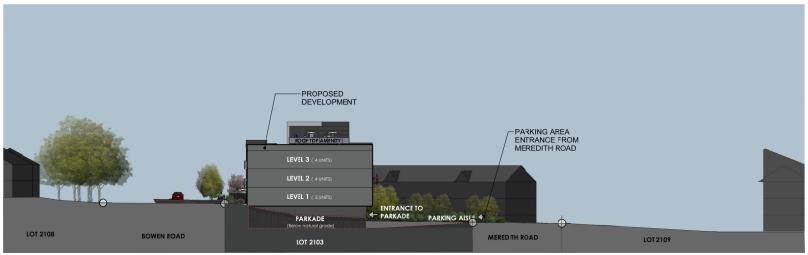

EAST-WEST CROSS SECTION THROUGH LOT



NOV 12, 2021

SEE DRAWING

A202

SCALE

STREET SCAPE ALONG BOWEN ROAD



PLANT PALETTE

Numbers of trees with 6cm cal and over = 25

con	Key	Botanical Name	Common Name	Pot Size
		Deciduous Trees (total 31)		OIL.
	Ар	Acer palmatum	Japanese Maple	2.5m
Colon .	11			10 gall
(+)	AgA 3	Amelanchier grandiflora 'Autumn Brilliance'	Service berry	10 gan
X	Ck	Cornus kousa	Chinese Dogwood (multistem)	3m. ht
W/D	Fad 3	Fagus sylvatics 'Dawyck Gold'	Dawyck Gold Beech	6 om cal
5	Pp 6	no missource Manager	Upright Persian Ironwood	6 cm cal
The state of	Sjap .	Shuray isonories	Snowbell Tree	6 cm cal
	3	опутах зарописа	GIORGEI TIEG	
	9	Coniferous Trees (total 9)		
7	Pob	Picea omorika bruns	Serbian Spruce	2m ht
	Pfv	Pinus flexilus vanderwolf	Vanderwolf Pine	2 m-ht-
-	Pn	Pinus nigra	Austrian Pine	2 m ht
	Ps	Pinus sylvestris	Scots Pine	2m ht
	100	Shrubs		
-	Ct	evergreen Choisya ternata	Mexican Orange Blossom	#1
	La	Lavendula angustifolia "Hidcote"	English lavender	#1
	Sh	Sarcoccoca humilus	Sweetbox	#1
	Vd	Viburnum davidii Vaccinium ovatum	David's Viburnun Evergreen Huckleberry	#1
	Vo	deciduous	Evergreen nouveberry	F1
	Cs	Cornus alba siberica	Red Twigged Dogwood	61
	Hd	Holodiscus discolor	Ocean Spray	#1
	Rs	Ribes sanguineum	Red Flowering Current	#1
and and		Low Shrubs/grasses/ferns/perennials		
2311,012	Gs	Gaultheria shallon	Salai	#1
	Ma	Mahonia aquifdium	Tall Oregon Grace	#1
	Mn	Mahonia nervosa	Dull Oregon Grape	Ø1 #1
	Ro	Rosemarinus officinalis	Rosemary	181
	Hk	Grasses Hakonechioa macra	Japanese Woodand grass	#1
	Hs	Helictotrichon sempervirens	Blue oat Grass	#1
	Msy	Miscanthus sinensis yaku jima	Maiden Grass	#1
	Ms	Miscanthus sinensis var purpurascers	Orange flame Grass	£1
	Sg	Stipa gigantissma Ferns	Giant Feather Grass	.01
	Aff	Athyrium filix-femina	Lady Fern	#1
	Bs	Blechnum spicant	Deer Fern	£1
	De	Dryopteris erythrosora	Autumn Fern	61
	Pmun	Polystichum manitum Perennials	Sword Fern	167
	Am	Achilles millefoium	Yarrow	61
	Sc	Solidago canacensis	Goldenrod	AT
	Ss	Symphyotrichum subspicatum	Douglas Aster	A1
>man		Bioswale: ruskes/sedges/iris		
	1			
0,	Co	Carex obnucta	Slough Sedge	A1
0,000	Co		Slough Sedge Western Iris Small flowered Bullrush	#1 #1

Landscape Design Rationale

Bowen Road Apartments

Introduction:

The site ies at the corner of Bowen and Meredith Roads. The landscape design forms an important buffer between the apartments and these two busy roads. It will function as an attractive streetscape, be a connection between

Planting Scheme:

The overall planting scheme will consist of a small wordland with layers of trees, shrubs and groundcover plants. This urban garden will provice several ecosystem services. It will be part of the stormwater management plan, at will contribute to an increase blodiversty in the city, and filter pollutants. In addition it provides "clese-at-hand" nature.


Bowen Streetscape: The trees are sized according to hydro guidelines, and will be a mix of towering trees, evergreen and discludious shruts and groundcovers. This planting will give the ground floor patios privacy will altwing light into the spaces. A metal ferce with locking gates will provide security for these units.

The Entrance: A small paved area at he corner of Bewen and Meredith leads people into the building via a ramp and stair system. The ently is clear whether waking up the stairs or he ramp. The ramp is pait by a wide planting area so as people travel up and down, they will wake uncer the canopy of trees. The walls are further softened at the base by a generous planting strip.

Meredith Road: a bioswale defines this planting area with boulders, cobbles, trees, shrubs, groundcovers and perennials all mixed in a "wid" garden. Where the hydro lines allow larger trees will be planted.

Along the west side I am proposing very narrow decicuous trees and a mix of shrubs at

Roof: A gathering place, seating area and garden boxes will be provided on the rooftop amenity area

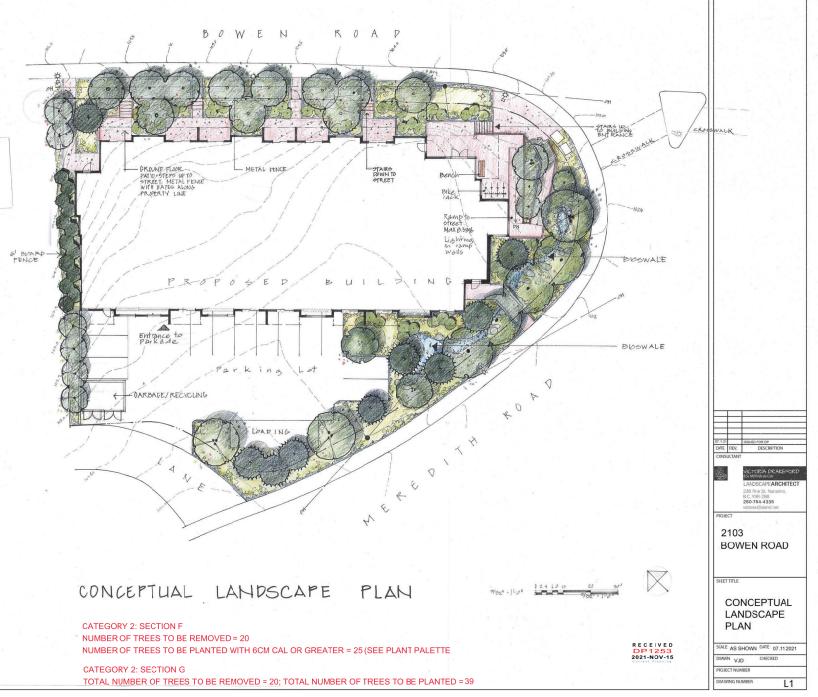



Bioswale





Bike rack

Bench







Interpretive Sign

Chinese dogwood



4' 0" Metal Fence



Evergreen hucklebery









BOWEN ROAD

ELEMENTS

SCALE AS SHOWN	DATE 07.112021
DRAWN VJD	CHECKED
PROJECT NUMBER	
DRAWING NUMBER	12



Snowbell tree

Japanese maple



Persian ironwood

Serviceberry







Oregon grape



Red flowering currant



Blueberries



Sword fern



Gaura



Catmint



Sedge



Schedule D

Amenity Requirements for Additional Density

For Additional Tier 1 Density

Category 2: Retention and Restoration of Natural Features (8 points required)

Е	The proposed development includes street trees	1
F	After re-planting, the proposed development does not result in a net loss of trees with a caliper greater than 6cm.	1
G	Post development, the total amount of trees on the property, or adjacent road right-of-way or public space is at least 20% more than the number of trees on the property before development.	2
Н	Restore a minimum of 50% of the site area (excluding the building lootprint) by maintaining pervious surfaces.	3
I	The development includes permanent educational signage or display(s)regarding the protected or planted plants, trees, animal habitat or other natural features on the site.	1
	*OTAL	8

Category 4: Building Materials (8 points required)

Α	Wood is the primary building material.	1
D	The proposed development uses materials with recycled content such that the sum of the postconsumer recycled material constitutes at least 25%, based on costs, of the total value of the materials in the project.	2
Е	The project developer has submitted a construction and waste management plan that, at a minimum, identifies the materials to be diverted from disposal and wnether the materials will be sorted onsite or comingled	2
F	At least 75% of the materials used in construction are renewable resources	2
Н	The development includes permanent educational signage or display(s)regarding the sustainable use of building materials used during construction of the project	1
	-OTAL	8

Category 5: Energy Management (11 points required)

A	The proposed development meets at least the requirements of Step 2 of the BC Energy Step Code and exceeds the requirement specified in the Building Bylaw by one step	10
D	"he development includes permanent education signage or display(s)regarding sustainabe energy management practice; used onsite	1
	*OTAL	11



THE DRAWNOS, DESIGN DEAS AND FEATURES OF CONSTRUCTION DEPOTED FROM THE PROPERTY OF THE PROPERTY EXCHAINS AND THE PROPERTY WITHOUT EXPENSE OF THE PROPERTY WITHOUT EXPENSE WHITHOUT CONSIDER, IN THE PROPERTY WITHOUT CONSIDER, IN THE PROPERTY WITHOUT CONSIDERATION OF THE PROPERTY OF



BOWEN APTS. 2103 BOWEN ROAD, NANAIMO, BC




CLIENT
CAMARGUE PROPERTIES INC.

l	₹EV. DATE	NUMBER	DESCRIPTION	DATE
				SCALE
l				
l				
l				
l				DRAWN BY

NG Additional liek I
21 Additional TIER 1

AERIAL PHOTO

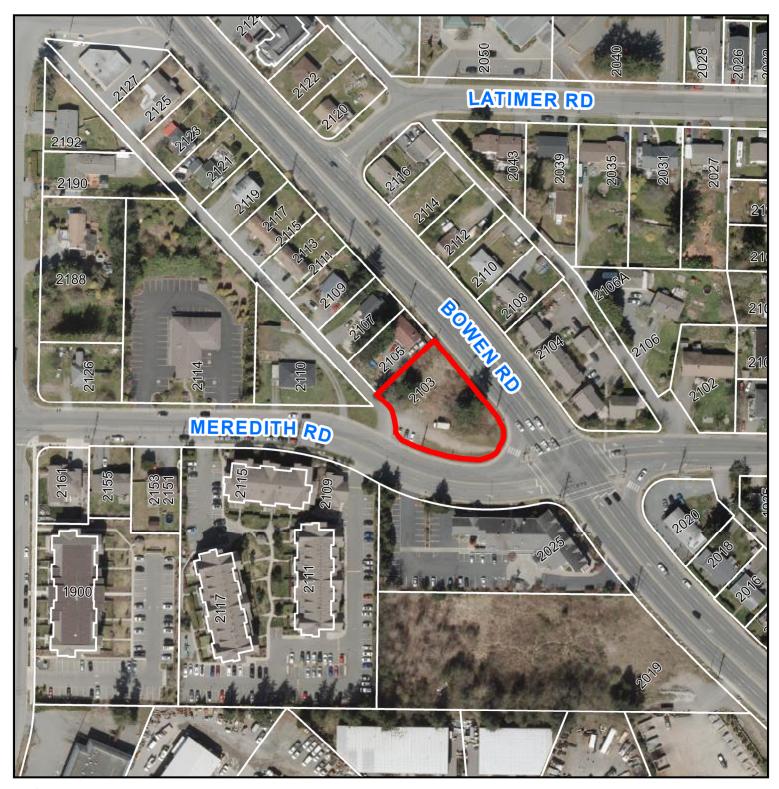



DEVELOPMENT PERMIT APPLICATION NO. DP001253



2103 BOWEN ROAD