M.H. JOHNSTON & ASSOCIATES INC.



Management & Project Development Consulting

City of Nanaimo

June 9th 2021

Current Planning

Re: Form and Character Development Permit Application – 2545 Doctor Road

Attached is our application for a Form and Character Development Permit for the property at 2545 Doctor Road. The site is a long narrow lot that once housed a duplex that has been demolished. Our infill development is proposed under the existing zoning and is for five family units with two duplex units and one single unit.

The site slopes from west to east and units on the site will have views over Departure Bay. The development will require regrading to lower the site which will result in a retaining wall of approximately 1.5m along the south boundary. South of the site is a cluster of duplex units with flat roofs which were probably built in the 1960's. As shown on the landscape plan there will be a planted buffer on top of the retaining wall on this boundary which will provide a green buffer.

Our neighbours to the rear of the property are on large lots off of Lynburn Crescent and our development should not impact their views of the Bay. A new West Coast/Arts and Crafts style home has been built to the north and our project will share a common driveway with this property. As far as I can determine there is not a form and character common to Doctor Road and our choice of a contemporary style should start to refresh development along the road.

As shown on the site plan the single unit is at the front of the property which gives the units behind the opportunity to enjoy views. All units have balconies and extensive glazing to enhance the views. The fronts of the units have large roof overhangs with exposed beams which provide shading and cover over the balconies.

A sideyard variance is required to accommodate the front 1.8m extension of parking spaces into the sideyard. These parking spaces will front into the retaining wall on the south boundary and with the landscaped planting on the wall these spaces should not be seen by the neighbours units. The parking will also not be seen from the road. Parking in this location means the property adjacent to the single unit or on the joint access does not need to be clustered with parking.

Mark Jønnston

M.H. Johnston & Associates Inc.

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DP1238


2021-JUN-09

CONTEXT MAP





LOCATION PLAN

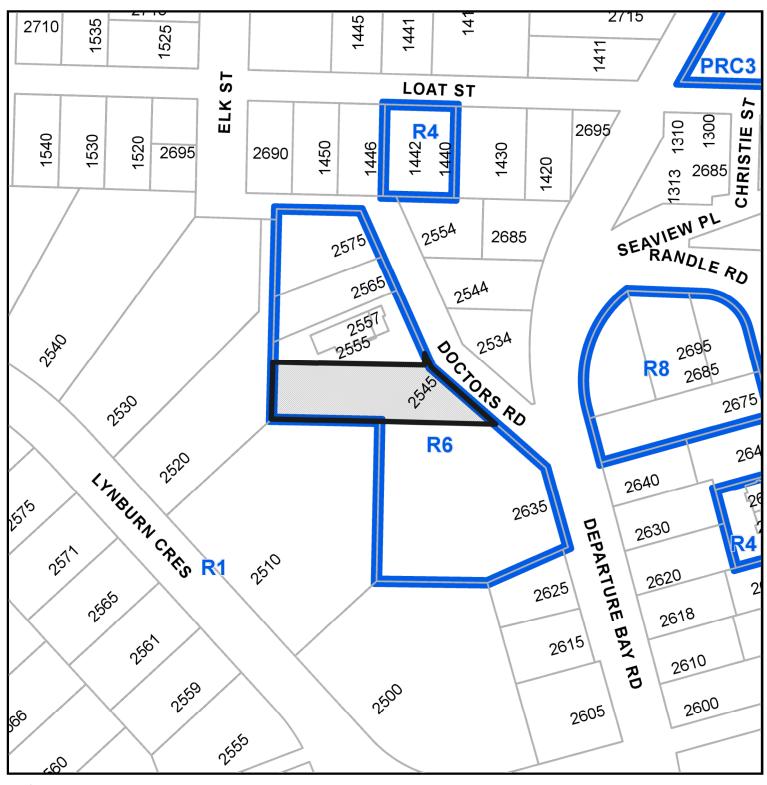




DEVELOPMENT PERMIT APPLICATION NO. DP001238

Subject Property

CIVIC: 2545 DOCTORS ROAD

LEGAL: PARCEL NO 1 (DD 18002N) OF PARCEL F (DD 11834N) OF SECTION

20, RANGE 8, MOUNTAIN DISTRICT

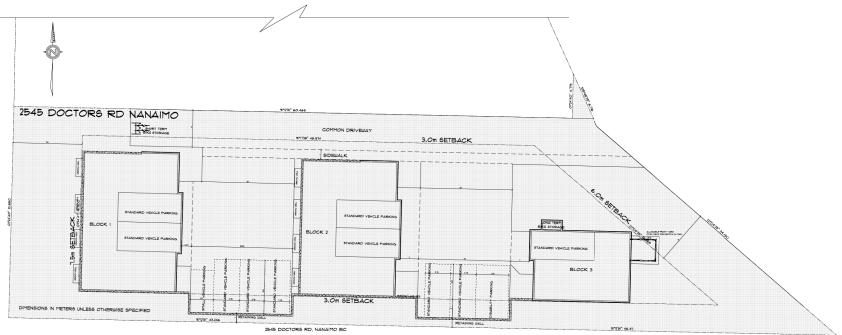

SITE SCALE: 1:125

LOT AREA (144.29 m2 LOT COVERAGE = 24.95% (435.25m2) GROSS FLOOR AREA = 692.31m2 FLOOR AREA RATIO = 0.40 BLOCK | = 380.60m2 BLOCK | = 271.26m2 BLOCK | 3 = 140.45m2

PARKING:
12 SPACES
3607 (1.8 # 2.2 m) OF ENCROACHMENT INTO LANDSCAPE BUFFER
1 MIN. SHORT TERM BIKE STORAGE
3 LONG TERM BIKE STORAGE

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A2 ME 06/10/2021
A1 ME 06/08/2021

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2545 DOCTORS RD, NANAIMO

TITLE:

BUILDING 1 ELEVATION

CLD-1033-El	_N-001	CLD-1033	MAY 2021	
DRAWING NO		PROJECT NO.	DATE:	
as shown	ME	JH	A2	
SCALE:	DRAWN:	CHECKED:	REVISION:	



PH: 250-240-5009

CLIMATE LANDSCAPE & DESIGN



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2545 DOCTORS RD, NANAIMO

TITLE:

BUILDING 2 ELEVATION

CLD-1033-EI	N-001	CLD-1033	MAY 2021	
DRAWING NO		PROJECT NO.	DATE:	
as shown	ME	JH	A2	
SCALE:	DRAWN:	CHECKED:	REVISION:	

00
PO BOX 41090 RPO WOODGRO NANAIMO, BC

PH: 250-240-5009

CLIMATE LANDSCAPE & DESIGN



SHEET 3

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2545 DOCTORS RD, NANAIMO

TITLE:

BUILDING 2 REAR ELEVATION

CLD-1033-EI	_N-001	CLD-1033	MAY 2021	
DRAWING NO		PROJECT NO.	DATE:	
as shown	ME	JH	A2	
SCALE:	DRAWN:	CHECKED:	REVISION:	

PO BOX 41090
RPO WOODGRO
NANAIMO, BC
PH: 250-240-5009

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SHEET 4 2545 DOCTORS RD, NANAIMO TITLE: **BUILDING 3 ELEVATION**

CLD-1033-EI	N-001	CLD-1033	MAY 2021		
DRAWING NO		PROJECT NO.	DATE:		
as shown	ME	JH	A2		
SCALE:	DRAWN:	CHECKED:	REVISION:		



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BOX 41090	LANDSCAPE & DESIGN
) WOODGROVE	





























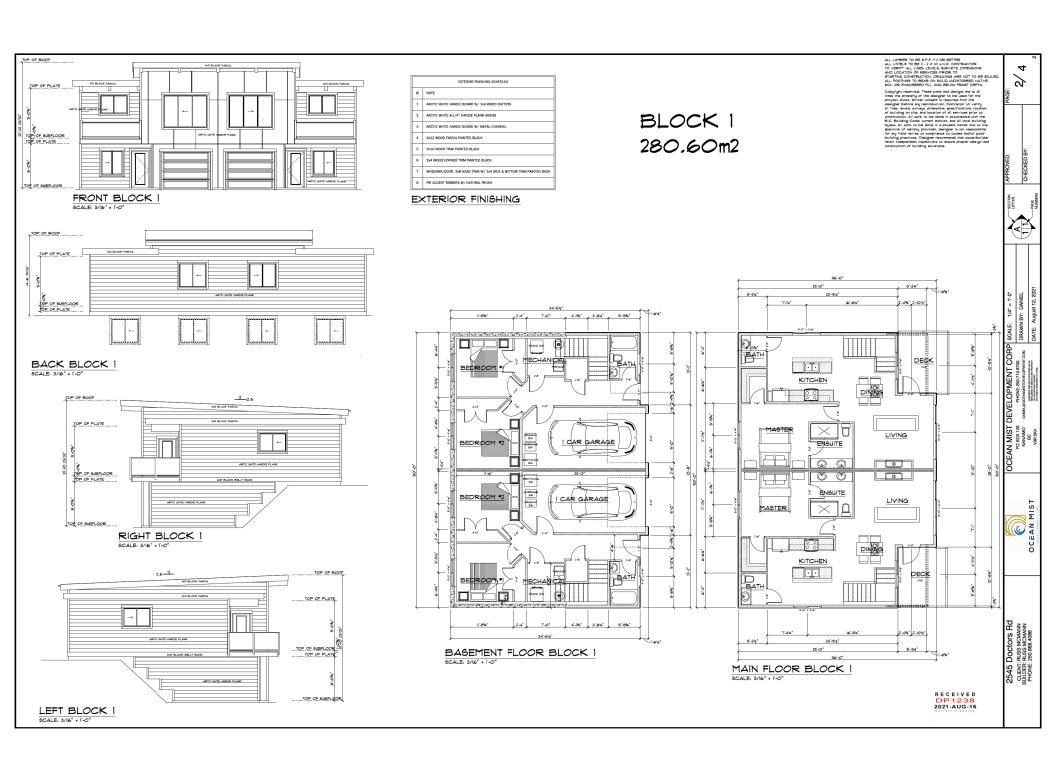

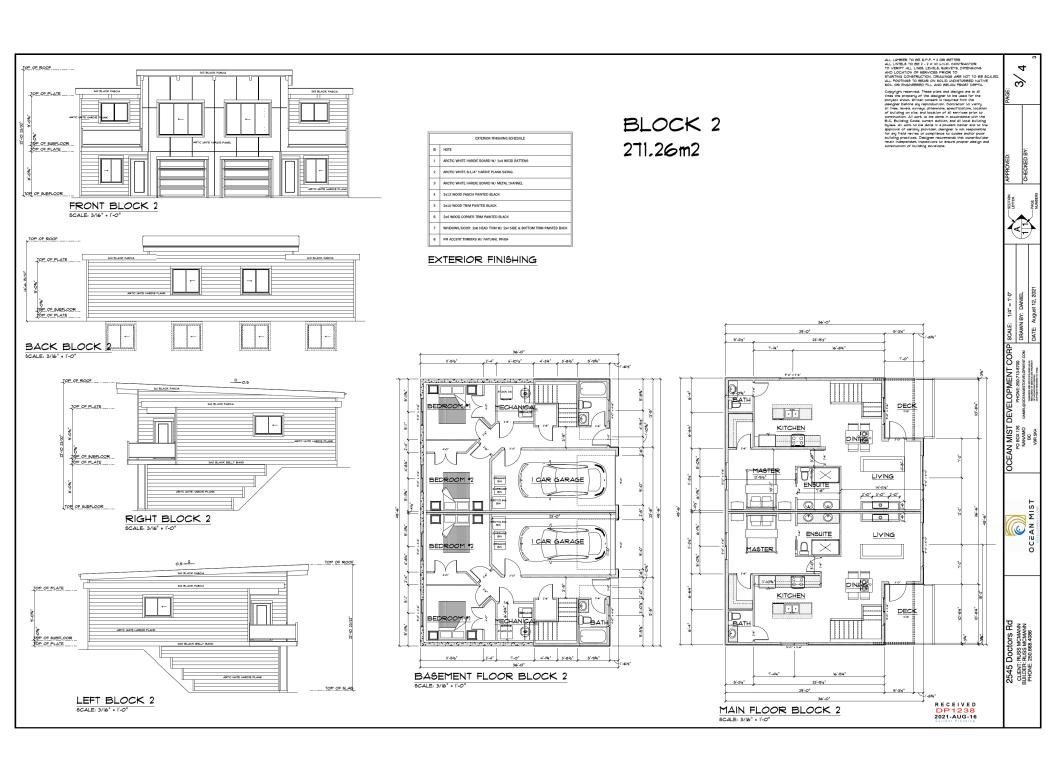

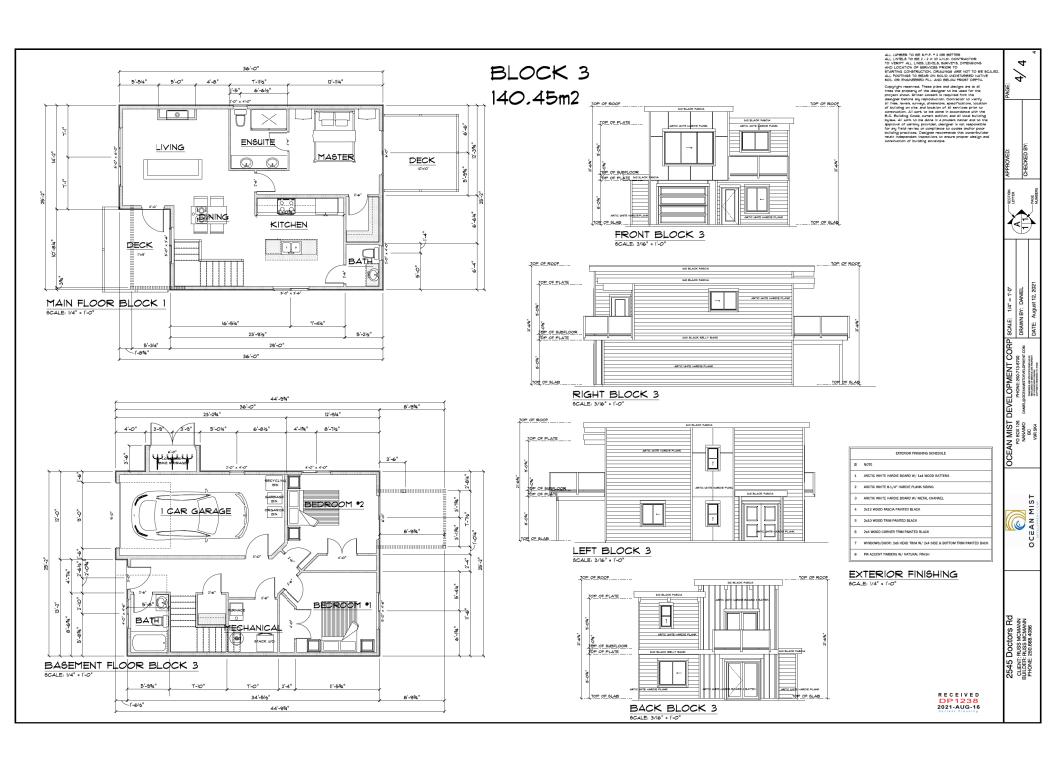

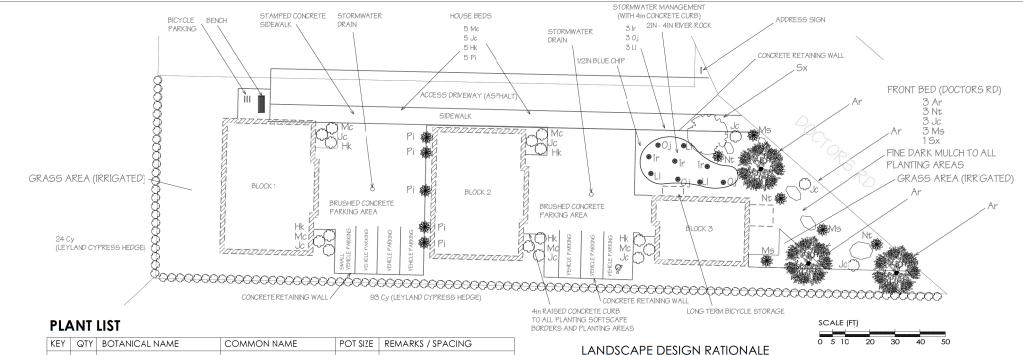

KEY	QTY	BOTANICAL NAME	COMMON NAME	POT SIZE	REMARKS / SPACING
		STORMWATER MANAGEMENT			
lr	3	IRIS ENSATA	JAPANESE WATER IRIS	1 GAL.	
Oj	3	OPHIOPOGON JAPONICUS	MONDO GRASS	1 GAL.	
LI	3	LOMANDRA LONGIFOLIA	SPINY MAT RUSH	1 GAL.	
		HOUSE BEDS			
Мс	5	MUHLENBERGIA CAPILLARIS	PINK GULP MUHLY	1 GAL.	
Jc	5	JUNIPERUS CHINENSIS	CHINESE JUNIPER	5 GAL.	
Hk	5	HAKONECHLOA	JAPANESE FOREST GRASS	1 GAL.	
PI	5	POA LABILLARDIERI	ESKDALE POA	1 GAL.	
		HEDGE			
Су	117	CUPRESSUS × LEYLANDII	LEYLAND CYPRESS	5 GAL.	0.9M o.c
		FRONT BED (DOCTORS RD)			
Ar	3	ACER RUBRUM	RED MAPLE	FIELD DUG	
Nt	3	NASSELLA TENUISSIMA	MEXICAN FEATHERGRASS	1 GAL.	
Jc	3	JUNIPERUS CHINENSIS	CHINESE JUNIPER	5 GAL.	
Ms	3	MISCANTHUS SINENSIS	EULALIA GRASS	3 GAL.	
Sx	1	SALIX BABYLONICA	WEEPING WILLOW	FIELD DUG	

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The site lies on the west side of Doctors Road. The existing lot is bare, except for three dead cedars on the roadside of the site.

The site has no natural screening, though the south adjacent lot has native cedars, fir, and alders providing some level of separation.

The objective of the landscape design is to create a setting for the McMann Homes town house development.

The front of the lot is the focal point of the landscape design, which employs a combination of drought resistant grasses, evergreen shrubs, stone, and colorful deciduous trees. This also acts as a privacy buffer for the planned single residence.

The planting design and choices compliment the strong contemporary and structural elements of the buildings.

The southern lot hedging [Leylandii] will provide an effective privacy screen between the properties.

The shrubs will be evergreen with textured leaves and architectural forms, some light and movement will be provided by planting ornamental grasses.

The stormwater management feature includes a bioswale along the northeast corner of th

This will col

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the property. ollect and slow water movement to the lowest point of the property.	REVISION:	INITIAL:	DATE:	
officer and slow water movement to the lowest point of the property.	А3	ME	08/15/2021	
	A2	ME	06/08/2021	
		=		

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PROJECT:		CLD-1033-P	LT-001	CLD-1033	MAY 2021		CIIV	MATE	
2545 DOCTORS RD, NANAIMO	SHEET 1	DRAWING NO).	PROJECT NO.	DATE:		LANDSCAF		
TITLE:	-	AS SHOWN	ME	JH	A3	PO BOX 41090 RPO WOODGROVE			
PLANTING PLAN		SCALE:	DRAWN:	CHECKED:	REVISION:	NANAIMO, BC PH: 250-240-5009	www.climate	:lanasca	ping.ca

SPECIFICATIONS 6.0.1 GENERAL REFERENCES for all Landscape work will refer to: The Canadian Landscape Standard - Latest Edition, published jointly by Canadian Society of Landscape Architects (CSLA) and Canadian Nursery Landscape Association (CNLA). During the growing season, store all plants in containers, batted and burkapped or wire basket in an upright position if not planted immediately and take care to provide enough space between plants such that light reaches all portions of the plant in order to world burning planted out. Protect rootbals of balled and burlappedmaterial by heeling in with material suitable to protect them for drying out lie, sawdust, pead mass, topsal). Do not store containerised and burlapped plants intended to be planted in the open in a building or in an area of to whetherily light for a period exceeding 7 days. Reep all plants well valered and protected from heaf and fost. 50.20 SITE CONDITIONS The location of all existing utilities are to be confirmed prior to the installation of any landscaping. Reference to Site Plans, Civil Engineering documents. Also refer to BC1Cat documents for City/Utilities services. 1.6.2 Rants shall be acclimated against the environmental conditions of their find planting location and shall not be taken directly from stode houses argenerhouse and planted in a distlictly different environment Pepcardion for the new environment bould hould en appended period afforced in on Immediate environment, managing feltiliser applications to avoid excessively just growth and provisation of a graduated watering regime. 1.0.3 The landscape contractor should give adequate notice prior to project tick off to allow a site meeting between the stakeholders to review site plans, documents and landscape plan and any affecting change orders. The Landscape Contractor shall leave the work areas clean, tidy and safe on a daily basis. EXISTING PLANT MATERIAL This section is not condicable All plant materials shall be guaranteed in writing to the owner for one year against death due to unhealth, supply and/or improper installation conditions and/or wrong selection of species or variety of plants. The one year period should begin at the cate of Landscape Contractors final invoice. GRADING The General Contractor shall have the responsibility to establish all sub-grades to allow for landscape installation to levels and contours specified on the landscape design drawings. TREE PLANTING Remove and dispose to approved off-life disposal area all debris, building material, contaminated subsoil, visable invasive plants and anything else that may nterfere with proper growth and development of planned finished landscape. The planting pits shall be excavated to the dimensions indicated in the drawing. Pit sides whereever posst shall be dug with spoing sides of a preferred angle of 45 degrees, scarafted to remove glazing and provide a roughened soll interferace. A minimum 30mm deglish candled layer of native soil shall be created in the bottom of the free pit. Remove all stones larger than 75mm. 3.0.2 The sub-grade shall be scarified to a minimum depth of 150mm immediatley before placing growing medium or drainage material. 3.0.3 Roughen bottom and sloping side surfaces of tree pit to remove glazing and provide a roughened soil interface prior to placement of tree and suspoil. Adjust elevation under where tree is to be placed so that the nursery soil line on the tree trunk will be 50m above firsh grade for st Grade transitions of sub-grade shall be smooth and even, such that ponding cannot occur on sub-grade surface. Remove wire basket prior to placement in planting pit. With the tree in the planting pit until and remove burkap and cord from the top 1/3 portion 3/a bated and burkapped rootbal. Completely remove, with care, imperitable containes from container-gown or bag-grown free? Grade and sub-grade elevations fil within the tolerances given below: Rough grades to follow the depith Selow firished grades. 190mm from grassed areas, 300mm for omamental grasses, perentials and groundcoves. 450mm for shrubs. 3.0.5 Trees with the following defects shall be replaced at the contractor's expens (a) Lack of rootball integrity: (b) Broken or abraded structural or main pots; All lossol, imported or on-site, shall be tested and modified as required. When bidding a contractor must test the proposed soil and include the required modifications in the price for the work. Current soil analysis reports must be done and signed by a pre-approved analytical latoratory. A copy of the spoil analysis must be sent to the Landscope Designers office. (c) Presence of fungal mass or fruiting bodies and discolouration; (d) Poor root development with few fibrous roots, or; (e) Any other evidence of pathogenic or accidental injury. Growing medium shall be placed at the following depths: 150mm for seeded areas, 300mm for ornamental grasses, perrennials and groundocvers, 450mm for shrubs and Unwap and spread out enciricling roots and tease out roots growing at the outside of the rootball. The tree shall be installed plumb and faced to provide the best appearance towards the primary viewing location, as determined by the Landscape Designer. 4.0.3 Where native soil remains in good condition no additional topsoil needs to be added but it may be amended to the recommendations in the soil test. 6.0.7 Place 2/3 depth of the topsoil and water to remove air voids. If indicated in the construction drawings, then prior to completion of backfilling, place free stakes, avoiding penetration of the root system. Stakes shall be driven plumb and to a sufficient depth in the subgrade that the portion exposed above finished grade = I metre height. 6.0.8 Topsoil shall not be worked in wet or frozen conditions or in any manner in which the soil structure is adversely Place remaining 1/3 of topsoil lightly boottapping to remove air voids ensure soil level does not exceed original nusery soil line. Form earth saucerto retain water over root ball and water in the tree. PLANTING - GENERAL CONDITIONS All plants and planting to meet the Standards of Canadian Society of Landscape Architects (CSLA) and Canadian Nursery Landscape Association (CNLA). Secure free to stakes with counter-tensioned, non-twisted loops of 19mm polypropelene webbing stapled Plants shall be characteristic of the genus, species and cultivar as indicated on the construction drawings and Place 75mm or bark mulch over soil surface those specified. All plants shall be nursery grown under similar climatic conditions to the project site. Plants shall not be pruned prior to delivery unless pre-approved by the Landscape Deligner. Container stock shall have been established in the size of container specified for at least 6 months pilor to delivery. The roots shall not have grown beyond the limits of the container. SHRUB AND GROUND COVER PLANTING Shrub beds shall be a total of a 450mm layer of ammended topsoil and a 50mm layer of bark mulch. Areas of ground covers shall a total of a 300mm layer of ammended topsoil and a 50mm layer of bark mulch 7.0.2 It is the Contractor's responsibility to verify an comply with all regulations regarding the inter-regional movement of plant material, including nusses stock, within the Province of British Columbia, imported plant materials must be accompanied by copies of the necessary permits and import focuses required by federal and provincial Excavate individual pits in the placed topoil mix for shrubs, to the same depth as the container holding 7.0.3 the shoub and 1.5 limes the width of the container. Place shrubs to show the best side towards the primary viewpoint. Water shrubs in the pits prior to backfilling with the planting medium. Rake shrub and ground cover beds to a smooth surface prior to placement of 50mm depth of bark mulch Plants shall be properly proportioned: not weak, thin or elongated. Plants shall have normal, well developed branches and vigorous, fibrous root systems. They shall be healthy ar free from defects, decay, girdling roots, surscald injuries, abrasions of the bank and plant diseases, insect pests eggs, borers and dill forms of Infestation. 7.0.5 Plant ground covers throught bark mulch layer into the "A" horizon layer below. The Contractor shall not plant ground covers into the mulch layer without full roof burial into the soil. 7.0.6 Rake mulch layer to a smooth finish grade and water bed. Triess have straight stems unless characteristic for the species. Pruning wounds shall show healthy callous growth of the branch color without bark tearing or fungal growth. Cambium issue shall be most and exhibit the correct colouration for the species. Plantie shability flungal stainingshall be rejected. 5.0.7 Sees which at the time of bothing require the removal of damaged or diseased branches trape than 1 zmm damater. An other between leadings, or the have a damaged lattir, will be eljected by the Cardicage Delight. Puning shall be limited to the minimum necessary to remove dead or damaged secondary branches or helps or to provide safe than dominant plants. Herein braid several, Whiching shall be only in fund and many the provided of the control of the provided several plants. Which is the discovery in fund and the For priving cast 12mm damater or smaller use clean shape secoleus. The cut shall be perpendicular to the branch angle and located of the outlines degree of the branch color only. 8.0.1 All plant materials stall conform to the measurements specified in the drowing except that plants large than specified may be used to approve the the Landscape begans. The use of these parts shall not change the specified may be used to prove the transfer of the specified may be used to prove the specified may be used to prove the specified may be used to the plant. All splants shall be measured when the bronches are in their normal position. Height and spread dimensions specified refer to the main body of the plant. All splants are the specified may be used to the plants and the plants and the plants are 8.0.2 ine gound as the tees joints in the husery. Midwelp parts ship to propagated in insureries and not harvarded from wild site, except where solvaged from an area where the tenders expended in the parts to see not the house the first and insureries and such as the first solve pooling and insureries and insu 9.0.1 Bark mulch shall be 50mm and minus Douglas Fir / Hemlock bark chips, dark brown in colour and shall be virtually flee of hivative and nosious seeds and reproductive pents, soil, stones, soils or offithe remului chemicals, or office extraneous matter that would prohibit seed germination or the healthy development of point material. IRRIGATION Collected plants shall not be used with prior approval in writing by the Landscape Designer. An irrigation system is to be designed and installed by Landscape Contractor. Balled and burlapped conifers and trees in excess of 3 metres in height must have been dug with a sufficiently large firm rootball to contain 75% of the fibrous and feeder root system. Rootballs shall be free of invasive weeds 10.0.2 All work to conform to the BC Plumbing Code as ammended to installation date. All workmanship is to be to Irrigation Industry Association of BC (IIABC) standards, latest edition. 5.0.12 Keep plants in a moist condition at all times. Protect all plants against damage and/or drying out until they are planted on the site. 10.0.1 Retaining walls should be subject to local building codes and General Contractor drawings and schedules During loading, transportation, off-loading and planting, protect all trees agains at damage to stems and branches. Protect bank against charing from chains, cobies, equipment or other frees by a wrapping of cardboard or burlap. Separate entangled free branches without damage to the branches. Plants with broken or abraded trunks or major branches will not be accepted. Prune damaged twigs to specific pruning guidelines using secaleus.

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A1	ME	05/10/2021

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Immediately cover and protect bare root stock from damage to roots by frost, sun and wind.

Do not lift trees in wire baskets by the trunk.

5017

Handle materials supplied in pots and containers by the container only to reduce breakage of branches and leaves

Handle balled butlapped plant materials with caulion to maintain firmness of the balls. No plants shall be used when the ball of earth surrounding the roots has been cracked orbroken prior to or during the process of planting, or when the burkey, broves and ropes required in connection with their througholting have been remove.

PROJEC		SHEET 2	CLD-1033-PLT-001		CLD-1033	MAY 2021		CLIMATE
	2545 DOCTORS RD, NANAIMO		DRAWING NO		PROJECT NO.	DATE:		LANDSCAPE & DESIGN
TITLE:			as shown	ME	JH	A2	PO BOX 41090 RPO WOODGROVE	
	LANDSCAPE SPECIFICATIONS		SCALE:	DRAWN:	CHECKED:	REVISION:	NANAIMO, BC PH: 250-240-5009	www.ciiiriareidiidseapiiig.ed

AERIAL PHOTO





DEVELOPMENT PERMIT APPLICATION NO. DP001238



2545 DOCTORS ROAD