



# CONTEXT MAP

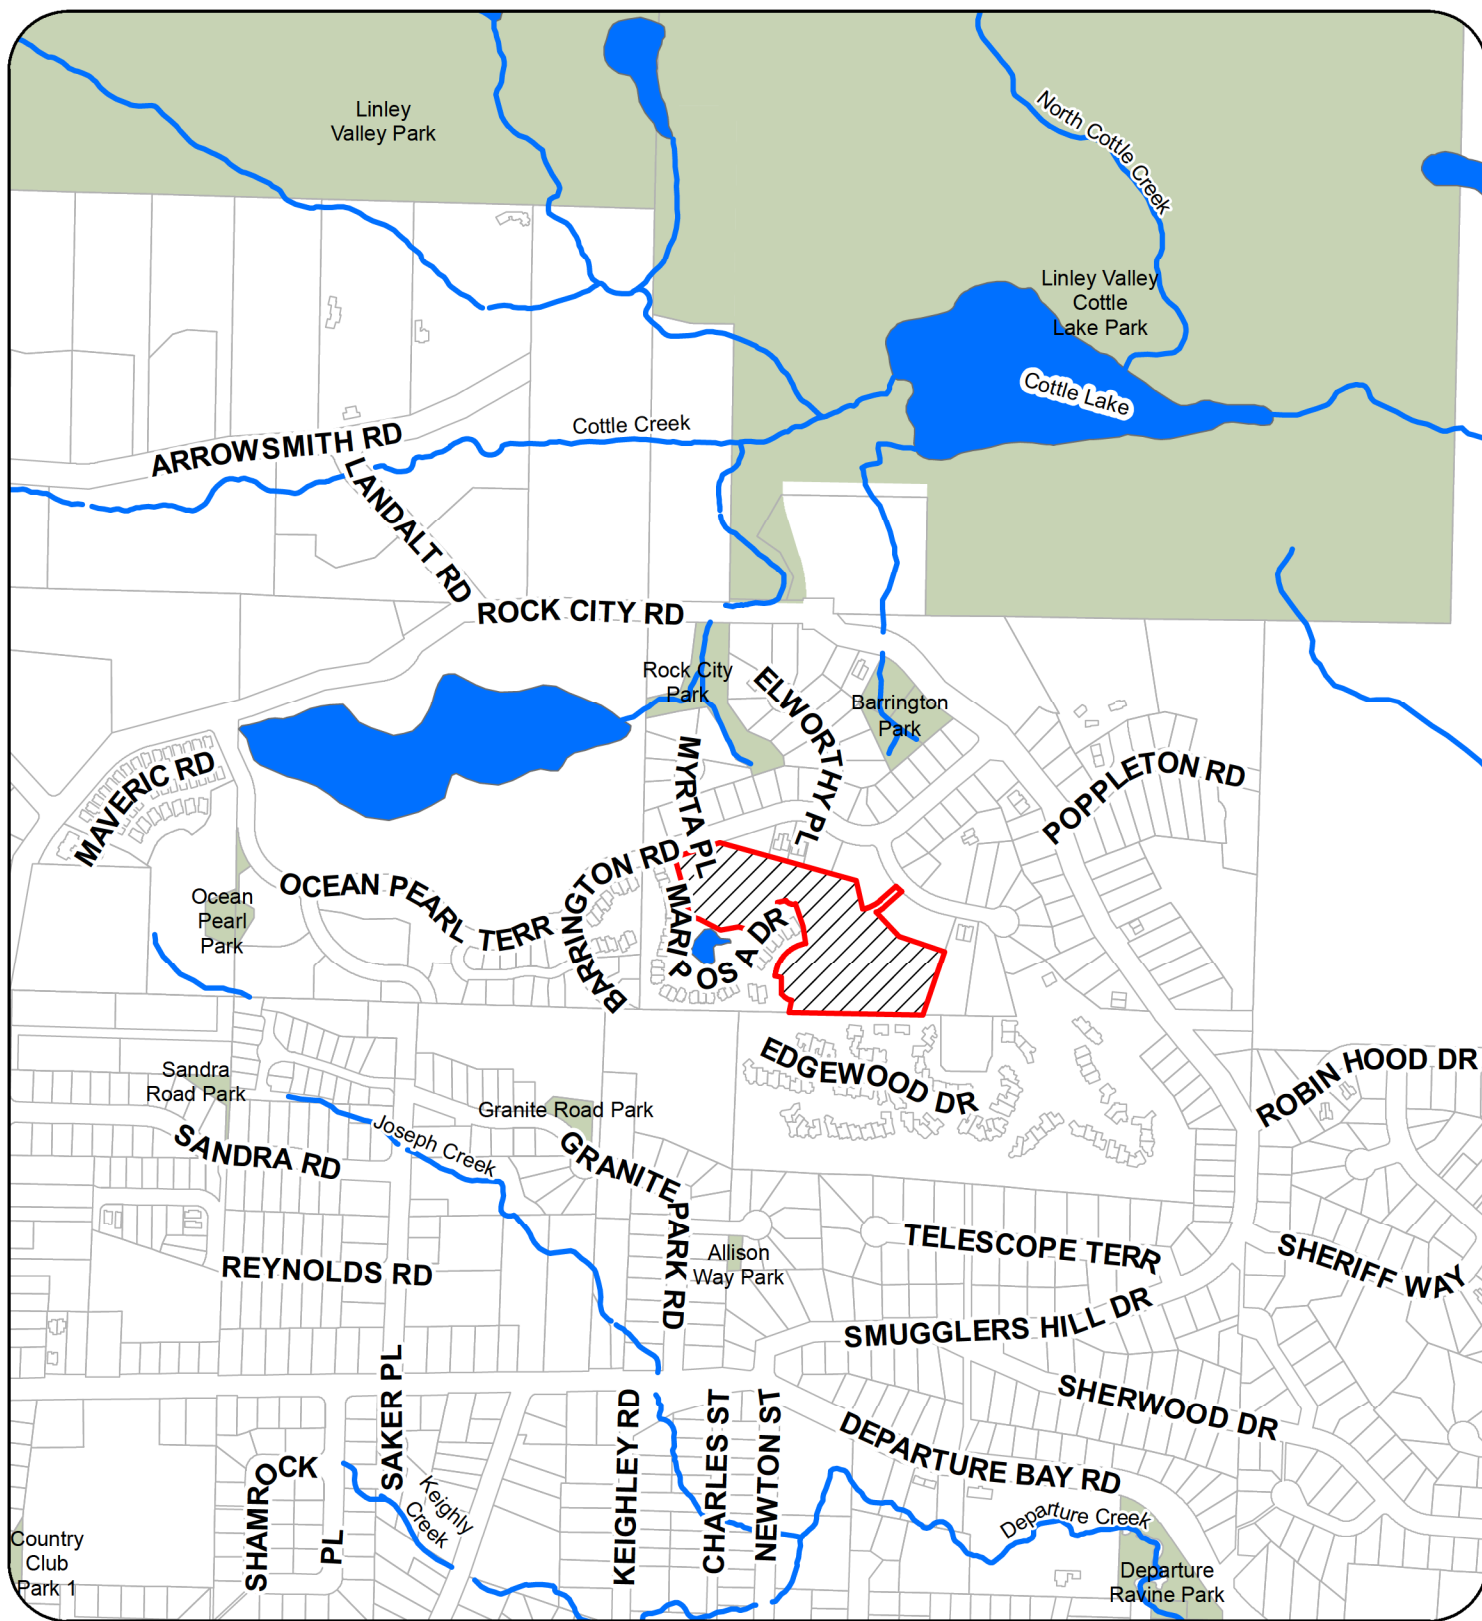

3401 BARRINGTON ROAD

# LOCATION PLAN

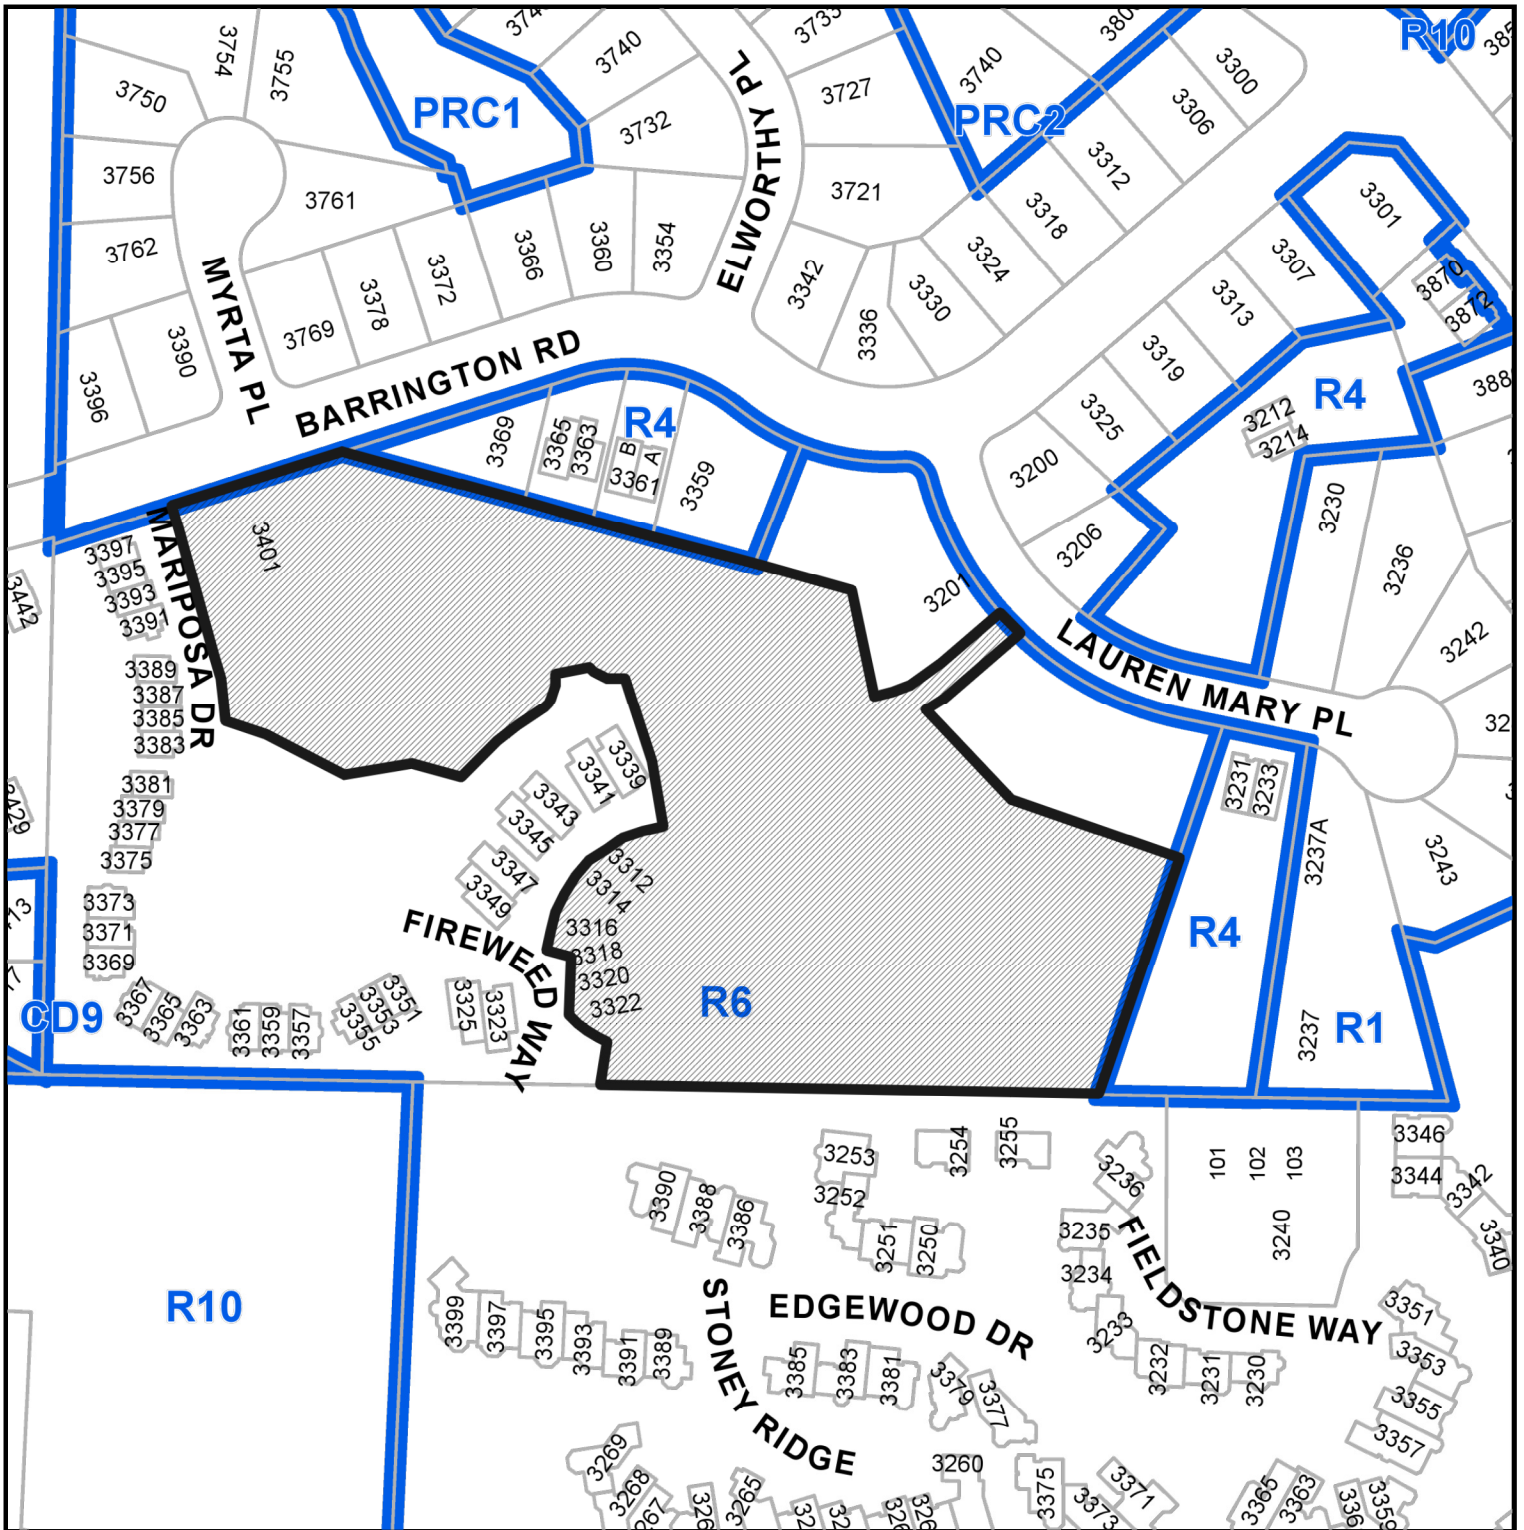

## DEVELOPMENT PERMIT APPLICATION NO. DP001235

CIVIC: 3401 BARRINGTON ROAD

LEGAL: LOT 2, DISTRICT LOT 56, WELLINGTON DISTRICT, PLAN EPP47501



**Subject Property**



#### BACKGROUND:

The subject property is situated at the south and south west end of an overall phased development at 3401 Barrington Road. Fireweed Way is a private strata road which will extend from the intersection of Mariposa Drive, a private strata road and Barrington Road. The subject property comprises of three phased lots as part of a Strata Plan, identified as Phase 5, Phase 6 and Phase 7.

The existing property is undeveloped and is characterized by trees and rock outcrops. The surrounding properties contain a mix of single, duplex and multi-family townhouse dwellings. The subject property slopes steeply downward approximately 20+m from south to north and a downward cross-slope (east to west).

#### PROPOSED DEVELOPMENT:

The proposal is to construct a 26-unit multi-family townhouse development. A total of seven buildings, where:

Building Block 1 & 7 on the south side of Fireweed Way (uphill) contain 4 units each. Building Block 3 & 5 on the south side of Fireweed Way (uphill) contain 3 units each. Building Block 2, 4 & 6 on the north side of Fireweed Way (downhill) contain 4 units each.

Every unit is approximately 154sm in size and all units have 3 bedrooms.

The maximum floor area allowed (unit entitlement) is 3,984sm and the maximum permitted total number of units allowed per Form E Declaration is 26 units. The proposed total gross floor area is 3,971sm and a total of 26 units are proposed.

#### SITE DESIGN:

Along the northern edge of the Phase 5, 6 and 7 lots there is a retaining wall proposed to allow an efficient location of buildings and minimize vehicular access. The average height of the downhill side of the retaining wall ranges from 1.0m up to 4.0m.

Three buildings along the north half of the property are sited to follow the boundaries of the phase lots in somewhat of a staggered placement. The remaining 4 buildings are situated on the south half of the property following the natural topography also in a staggered placement. In accordance with the Steep Slope Design Guidelines, all the buildings are located in a way that minimizes the disturbance of natural features on the site and minimizes shadows, while optimizing views, daylight exposure and functionality.

Individual driveways of sufficient parking stall length off Fireweed Way give access to the at-grade garages of each unit. Each of the garages on the downhill units (Blocks 2, 4 & 6) provide one parking space and each of the garages on the uphill units (Blocks 1, 3, 5 & 7) provide 2 parking spaces. Combined with the parking on each driveway and visitor parking, the proposal exceeds the "Off Street Parking Regulations Bylaw 2018 No. 7266" requirements. Pedestrian connections are provided from the front doors of each unit to the drive aisle.

Unit amenity spaces consist of a patio located at the rear of every unit. There is an additional circular social amenity space, an all-white coloured enclosure of post & beam vine arbours and lattice infill panels and low level lighting, providing an inviting meeting spot for neighbours with conversation benches and a small outdoor soft surface play area located between Block 2 and 4. Although only 2 Visitor parking stalls are required there are a total of 5 Visitor parking stalls provided distributed throughout the property.

Garbage receptacles will be stored within the garages of each unit. Long term bicycle parking is provided in each and every garage, and short term bicycle parking racks are provided within the landscaped areas.

#### BUILDING DESIGN:

Buildings (Block 2, 4 & 6) on the north half of the property (downhill) are single storey at the front and 2 storeys at the rear due to the grade change.

Buildings (Block 1, 3, 5 & 7) on the south half of the property (uphill) are 3 storey at the front and 2 storeys at the rear due to the grade change.

All the front facades are well articulated with the building massing and placement of front entries and garages clearly identifying individual units. The building forms are accentuated with slanted roofs along with decorative timber wall brackets and columns. The uphill units include a second storey balcony providing favourable street front surveillance and taking advantage of desirable views from that level and orientation. In accordance with the Steep Slope Design Guidelines, the roofs are



## 26 UNIT TOWNHOUSE DEVELOPMENT FIREWEED WAY, NANAIMO, BC

#### DRAWING LIST

A100	KEY PLAN
	AREA SUMMARY
	BUILDING HEIGHT SUMMARY
A110	PROPOSED SITE PLAN
A151	PHASE 5 - AREA SUMMARY
A152	PHASE 6 - AREA SUMMARY
A153	PHASE 7 - AREA SUMMARY
A160	PARKING PLAN
A200	BLOCK #1 - FLOOR PLANS
A210	BLOCK #2 - FLOOR PLANS
A220	BLOCK #3 - FLOOR PLANS
A230	BLOCK #4 - FLOOR PLANS
A240	BLOCK #5 - FLOOR PLANS
A250	BLOCK #6 - FLOOR PLANS
A260	BLOCK #7 - FLOOR PLANS
A300	BLOCK #1 - BUILDING ELEVATIONS
A310	BLOCK #2 - BUILDING ELEVATIONS
A320	BLOCK #3 - BUILDING ELEVATIONS
A330	BLOCK #4 - BUILDING ELEVATIONS
A340	BLOCK #5 - BUILDING ELEVATIONS
A350	BLOCK #6 - BUILDING ELEVATIONS
A360	BLOCK #7 - BUILDING ELEVATIONS
A400	EXTERIOR FINISHES - TYPE A (LIG-IT)
A410	EXTERIOR FINISHES - TYPE B (DARK)
A500	RENDERINGS
A510	RENDERINGS



ISSUED FOR DEVELOPMENT PERMIT  
APRIL 12, 2021

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## BUILDING HEIGHTS

### BLOCK #1

#### AVERAGE FINISHED GRADE

1131 134 137 147 138 694 136 404414 =	442.32 FT	134.82 M
PROPOSED BUILDING HEIGHT ELEVATION =	37.38 FT	14.45 M
PROPOSED BUILDING HEIGHT =	42.00 FT	9.77 M

### BLOCK #2

#### AVERAGE FINISHED GRADE

1130254 131 3004 134 0004 133 40114 =	433.89 FT	132.24 M
PROPOSED BUILDING HEIGHT ELEVATION =	40.59 FT	14.09 M
PROPOSED BUILDING HEIGHT =	27.12 FT	8.45 M

### BLOCK #3

#### AVERAGE FINISHED GRADE

135 036 136 052 139 999 138 983414 =	457.28 FT	139.38 M
PROPOSED BUILDING HEIGHT ELEVATION =	46.85 FT	14.05 M
PROPOSED BUILDING HEIGHT =	26.58 FT	8.11 M

### BLOCK #4

#### AVERAGE FINISHED GRADE

1132 300 133 769 137 500 136 347414 =	442.85 FT	134.98 M
PROPOSED BUILDING HEIGHT ELEVATION =	41.26 FT	14.64 M
PROPOSED BUILDING HEIGHT =	28.41 FT	8.66 M

### BLOCK #5

#### AVERAGE FINISHED GRADE

1137 264 138 074 141 441 140 805914 =	458.75 FT	139.83 M
PROPOSED BUILDING HEIGHT ELEVATION =	40.56 FT	14.02 M
PROPOSED BUILDING HEIGHT =	31.79 FT	9.69 M

### BLOCK #6

#### AVERAGE FINISHED GRADE

1134 134 130 138 760 137 849414 =	447.05 FT	136.26 M
PROPOSED BUILDING HEIGHT ELEVATION =	47.16 FT	14.46 M
PROPOSED BUILDING HEIGHT =	26.12 FT	8.57 M

### BLOCK #7

#### AVERAGE FINISHED GRADE

1138 033 139 049 142 996 141 777414 =	461.81 FT	140.70 M
PROPOSED BUILDING HEIGHT ELEVATION =	46.70 FT	15.10 M
PROPOSED BUILDING HEIGHT =	33.69 FT	10.33 M


### PROPOSED VARIANCES TO THE MAXIMUM ALLOWABLE BUILDING HEIGHT OF 9.00 AS FOLLOWS:

BLOCK 1 - PROPOSED HEIGHT = 9.77M	PROPOSED HEIGHT VARIANCE = 0.77M
BLOCK 2 - PROPOSED HEIGHT = 8.45M	PROPOSED HEIGHT VARIANCE = NONE
BLOCK 3 - PROPOSED HEIGHT = 8.77M	PROPOSED HEIGHT VARIANCE = NONE
BLOCK 4 - PROPOSED HEIGHT = 8.66M	PROPOSED HEIGHT VARIANCE = NONE
BLOCK 5 - PROPOSED HEIGHT = 8.69M	PROPOSED HEIGHT VARIANCE = NONE
BLOCK 6 - PROPOSED HEIGHT = 8.57M	PROPOSED HEIGHT VARIANCE = NONE
BLOCK 7 - PROPOSED HEIGHT = 10.33M	PROPOSED HEIGHT VARIANCE = 1.33M



**KEY SITE PLAN**  
(N.T.S. FOR REFERENCE ONLY)

SITE AREA: TOTAL SITE AREA		87,646.0 SF	8,142.58 SM
LOT COVERAGE			
MAX ALLOWABLE	40.0%	35,058.4 SF	3,257.03 SM
PROPOSED COVERAGE			
BLOCK #1		3,794.2 SF	344.13 SM
BLOCK #2		5,118.9 SF	475.56 SM
BLOCK #3		2,765.7 SF	259.73 SM
BLOCK #4		5,118.9 SF	475.56 SM
BLOCK #5		2,765.7 SF	259.73 SM
BLOCK #6		5,118.9 SF	475.56 SM
BLOCK #7		3,794.2 SF	344.13 SM
TOTAL PROPOSED LOT COVERAGE		32.4%	28,356.5 SF 1,079.42 SM
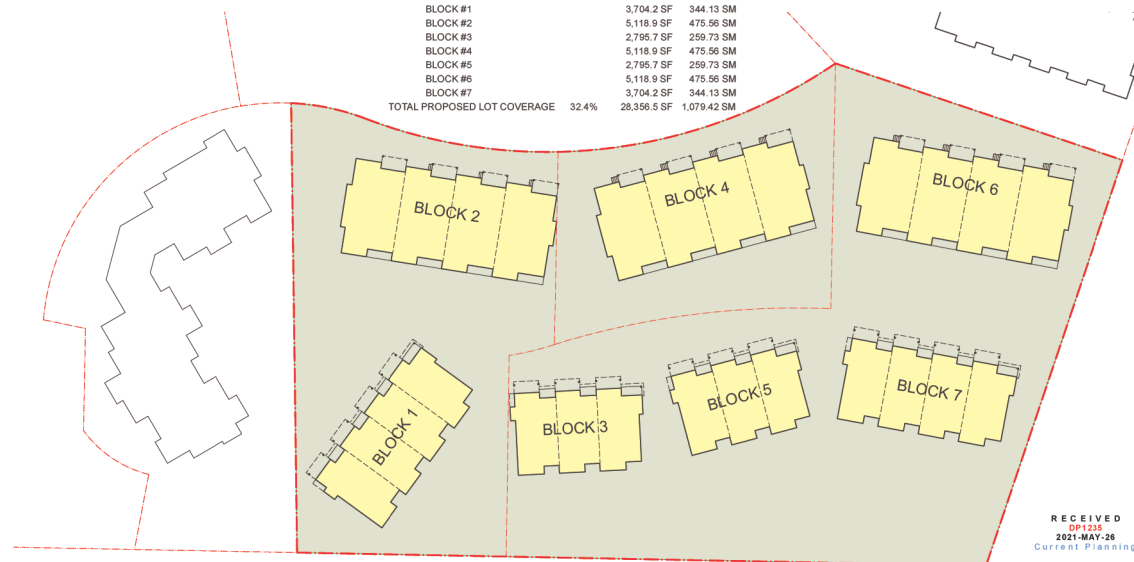
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SURREY, B.C.  
V4A 0C4

TEL: 604-916-8582  
EMAIL: [gus@g3projects.com](mailto:gus@g3projects.com)



✓ **SUBJECT SITE**  
**(PHASES 5 & 6 & 7)**  
**AREA = 8,142.6SM (87,646SF)**

26 UNIT  
TOWNHOUSE DEVELOPMENT  
FIREWEED WAY  
NANAIMO, BC

TITLE:

KEY SITE PLAN  
AREA SUMMARY  
BUILDING HEIGHT SUMMARY

SCALE:	N.T.S.	DRAWING NO.:  <b>A100</b>
DATE:	21/04/12	








PER BYLAW 7266, PART VII - MULTIPLE FAMILY DWELLING TABLE 7.1-AREA 1

TOTAL # OF 3-BDRM DWELLING UNITS =	26 UNITS
PARKING STALLS REQUIRED @ 2.0 STALLS PER UNIT =	52 STALLS
VISITOR STALLS REQUIRED @ 1 PER 22 STALLS =	2 STALLS
TOTAL NUMBER OF STALLS REQUIRED =	54 STALLS
MIN NUMBER OF FULL SIZE STALLS REQUIRED @ 60% =	32 STALLS

NUMBER OF FULL SIZE STALLS PROVIDED =	35 STALLS
NUMBER OF SMALL CAR STALLS PROVIDED =	36 STALLS
TOTAL NUMBER OF STALLS PROVIDED =	71 STALLS
NUMBER OF STALLS PROVIDED FOR VISITORS =	5 STALLS
TOTAL NUMBER OF HANDICAP STALLS PROVIDED =	1 STALLS

SHORT TERM BICYCLE SPACES @ 0.1/DWELLING UNIT X 26 UNITS =	3 STALLS
LONG TERM BICYCLE SPACES @ 0.5/DWELLING UNIT X 26 UNITS =	13 STALLS
TOTAL NUMBER OF BICYCLE SPACES REQUIRED =	16 STALLS
TOTAL NUMBER OF BICYCLE SPACES PROVIDED =	26 STALLS
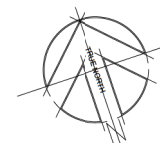
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V4A 0C4

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EMAIL: gus@g3projects.com

**26 UNIT  
TOWNHOUSE DEVELOPMENT  
FIREWEED WAY  
NANAIMO, BC**

TITLE: **PARKING PLAN**

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DATE:	21/04/12

DRAWING NO.:  
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03/03 / 18:00









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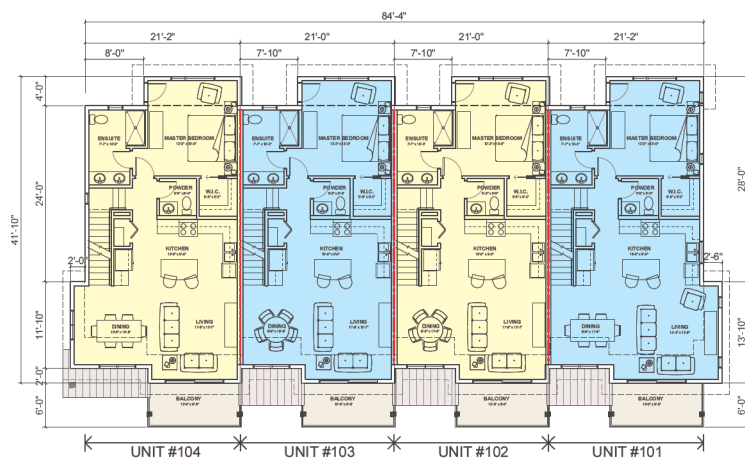


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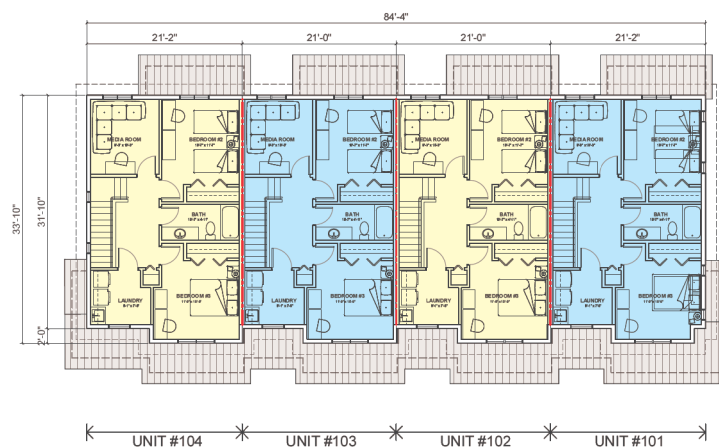
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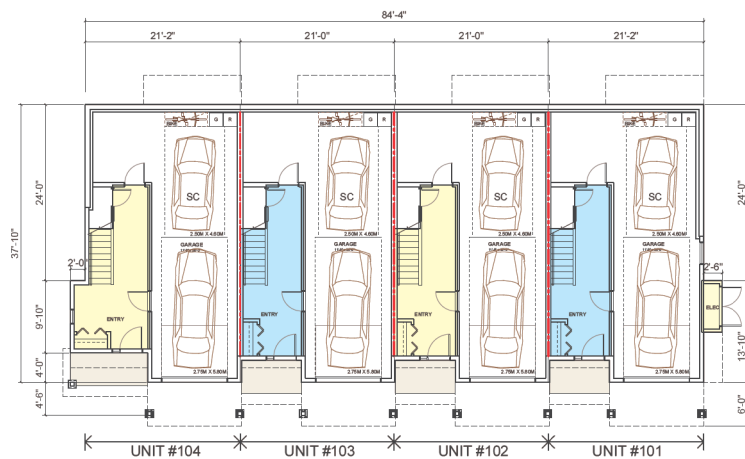





### MIDDLE FLOOR PLAN

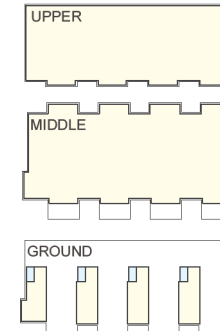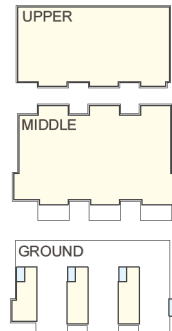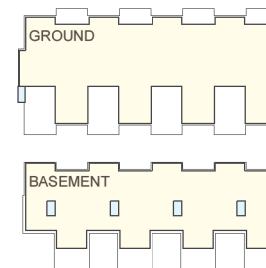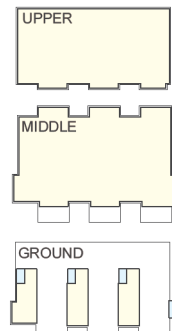

### UPPER FLOOR PLAN



### GROUND FLOOR PLAN

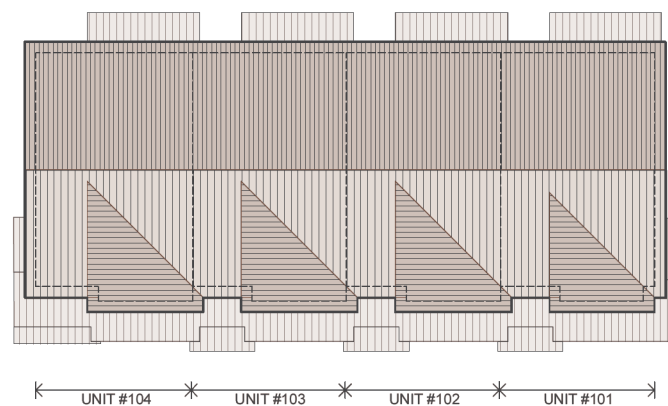

### ROOF PLAN

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26 UNIT  
TOWNHOUSE DEVELOPMENT  
FIREWEED WAY  
NANAIMO, BC

TITLE:  
**BLOCK #1  
FLOOR PLANS**


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98.92 / 100%

UNIT #201   \*   UNIT #202   \*   UNIT #203   \*   UNIT #204



### GROUND FLOOR PLAN

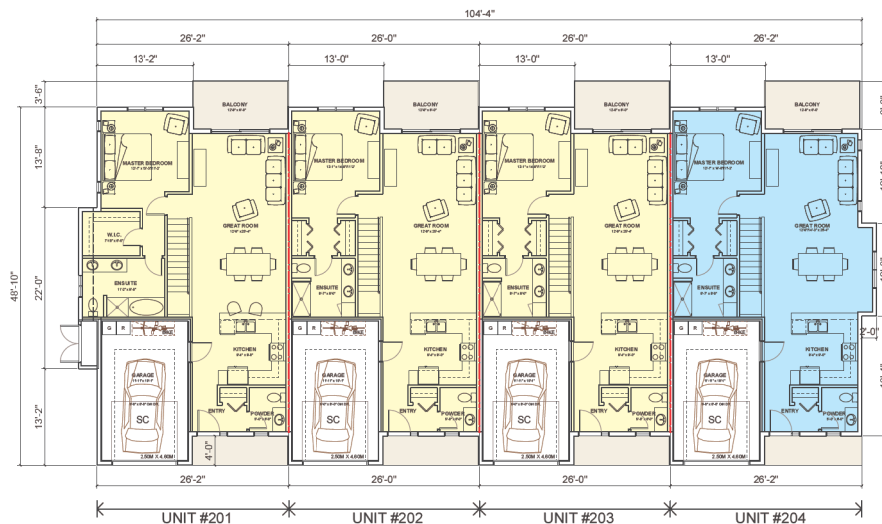

### BASEMENT PLAN

19/11/01	DESIGN DEVELOPMENT
20/05/10	DEVT PERMIT COORDINATION
20/12/05	ISSUED FOR DP: PRE-APPLICATION
21/04/12	ISSUED FOR DEVT PERMIT APPLICATION


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26 UNIT  
TOWNHOUSE DEVELOPMENT  
FIREWEED WAY  
NANAIMO, BC

TITLE:  
**BLOCK #2  
FLOOR PLANS**

SCALE:  $1/8" = 1'-0"$


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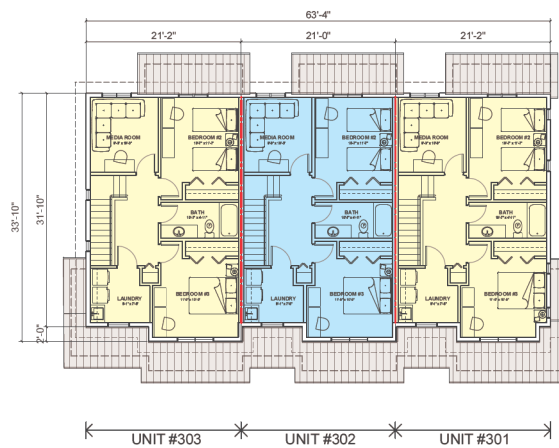
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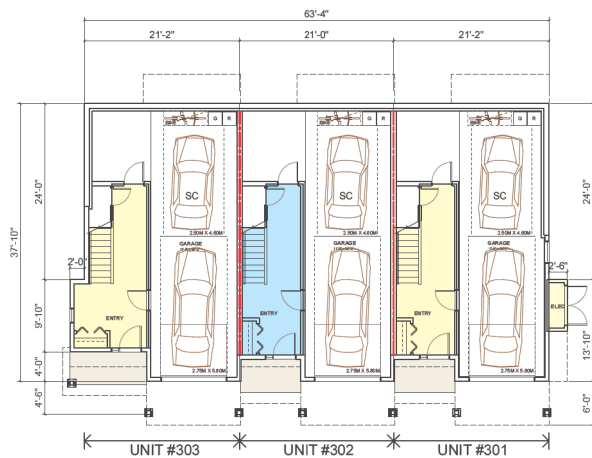


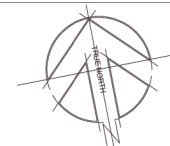


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### UPPER FLOOR PLAN



### GROUND FLOOR PLAN

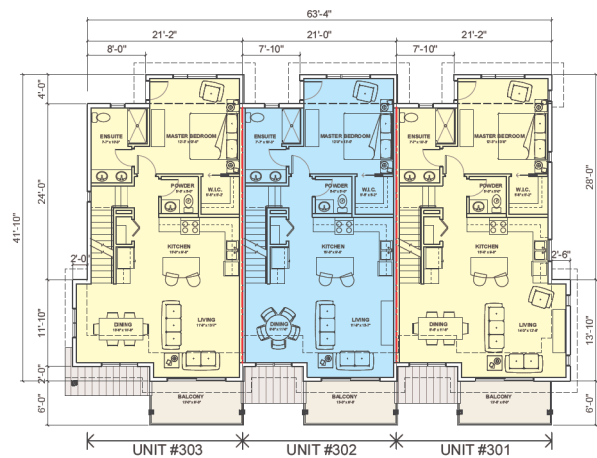

### ROOF PLAN

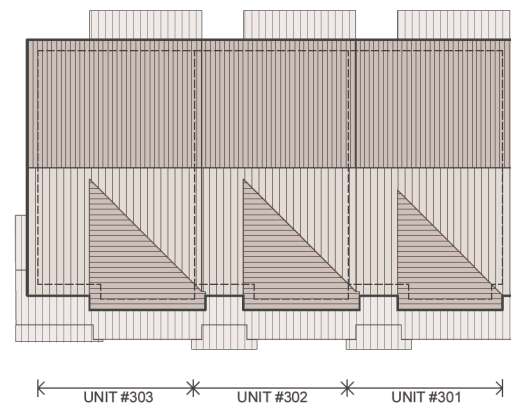
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20/05/10	DEVT PERMIT COORDINATION
20/12/05	ISSUED FOR DP: PRE-APPLICATION
21/04/12	ISSUED FOR DEVT PERMIT APPLICATION

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26 UNIT  
TOWNHOUSE DEVELOPMENT  
FIREWEED WAY  
NANAIMO, BC

TITLE:  
**BLOCK #3  
FLOOR PLANS**

SCALE:	1/8" = 1'-0"
DATE:	21/04/12

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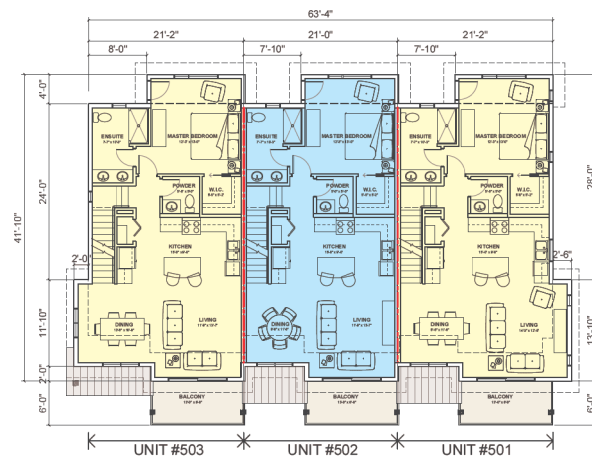
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2021-MAY-26  
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98.92 / 100%

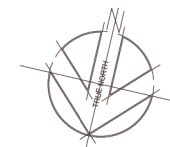


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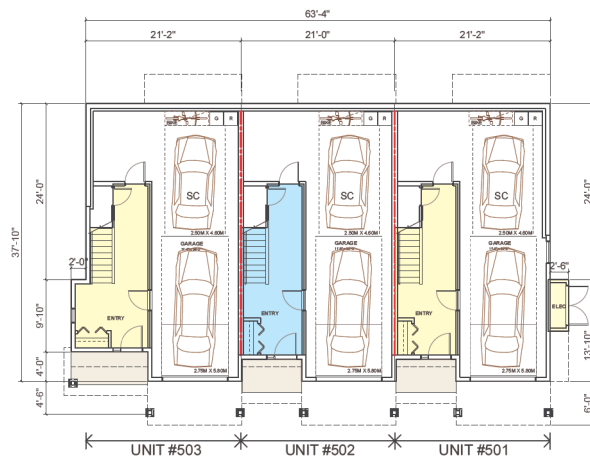
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2021-MAY-26  
Current Planning




### MIDDLE FLOOR PLAN

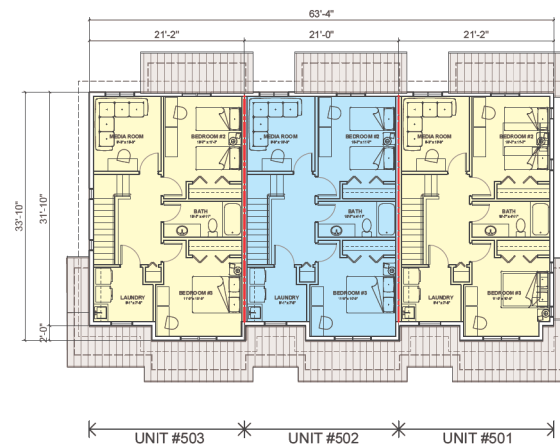

### UPPER FLOOR PLAN



### GROUND FLOOR PLAN

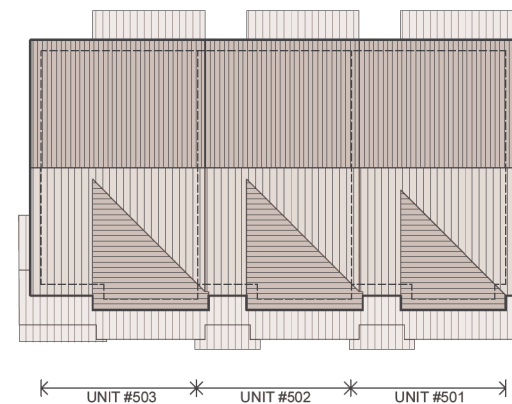

### ROOF PLAN


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26 UNIT  
TOWNHOUSE DEVELOPMENT  
FIREWEED WAY  
NANAIMO, BC

TITLE:

**BLOCK #5  
FLOOR PLANS**

SCALE:	$1/8" = 1'-0"$
DATE:	21/04/12

DRAWING NO.:
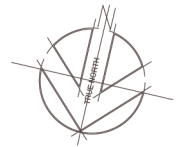
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2021-MAY-26  
Current Planning


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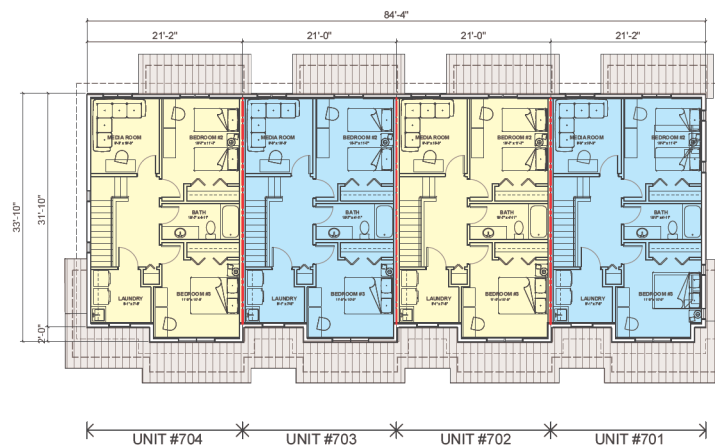


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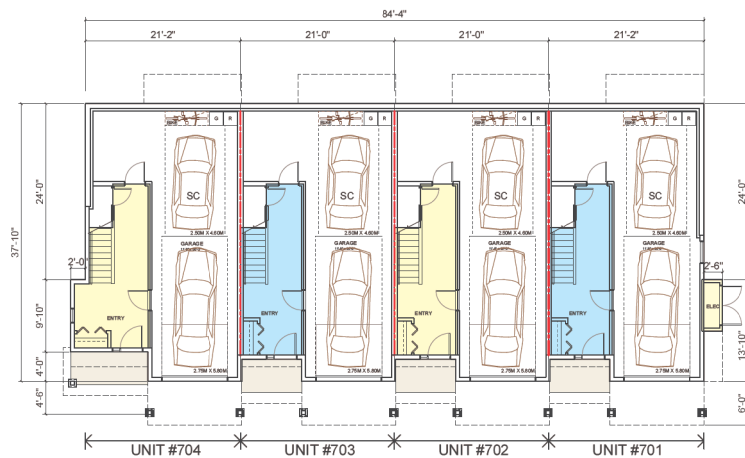
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2021-MAY-26  
Current Planning




### MIDDLE FLOOR PLAN

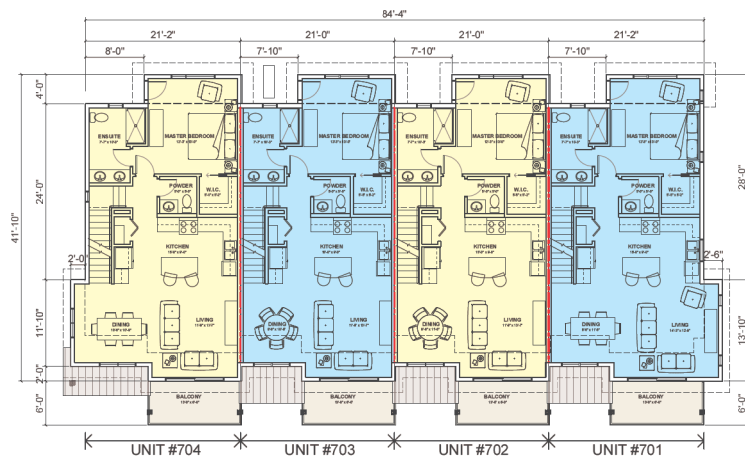

### UPPER FLOOR PLAN



### GROUND FLOOR PLAN

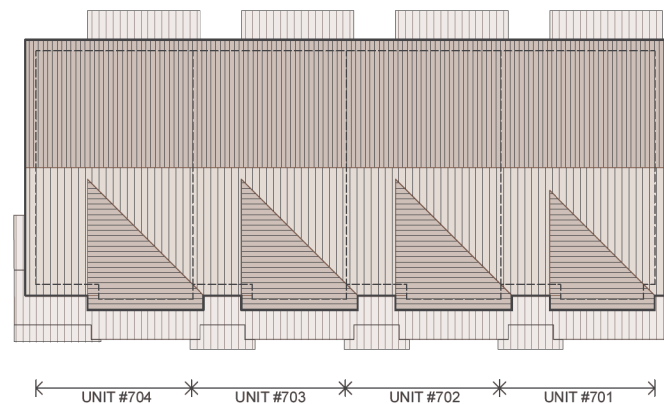

ROOF PLAN


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EMAIL: [gus@g3projects.com](mailto:gus@g3projects.com)



26 UNIT  
TOWNHOUSE DEVELOPMENT  
FIREWEED WAY  
NANAIMO, BC

TITLE:

**BLOCK #7  
FLOOR PLANS**

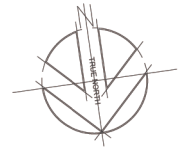SCALE:	$1/8" = 1'-0"$
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DRAWING NO.:

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Current Planning

824984 / 18052



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19/11/01	DESIGN DEVELOPMENT
20/05/10	DEVT PERMIT COORDINATION
20/12/05	ISSUED FOR DP: PRE-APPLICATION
21/04/12	ISSUED FOR DEVT PERMIT APPLICATION

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 Current Planning

**26 UNIT  
 TOWNHOUSE DEVELOPMENT  
 FIREWEEDWAY  
 NANAIMO, BC**

TITLE:  
**RENDERINGS  
 (FOR REFERENCE ONLY)**

SCALE: N.T.S.	DRAWING NO.:
DATE: 21/04/12	<b>A500</b>

BARRETT / 110027





NOTE: THESE RENDERINGS SHOWN HERewith ARE FOR REFERENCE ONLY WITH REGARDS TO BUILDING MASS AND SITE LAYOUT. THEY DO NOT REFLECT EXACTLY THE FINAL DESIGN. REFER ALSO TO BUILDING ELEVATIONS, FINISH SCHEDULES AND OTHER ARCHITECTURAL DRAWINGS AND LANDSCAPE FOR FINAL DESIGN AND PROPOSED DETAILS

19/11/01	DESIGN DEVELOPMENT
20/05/10	DEVT PERMIT COORDINATION
20/12/05	ISSUED FOR DP: PRE-APPLICATION
21/04/12	ISSUED FOR DEVT PERMIT APPLICATION

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ARCHITECT:  
**G3 ARCHITECTURE INC.**  
 #130 - 1959 - 152ND STREET  
 SURREY, B.C.  
 V4A 0C4  
 TEL: 604-916-8562  
 EMAIL: gus@g3projects.com

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 DP1225  
 2021-MAY-26  
 Current Planning

**26 UNIT  
 TOWNHOUSE DEVELOPMENT  
 FIREWEEDWAY  
 NANAIMO, BC**


TITLE:  
**RENDERINGS  
 (FOR REFERENCE ONLY)**

SCALE: N.T.S.	DRAWING NO.:
DATE: 21/04/12	<b>A510</b>

BARRETT / 110527



AERIAL VIEW FROM NORTHWEST

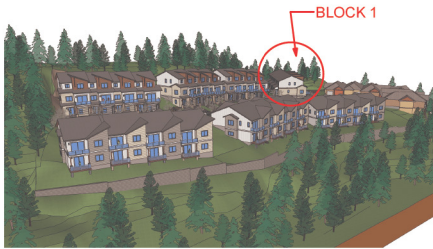


AERIAL VIEW FROM NORTHEAST



FRONT AND SIDE (WEST END) OF BUILDING  
N.T.S.



FRONT AND SIDE (EAST END) OF BUILDING  
N.T.S.

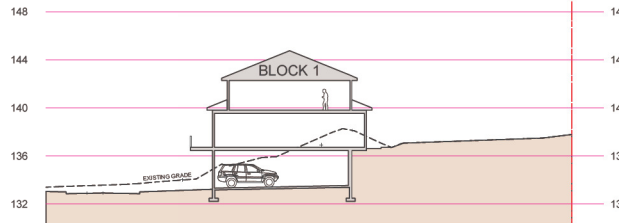

SITE SECTION (SCHEMATIC)  
N.T.S.



REAR OF BUILDING (SOUTH)  
N.T.S.

PROP. BLDG HT  
@ 144.59M

AVG FIN GRADE  
@ 134.82M

PROPOSED BLDG HEIGHT  
= 9.77M

8'-1 1/8"

UPPER FLR

10'-1 3/4"

MIDDLE FLR

10'-1 3/4"

GROUND FLR  
@ 133.655M

FRONT ELEVATION (NORTH)  
3/16" = 1' 0"

UNIT #104

UNIT #103

UNIT #102

UNIT #101

BLOCK #1

AVERAGE FINISHED GRADE

$(133.147 + 133.147 + 136.494 + 136.494) / 4 =$

PROPOSED BUILDING HEIGHT ELEVATION =

PROPOSED BUILDING HEIGHT =

442.32 FT 134.82 M

474.38 FT 144.59 M

32.05 FT 9.77 M

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DP1234  
2021-MAY-26  
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SURREY, B.C.  
V4A 0C4  
TEL: 604-916-8582  
EMAIL: gus@g3projects.com

26 UNIT  
TOWNHOUSE DEVELOPMENT  
FIREWEED WAY  
NANAIMO, BC

TITLE:  
**BLOCK 1  
BUILDING ELEVATIONS  
SITE SECTION**

SCALE: AS SHOWN

DATE: 21/04/12

DRAWING NO.:


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BARRETT / 110027






AERIAL VIEW FROM NORTHWEST

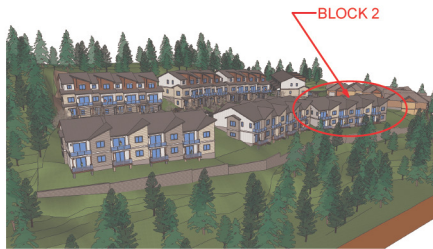


AERIAL VIEW FROM NORTHEAST

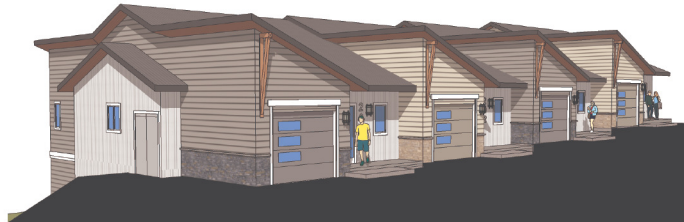

FRONT AND SIDE (WEST END) OF BUILDING  
N.T.S.




FRONT AND SIDE (EAST END) OF BUILDING  
N.T.S.

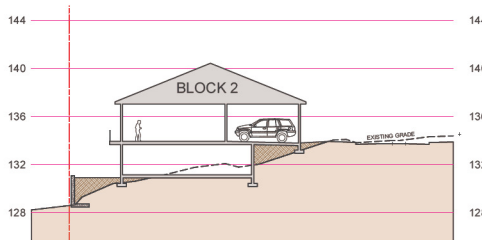

SITE SECTION (SCHEMATIC)  
N.T.S.



REAR OF BUILDING (NORTH)  
N.T.S.

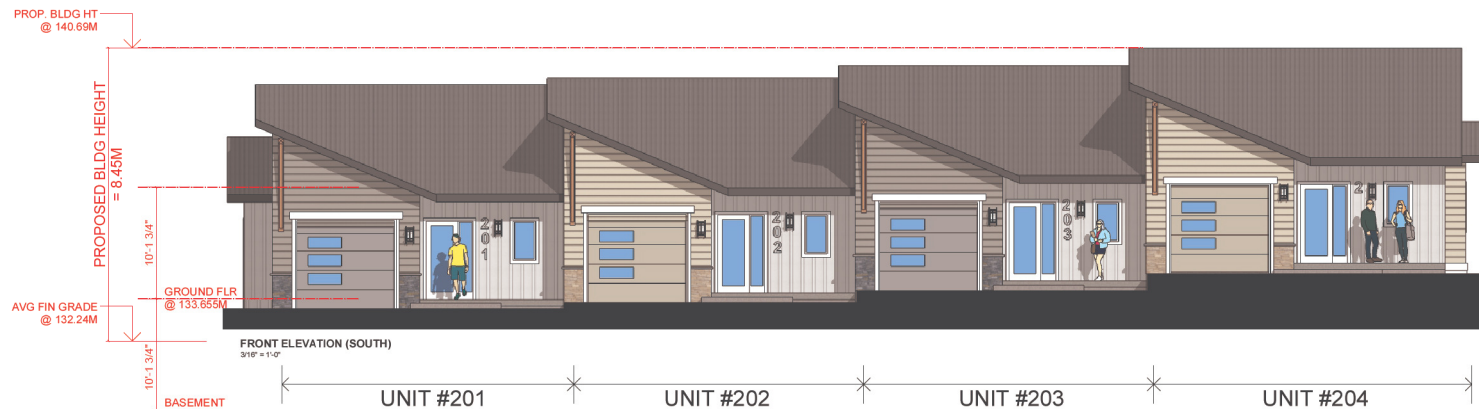

FRONT ELEVATION (SOUTH)  
3/16" = 1'-0"

UNIT #201

UNIT #202

UNIT #203

UNIT #204

BLOCK #2

AVERAGE FINISHED GRADE

$(130.254 + 131.300 + 134.000 + 133.401) / 4 =$

PROPOSED BUILDING HEIGHT ELEVATION =

PROPOSED BUILDING HEIGHT =

433.86 FT

461.58 FT

27.72 FT

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09/12/20  
2021-MAY-26  
Current Planning

19/11/01	DESIGN DEVELOPMENT
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21/04/12	ISSUED FOR DEVT PERMIT APPLICATION

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SURREY, B.C.  
V4A 0C4  
TEL: 604-916-8582  
EMAIL: gus@g3projects.com

26 UNIT  
TOWNHOUSE DEVELOPMENT  
FIREWEED WAY  
NANAIMO, BC

TITLE:  
**BLOCK 2  
BUILDING ELEVATIONS  
SITE SECTION**

SCALE: AS SHOWN

DATE: 21/04/12


DRAWING NO.:

A310

BARRETT / 10027




AERIAL VIEW FROM NORTHWEST

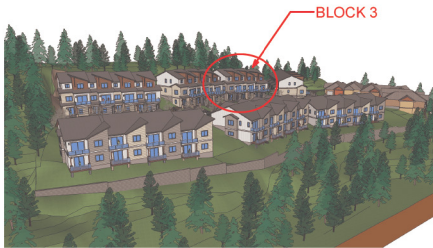

AERIAL VIEW FROM NORTHEAST



FRONT AND SIDE (WEST END) OF BUILDING  
N.T.S.

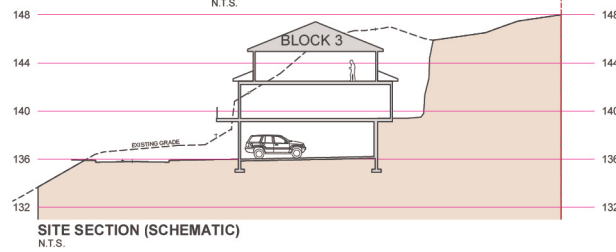

FRONT AND SIDE (EAST END) OF BUILDING  
N.T.S.



REAR OF BUILDING (SOUTH)  
N.T.S.



BLOCK #3  
AVERAGE FINISHED GRADE  
(135.636+136.652+139.999+138.983)/4 = 138.817 M  
PROPOSED BUILDING HEIGHT ELEVATION = 148.09 M  
PROPOSED BUILDING HEIGHT = 28.58 FT

19/11/01	DESIGN DEVELOPMENT
20/05/10	DEVT PERMIT COORDINATION
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21/04/12	ISSUED FOR DEVT PERMIT APPLICATION

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#130 - 1959 - 152ND STREET  
SURREY, B.C.  
V4A 0C4  
TEL: 604-916-8582  
EMAIL: gus@g3projects.com

26 UNIT  
TOWNHOUSE DEVELOPMENT  
FIREWEED WAY  
NANAIMO, BC

TITLE:  
**BLOCK 3  
BUILDING ELEVATIONS  
SITE SECTION**

SCALE: AS SHOWN	DRAWING NO.: A320
DATE: 21/04/12	



UNIT #401

UNIT #402

UNIT #403

UNIT #404

BLOCK #4

AVERAGE FINISHED GRADE

$$(132.300 + 133.769 + 137.500 + 136.347) / 4 =$$

PROPOSED BUILDING HEIGHT ELEVATION =

PROPOSED BUILDING HEIGHT =

442.85 FT      134.98 M

471.26 FT	143.64 M
-----------	----------

28.41 FT      8.66 M

19/11/01	DESIGN DEVELOPMENT
20/05/10	DEVT PERMIT COORDINATION
20/12/05	ISSUED FOR DP: PRE-APPLICATION
21/04/12	ISSUED FOR DEVT PERMIT APPLICATION

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ARCHITECT:



G3 ARCHITECTURE INC.

G3 ARCHITECTURE  
#130 - 1959 - 152ND STREET  
SURREY, B.C.  
V4A 0C4

TEL: 604-916-8582  
EMAIL: gus@g3projects.com

26 UNIT  
TOWNHOUSE DEVELOPMENT  
FIREWEED WAY  
NANAIMO, BC

TITLE:  
**BLOCK 4  
BUILDING ELEVATIONS  
SITE SECTION**

SCALE:

DATE: 21/04/12

DRAWING NO.:	
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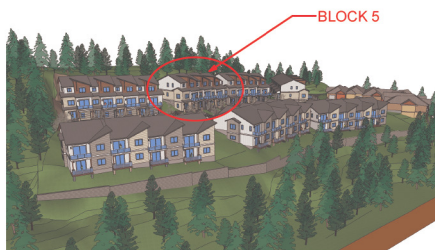
A330

BARNETT / LEON 7






AERIAL VIEW FROM NORTHWEST



AERIAL VIEW FROM NORTHEAST



FRONT AND SIDE (WEST END) OF BUILDING  
N.T.S.

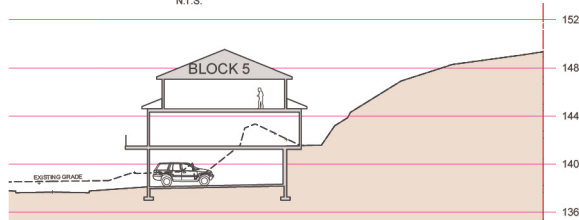

SITE SECTION (SCHEMATIC)  
N.T.S.



FRONT AND SIDE (EAST END) OF BUILDING  
N.T.S.



REAR OF BUILDING (SOUTH)  
N.T.S.



BLOCK #5  
AVERAGE FINISHED GRADE  
(137.26+138.074+141.421+140.609)/4 = 139.838 M  
PROPOSED BUILDING HEIGHT ELEVATION = 149.52 M  
PROPOSED BUILDING HEIGHT = 31.79 FT 9.69 M

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2021-MAY-26  
Current Planning

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21/04/12	ISSUED FOR DEVT PERMIT APPLICATION

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#130 - 1959 - 152ND STREET  
SURREY, B.C.  
V4A 0C4  
TEL: 604-916-8582  
EMAIL: gus@g3projects.com

26 UNIT  
TOWNHOUSE DEVELOPMENT  
FIREWEED WAY  
NANAIMO, BC


TITLE:  
**BLOCK 5  
BUILDING ELEVATIONS  
SITE SECTION**

SCALE: AS SHOWN  
DATE: 21/04/12

DRAWING NO.:  
**A340**

BARRETT / 110527



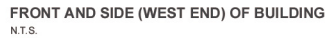

UNIT #601

UNIT #602

UNIT #603

UNIT #604

BLOCK #6

AVERAGE FINISHED GRADE

$$(133.850 + 134.600 + 138.760 + 137.846) / 4 =$$

PROPOSED BUILDING HEIGHT ELEVATION =

PROPOSED BUILDING HEIGHT ELEVATION =  
PROPOSED BUILDING HEIGHT =

447.05 FT      136.26 M

475.16 FT	144.83 M
-----------	----------

473.10 FT	144.63 M
28.12 FT	8.57 M

RECEIVED  
DP1235  
2021-MAY-26  
Current Planning

19/11/01	DESIGN DEVELOPMENT
20/05/10	DEVT PERMIT COORDINATION
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21/04/12	ISSUED FOR DEVT PERMIT APPLICATION

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ARCHITECT:



G3 ARCHITECTURE INC.

#130 - 1959 - 152ND STREET

SURREY, B.C.  
V4A 0C4

V4A 0C4

TEL: 604-916-8582

EMAIL: [gus@g3projects.com](mailto:gus@g3projects.com)

26 UNIT  
TOWNHOUSE DEVELOPMENT  
FIREWEED WAY  
NANAIMO, BC

TITLE:

**BLOCK 6  
BUILDING ELEVATIONS  
SITE SECTION**

SCALE: AS SHOWN

DATE: 21/04/12


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A350


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AERIAL VIEW FROM NORTHWEST




AERIAL VIEW FROM NORTHEAST

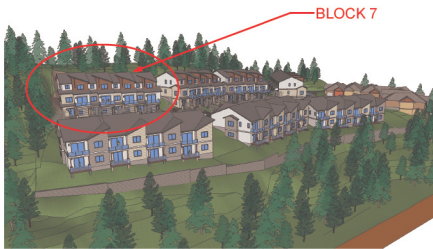

FRONT AND SIDE (WEST END) OF BUILDING  
N.T.S.

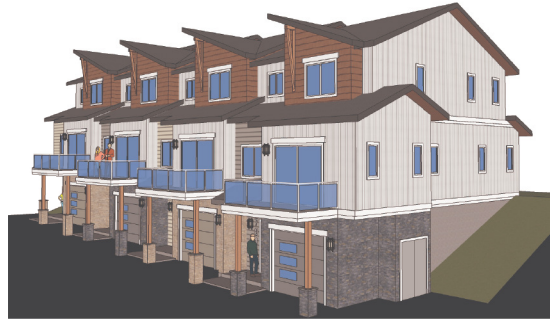

FRONT AND SIDE (EAST END) OF BUILDING  
N.T.S.

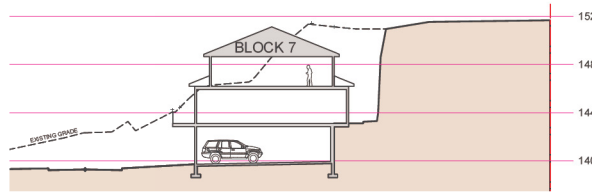

SITE SECTION (SCHEMATIC)  
N.T.S.



REAR OF BUILDING (SOUTH)  
N.T.S.



FRONT ELEVATION (NORTH)  
3/16" = 1'-0"

UNIT #704

UNIT #703

UNIT #702

UNIT #701

BLOCK #7

AVERAGE FINISHED GRADE

$(138.633 + 139.649 + 142.996 + 141.777) / 4 =$

PROPOSED BUILDING HEIGHT ELEVATION =

PROPOSED BUILDING HEIGHT =

461.81 FT 140.76 M

495.70 FT 151.09 M

33.89 FT 10.33 M

PROP. BLDG HT  
@ 151.09M

PROPOSED BLDG HEIGHT  
= 10.33M

UPPER FLR

10'-1 3/4"

MIDDLE FLR

10'-1 3/4"

GROUND FLR  
@ 138.938M

AVG FIN GRADE  
@ 140.76M

19/11/01	DESIGN DEVELOPMENT
20/05/10	DEVT PERMIT COORDINATION
20/12/05	ISSUED FOR DP: PRE-APPLICATION
21/04/12	ISSUED FOR DEVT PERMIT APPLICATION

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#130 - 1959 - 152ND STREET  
SURREY, B.C.  
V4A 0C4  
TEL: 604-916-8582  
EMAIL: gus@g3projects.com

26 UNIT  
TOWNHOUSE DEVELOPMENT  
FIREWEED WAY  
NANAIMO, BC

TITLE:  
**BLOCK 7  
BUILDING ELEVATIONS  
SITE SECTION**

SCALE: AS SHOWN

DATE: 21/04/12

DRAWING NO.:

**A360**

BARRETT / 110027



- 13: GARAGE DOOR  
PAINT FINISH  
COLOR: SW7534  
OUTERBANKS



REFER ALSO TO BUILDING  
ELEVATIONS FOR VARIATIONS OF  
EXTERIOR FINISH CONFIGURATIONS

ARCHITECT:

 **G3 ARCHITECTURE INC.**  
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V4A 0C4

TEL: 604-916-8562  
EMAIL: [gus@g3projects.com](mailto:gus@g3projects.com)

DRAWING NO.:	A400
--------------	------





- 13: GARAGE DOOR  
PAINT FINISH  
COLOR: SW6004  
MINK



REFER ALSO TO BUILDING  
ELEVATIONS FOR VARIATIONS OF  
EXTERIOR FINISH CONFIGURATIONS

SCALE:	N.T.S.	DRAWING NO.:
DATE:	21/04/12	




*Landscape Concept ... Barrington Heights Phases 5, 6, 7, Fireweed Way, Nanaimo*

Situated high on this elevated rocky plateau, the lineal aspect of this multi-unit townhome development provides opportunities for creating individual gardens spaces for each homeowner. Most notable are homes on the north side of Fireweed Way having enlarged south-facing sun patios off the front door where setback depths allow. These small bonus spaces are especially appreciated for enjoying a warm quiet sit-out enclosed by a low front hedge and with lattice screen privacy from the neighbour's driveway. The rear of these same units have a high balcony view of the timbered north ridge over a small individualized private green garden patio at lower ground level.

Homes on the south side of Fireweed have elevated front balconies over the driveway and at the rear and south-facing private generous sun patios and deep grassed yards for personal outdoor space. These rear facing garden patios outlook to a steep rock face buffered by new mixed installation of large conifer and deciduous trees fronted by a long undulating ribbon of seasonal colour mixed-seeded perennial meadow dominated by summer blooming golden California poppy. Boston ivy will be trained upward from the base and Virginia creeper vines from the top down. During winter months, discrete wide-angle up-lighting of the rock face with timed late-night shut off may be developer's option.

The circular social amenity space, an all-white coloured enclosure of post & beam vine arbours and lattice infill panels and low level lighting, provides a inviting meeting spot for neighbours with conversation benches and a small outdoor soft surface play area for visiting grandchildren.

Roadway lighting is a mixture of LED pendant style shielded area lighting and standard tubular bollard lights. See separate site lighting plan.

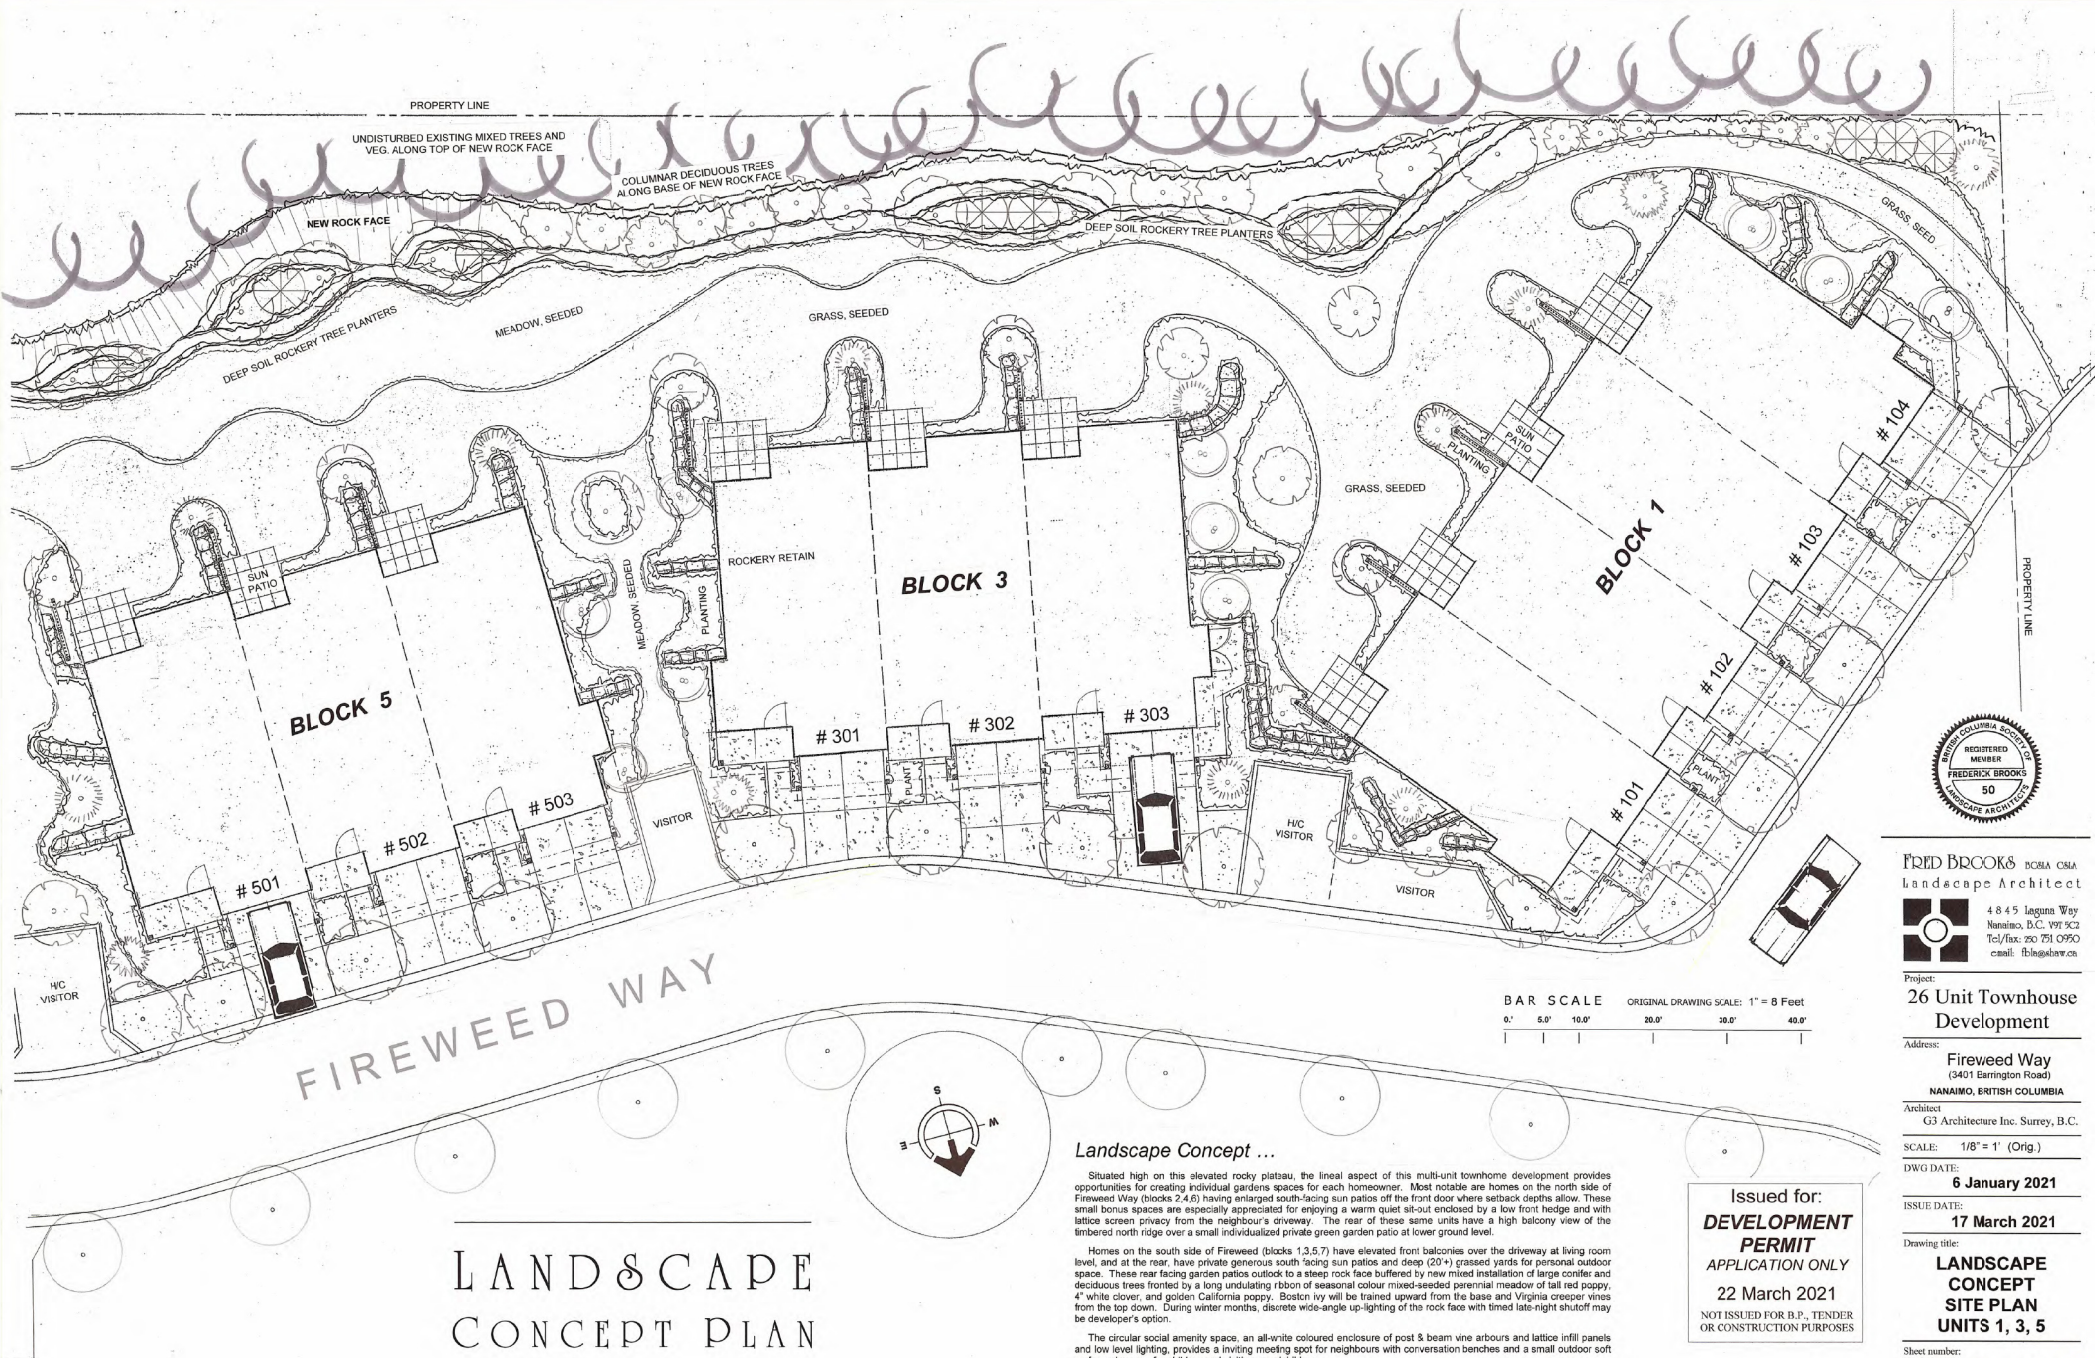

### Landscape Concept ...

Situated high on this elevated rocky plateau, the linear aspect of this multi-unit townhome development provides opportunities for creating individual garden spaces for each homeowner. Most notable are homes on the north side of Fireweed Way (blocks 2,4,6) having enlarged south-facing sun patios off the front door where setback depths allow. These small bonus spaces are especially appreciated for enjoying a warm quiet sit-out enclosed by a low front hedge and with lattice screen privacy from the neighbour's driveway. The rear of these same units have a high balcony view of the timbered north ridge over a small individualized private green garden patio at lower ground level.

Homes on the south side of Fireweed (blocks 1,3,5,7) have elevated front balconies over the driveway at living room level, and at the rear, have private generous south-facing sun patios and deep (20'+) grassed yards for personal outdoor space. These rear facing garden patios overlook to a steep rock face buffered by new mixed installation of large conifer and deciduous trees fronted by a long undulating ribbon of seasonal colour mixed-seeded perennial meadow of tall red poppy, 4" white clover, and golden California poppy. Boston ivy will be trained upward from the base and Virginia creeper vines from the top down. During winter months, discrete wide-angle up-lighting of the rock face with timed late-night shutoff may be developer's option.

The circular social amenity space, an all-white coloured enclosure of post & beam vine arbours and lattice infill panels and low level lighting, provides a inviting meeting spot for neighbours with conversation benches and a small outdoor soft surface play area for children and visiting grandchildren.

Roadway lighting is a mixture of LED pendant style shielded area lighting and standard tubular bollard lights. See separate site lighting plan.



FRED BROOKS INC. B.C. A.S.A.  
Landscape Architect

4845 Laguna Way  
Nanaimo, B.C. V9T 5C2  
Tel./fax: 250 751 0950  
email: fbrooks@shaw.ca

Project:  
**26 Unit Townhouse Development**

Address:  
**Fireweed Way  
(3401 Barrington Road)  
NANAIMO, BRITISH COLUMBIA**

Architect  
**G3 Architecture Inc. Surrey, B.C.**

SCALE: 1/8" = 1' (Orig.)  
DWG DATE:

**6 January 2021**

ISSUE DATE:  
**17 March 2021**


Drawing title:  
**LANDSCAPE CONCEPT SITE PLAN UNITS 1, 3, 5**

Sheet number:  
**L - 1 OF 4**

Issued for:  
**DEVELOPMENT PERMIT APPLICATION ONLY**  
**22 March 2021**  
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2021-MAY-26  
Current Planning



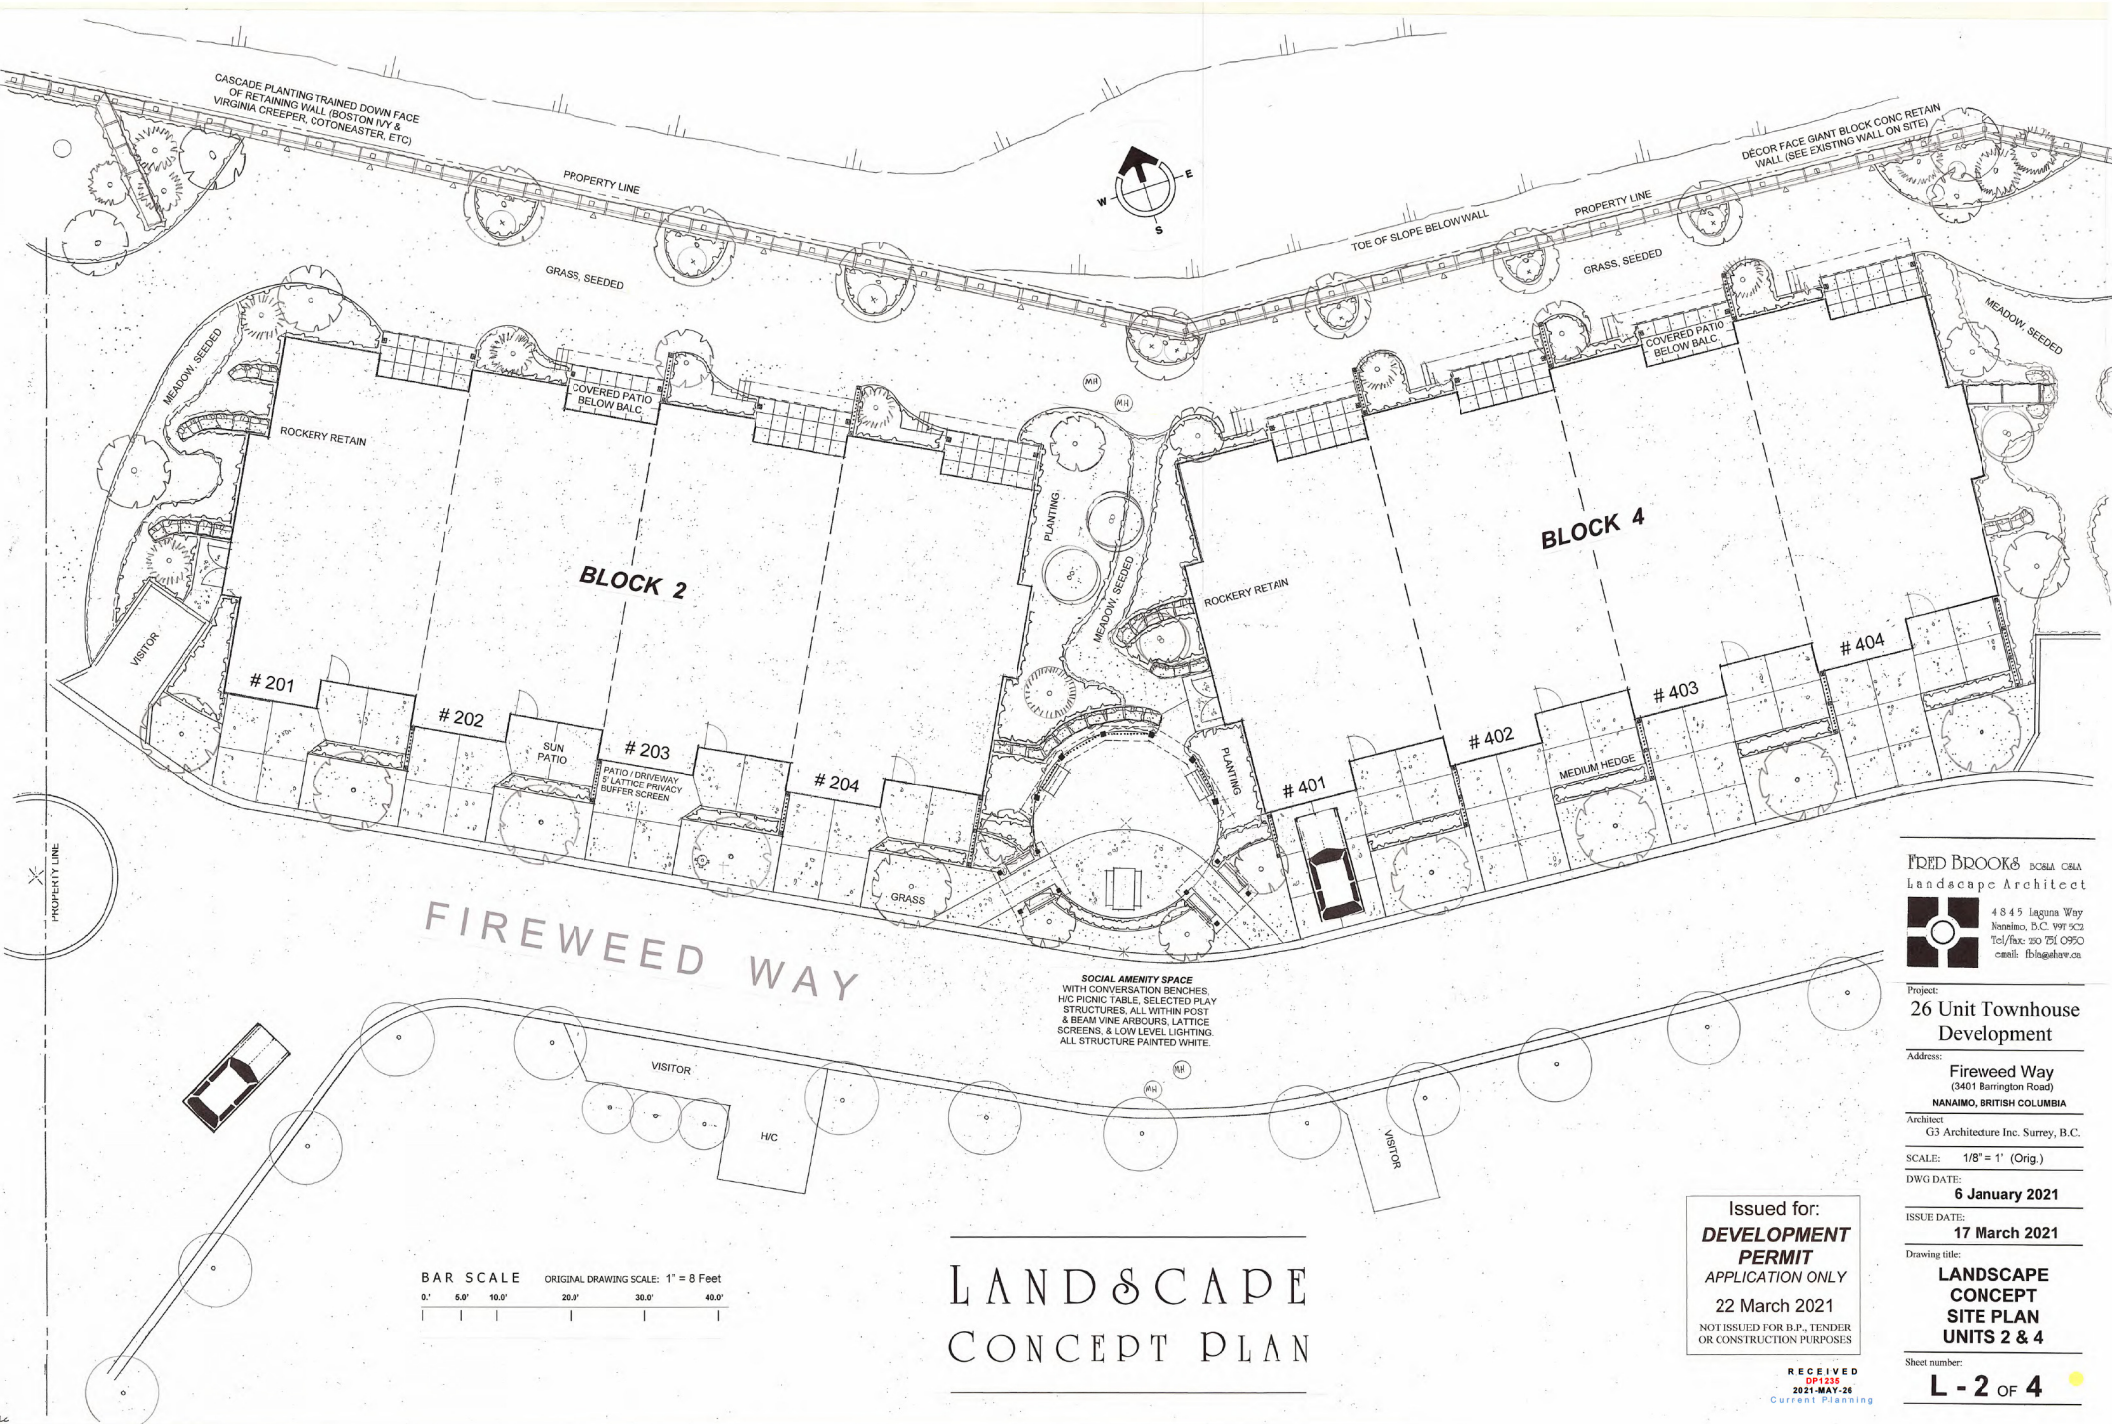

FRED BROOKS DCBIA CMA  
 Landscape Architect



4845 Laguna Way  
 Nanaimo, B.C. V9T 2C3  
 Tel/Fax: 250 751 0950  
 email: f.brooks@laguna.ca

Project:  
**26 Unit Townhouse  
 Development**

Address:  
**Fireweed Way  
 (3401 Barrington Road)  
 NANAIMO, BRITISH COLUMBIA**

Architect:  
 G3 Architecture Inc. Surrey, B.C.

SCALE: 1/8" = 1' (Orig.)

DWG DATE:  
**6 January 2021**

ISSUE DATE:  
**17 March 2021**

Drawing title:  
**LANDSCAPE  
 CONCEPT  
 SITE PLAN  
 UNITS 2 & 4**

Sheet number:  
**L - 2 OF 4**

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 2021-MAY-26  
 Current Planning



# LANDSCAPE CONCEPT PLAN

BAR SCALE ORIGINAL DRAWING SCALE: 1" = 8 Feet  
0' 5' 10' 20' 30' 40'

FIREWEED WAY

BLOCK 6

BLOCK 7

# 604

# 603

# 602

# 601

# 701

# 702

# 703

# 704

# 501

PLANTING

VISITOR

SUN PATIO

GRASS

PATIO / DRIVEWAY

LATTICE PRIVACY BUFFER SCREEN

MEDIUM HEDGE

PLANTING

# 404

NO-POST CONCRETE SAFETY BARRIER  
IN MASSED RHODO PLANTING BUFFER

PASSENGER  
VEHICLE  
TURNAROUND

MEADOW, SEEDING

GRASS, SEEDING

ROCKERY RETAIN

SUN PATIO

PLANTING

FIRE TRUCK  
TURNAROUND



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2021-MAY-26  
Current Planning

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PERMIT  
APPLICATION ONLY**  
22 March 2021  
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OR CONSTRUCTION PURPOSES

FRED BROOKS BSCA CMLA  
Landscape Architect  
4845 Laguna Way  
Nanaimo, B.C. V9T 5C2  
Tel/fax: 250.751.0950  
email: f.brooks@faw.ca

Project:  
**26 Unit Townhouse  
Development**

Address:  
**Fireweed Way  
(3401 Barrington Road)  
NANAIMO, BRITISH COLUMBIA**

Architect:  
G3 Architecture Inc. Surrey, B.C.

SCALE: 1/8" = 1' (Orig.)




DWG DATE:  
**6 January 2021**

ISSUE DATE:  
**17 March 2021**

Drawing title:  
**LANDSCAPE  
CONCEPT  
SITE PLAN  
BLOCKS 6 & 7**

Sheet number:  
**L - 3 OF 4**



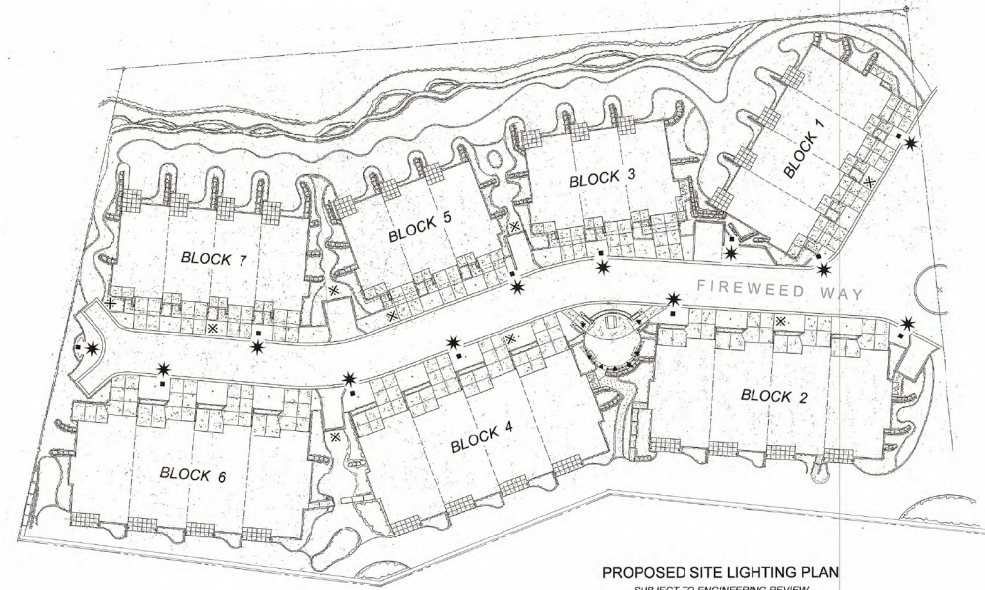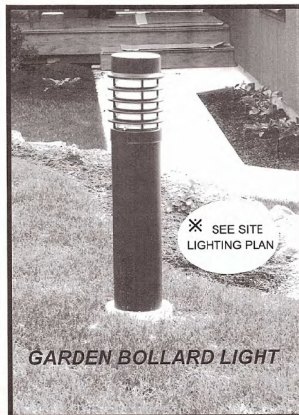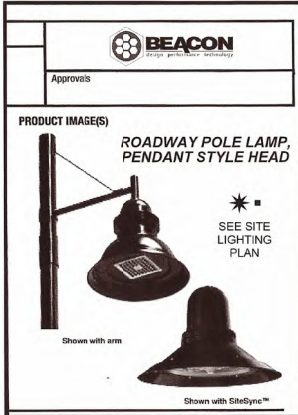

## LANDSCAPE SPECIFICATION

- 1) - Plant material to conform to current BCNTA/BCSLA Guide Spec'n for Nursery stock.
- 2) - Landscape Contractor shall be responsible to locate all underground services prior to any excavation by referencing available civil drawings (by others) or "Call First" line at 1 800 474 6886.
- 3) - Landscape Contractor to provide seven days notice to Landscape Architect prior to commencement of landscape site work to allow for site meeting and drawing review, especially regarding possible building architect change orders and non-conforming site conditions.
- 4) - Landscape Contractor shall ensure that all slopes or paved surfaces which may slope or direct surface water into a landscape area shall not collect or puddle in a soil area but be excavated and removed to an acceptable dispersment or drainage area via a surface swale or French drain.
- 5) - Planting soil for tree wells shall be structurally and nutritionally capable of encouraging health vigorous plant growth. pH shall range from 5.5 to 7.5.
- 6) - Grass areas (turf or seed) shall have 5" new soil base. Shrub planting areas shall have 16" new soil base. New trees shall have 12" (300 mm.) of new soil around and below the root ball. Tree hole excavations shall drain immediately (field test) to prevent root rot, suffocation and drowning. Hardpan subgrades shall be fractured or trenched to an approved run-off destination before topsoil placement.
- 7) - If B&B, cut all cords and peel back or cut away B&B sacking, and trunk wrap.
- 8) - Apply 'Acer' slow release pellet fertilizer over all planting areas per manufacturer's instructions before applying max. 2" of approved landscape mulch over planting areas.
- 9) - Stake all trees to 6 foot height (1.8m) with approved wood or steel stakes and non-abrasive and non-constricting ties. Nursery pot stakes are not acceptable.
- 10) - Install approved tree stem bark protectors (Arborguard or equal) on all trees in grass or turf areas which will be at risk of weed-eater type tools, lawnmower strikes, and deer or rodents.
- 11) - Remove all nursery marker flags but leave on plant name tags.
- 12) - All plant material shall be guaranteed in writing to the owner for one year against death due to unhealthy supply and/or improper installation conditions and/or wrong selection of species or variety or plants. One year period begins at date of Landscape Contractor's final invoice.

Landscape Contractor: \_\_\_\_\_ Date: \_\_\_\_\_

## AUTOMATIC LANDSCAPE IRRIGATION SPECIFICATION

**WORKMANSHIP** Fred Brooks BCLA Nainaimo, BC ©  
PROPOSED LANDSCAPE IRRIGATION IS A BELOW-GRADE DRY SYSTEM, 1 ZONE PER BLOCK, ALL ON SEASONAL TIMER CONTROL. NO POP-UP OR SPRAY HEADS. A DETAILED SPECIFICATION WILL ACCOMPANY TECHNICAL LANDSCAPE DWGS.

The objective is to supply the required amount of water to the landscape planting / soil areas for the successful establishment and continued health of all existing and new plant material without under-watering, over-watering or missed spot watering due to either design, parts or installation factors, timing controls or blockage or screening by existing or new plant material, structures or site grading & contours. It is recommended that the bidder carefully review the site and bid documents and base his price on the overall intent of the drawings and these specifications.

The responsibility of an acceptable operating system rests solely with the on-site installer of the system, and not the designer, unless they are the same party.

Therefore, compliance with or deviation from any drawings is not an acceptable reason for lack of owner's acceptance of part or all of the system when it is charged & declared operational. The landscape irrigation contractor/installer shall ensure the delivery of a fully functional system with all trees and plants receiving adequate water for a healthy landscape.

All system to be single manufacturer brand, TORO quality or approved equal. Be aware that the use of 'thin wall' piping is usually not a savings for the owner in the long run. Selection & use of optimum materials and best workmanship methods in the beginning will usually result in a quality job, avoiding call-backs and plant failure problems when plant material is under landscape's warranty. **Note on your bid what wall thickness & brand of piping you are proposing to use, as this will be confirmed at installation.**

1.2 - Locate all U/G control valve boxes in convenient but unobtrusive locations.

1.3 - I.C. shall ensure that all new trees receive not less than 4 litres of water daily during summer growing season, and more water if subject to dry, hot or wind desiccating environment.

1.4 - Irrig. Contr. shall provide two sets of "as-built" irrigation drawings and specifications to owner prior to acceptance of system, and provide one copy of manufacturer's control station manual to owner and leave one copy securely attached to controller in clear protective case.


1.5 - Irrig. Contractor shall provide one year warranty on workmanship and all parts of the system from date of first operational start up of the system, with confirming letter to owner.

1.6 - A signed copy of this spec. shall be attached to your quote. I.C. \_\_\_\_\_ Date: \_\_\_\_\_


## BARRINGTON PHASES 5,6,7

### LANDSCAPE PLANT LIST FOR SELECTION AT WORKING DWG STAGE

BOTANICAL NAME	COMMON NAME	SIZE
<b>TREES - DECIDUOUS</b>		
Acer rubrum	red maple	15'
Acer circinnatum	vine maple	5'
Acer palmatum atropurpureum	Jaguar maple, red	15'
Carpinus betulus 'testagata'	columnar hornbeam	7'
Cornus nutallii 'edgii'	Dogwood Edin's white wonder	15'
Magnolia stellata	Star magnolia	5'
Populus tremuloides	trunking aspen	7'
Prunus Shirotae	flowering cherry	7'
Saphora japonica regent	Pagoda tree	15'
<b>TREES &amp; SHRUBS - CONIFEROUS</b>		
Pinus nigra 'fastigiate'	Austrian pine 'upright'	7'
Sciadopitys verticillata	Japane umbrella pine	7'
Pinus mugo	mugo pine	5'
Juniperus Chama. 'gold thread'	juniper	3'
Pseudotsuga menziesii	Douglas fir	5'
<b>SHRUBS - BROAD LEAF EVERGREEN</b>		
Acacia japonica 'gold spot'	gold spot acacia	3'
Eucalyptus 'emerald & gold'	low ft. variety	2'
Eucalyptus 'emerald gaeley'	med ft. variety	2'
Rhodod. - mid-size habit	rhododendron, mid	5'
Rhodod. Roseum Elegans	rhodod. Todd select	5'
Persea japonica 'Mtn. Fire'	illy valley shrub	3'
Prunus laurocer. 'zabellian'	Zabell's laurel	3'
Skimmia reevesiana	skimmia	3'
Viburnum davidi	viburnum	3'
<b>SHRUBS - DECIDUOUS</b>		
Rosaesae, semi-deciduous	Maiden rose	3'
Hydrangea macrophyllum	hydrangea	3'
Magnolia stellata	star magnolia	3'
<b>GROUNDCOVER &amp; VINES</b>		
Fern varieties	large evergreen	1'
Salix (Willow)	large (Willow)	1'
Mahonia aquifolium	Oregon grape	1'
Mahonia nervosa	Mahonia, low	1'
Parthenocissus tri	Boston ivy, walls	1'
Parthenocissus cinerea	Virginia creeper	1'
Clematis varieties, mixed	clematis vine	1'
Seeded wildflower meadow mix from Richardson Seed		
<b>PERENNIALS</b>		
Rudbeckia 'goldstrum'	Rudbeckia, Leucanthemum	1'
Other perennial selections at planting time		

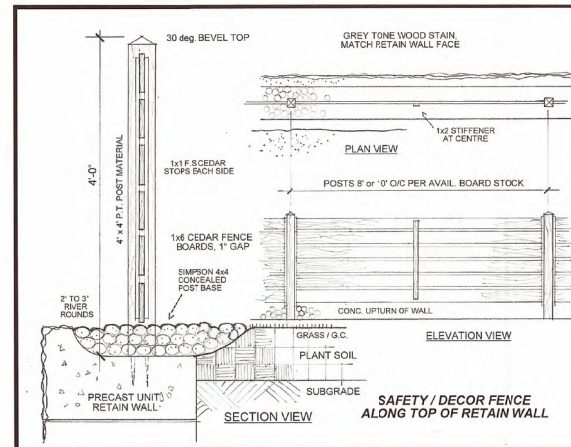

**FRED BROOKS BCLA**  
Landscape Architect

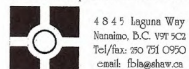

Project:  
**26 Unit Townhouse Development**

Address:  
**Fireweed Way  
(3401 Barrington Road)  
NANAIMO, BRITISH COLUMBIA**

Architect:  
G3 Architecture Inc. Surrey, B.C.

SCALE: **SEE DETAILS**  
DWG DATE: **6 January 2021**  
ISSUE DATE: **17 March 2021**

Drawing title:  
**LANDSCAPE SITE LIGHTING & DETAILS**

Sheet number:  
**L - 4 OF 4**


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2021-MAY-26  
Current Planning

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22 March 2021  
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This is an aerial map of a residential neighborhood. A red outline highlights a specific area in the center-left. The map shows several streets with house numbers labeled. The streets include MYRTA PL, BARRINGTON RD, ELWORTHY PL, LAUREN MARY PL, MARIPOSA DR, FIREWEED WAY, STONEY RIDGE, and EDGEWOOD DR. The house numbers are visible throughout the map, ranging from 3230 to 3750. The red outline highlights a specific area, possibly a property or a group of properties, within the neighborhood.



 3401 BARRINGTON ROAD