

111 Chelan Place, Nanaimo B.C. V9R 6S2 info@familytreedevelopments.ca 250-797-6469

July, 07, 2021

<u>Design Rationale – Hansen Road Development</u>

Project:

Phase 1: (15 buildings with 49 residential units total)

- 10 2 storey triplexes,
- 4 3 storey 4 plexes,
- 1 3 storey 3 plex.

Phase 2:

2 – 42 unit 4 storey residential buildings

Project Background:

- Residential rental.
- Access to public transit on two roads.
- Provides new paved pathway which will bridge the existing bicycle network off Caspers Way to the Parkway Path.
- OCP consideration.
- As per rezoning.

Site Layout:

- Views (Mt. Benson, Nanaimo Parkway above VIU, sunsets)
- Consideration to adjacent properties (uses, views, privacy)
- Setbacks, SRWs, ROWs.
- Perimeter plantings of trees and shrubs provide privacy screening and buffering between neighbouring residence.
 Tree and shrub species have been selected for their aesthetic attributes, drought tolerance and ease of maintenance.
- · Neighbouring properties considerations.

Pedestrian Circulation:

- Town homes are spacious open concept layouts.
- Back yards with landscaping provided.
- Public walk-thru access from East Wellington Road to Bowen Road.
- Street lights along public pathway.
- Phase 2: Loop pathway and road with Park in north-east corner.
- Loop gravel path at south-west corner of lot with benches, goes around swale.
- Three seating spaces with benches are located near both rain water detention areas, and at the internal road intersection near Building 14. A fourth seating area will be provided in Phase 2 of project, at north-east corner or lot in proposed park.
- Phase 2: Fenced dog run with two gates at north-east of lot.

Vehicular Circulation:

- Phase 2: Loop road connecting to end of Hansen Road.
- Trees along road provide buffer for lights at night.
- Phase 1: Fire truck access is accounted for with Road 2 to be used as three-point turn around.
- Phase 1: Fire truck access will be a full loop road connecting to the currently proposed cul-du-sac at end of Hansen Road.
- Garbage Truck access is accounted for.

Parking:

- All required parking is provided within garages and 20' driveways at front of each town home unit.
- · Visitor Parking provided.
- Bike parking within garages.

Form:

- The site topography generally falls north to south at approximately 4-5%.
- Phase 1: Retaining block wall at south with black chainlink on top, and perimeter buffer planting. This will replace
 existing wood fence when it is at the end of its life span.
- Phase 2: Retaining wall at north with perimeter buffer planting.
- The town homes make up the low slope with varying height patios at the back, most of which will be under 2ft off finished grade.
- The 10 2 storey triplexes along the south property line do not have L2 decks to maintain privacy from neighbouring property. The oversized patios at the back provide a spacious outdoor area instead.
- Two roof profile options per building type.
- Units jogged in and out to break up mass of buildings.
- Southern exposure.
- Views of Mt. Benson.

Materials & Colour:

- Colour pallet options to differentiate buildings.
- Varying entrance door types and colours.
- Varying garage door types and colours.
- Metal unit numbers with focus lighting.
- Tones of colour that compliment surroundings, and do not compete with views.

Exterior Lighting:

- Street lights.
- Individual garage lights for unit numbers and easy scanning.
- Lights at patios.
- Directional down lights on decks, minimizing lighting onto adjacent units.


Utilities/ Garbage/ Recycling:

- Building servicing located close to utility connections to reduce service lengths.
- Individual cans at town homes, to be stored within garages.
- · Common room for property management meetings, and service providers.

Key Features:


- Epic views.
- Great walk ability to restaurants, grocery stores, liquor stores etc.
- Access to three BC Transit bus routes.
- Access to Parkway Path connecting all the way to Woodgrove mall.
- Common room for residents to use for events and gatherings.

CONTEXT MAP

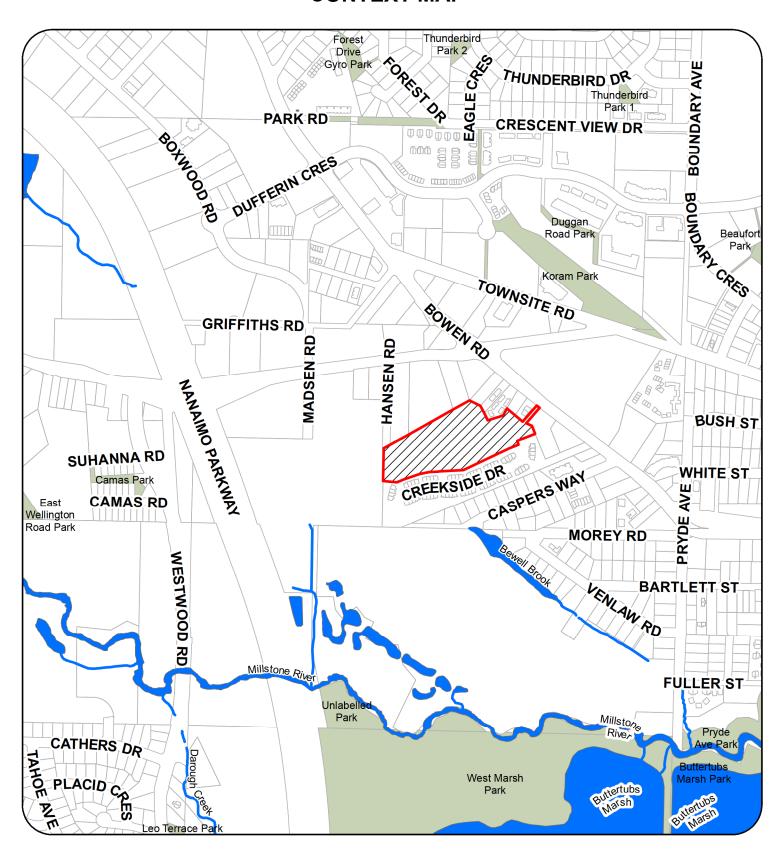



LOCATION PLAN

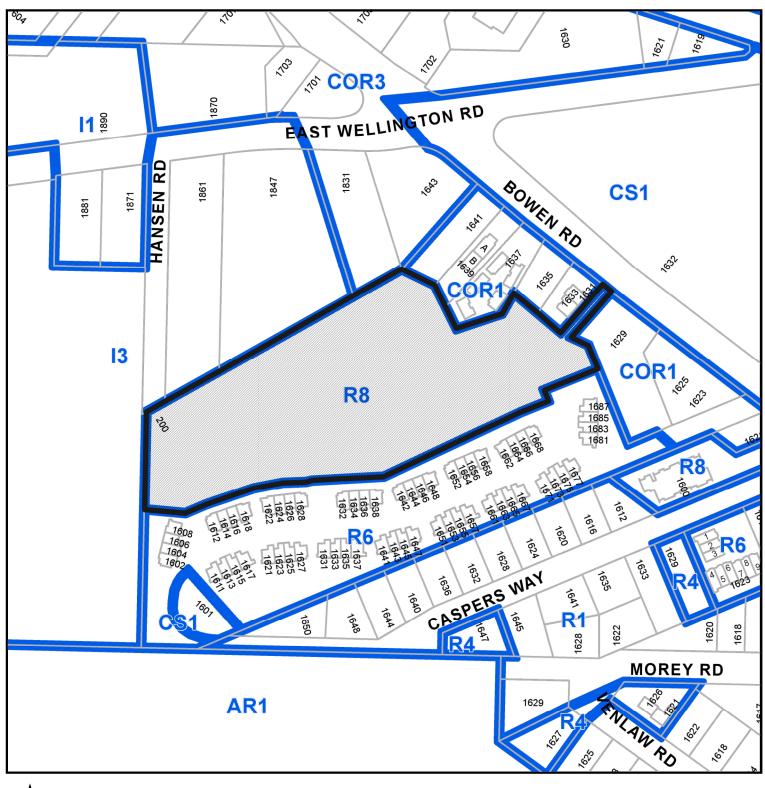



DEVELOPMENT PERMIT APPLICATION NO. DP001233

Subject Property

CIVIC: 200 HANSEN ROAD

LEGAL: LOT B, SECTION 14, RANGE 8, MOUNTAIN DISTRICT, PLAN EPP76054





Notes:
1. Aerial Photo from City of Nanaimo GIS Maps 2018

Drawdon List:
Architectural:
AGD - Core Page Consultant List. Drawing list.
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KSG Conulsting Linited Ken Grewal & Alan Seerves 4-2535 McCullough Road, Nanaimo, B.C. V98 448 P: 250-755-9437 E: ksgconsulfingltd@gmail.com

J.E. Anderson & Associates Scott Stevenson #1A - 3411 Shenton Road, Nan B.C. V9T 2H1 P: 250-758-4631

Landscape Architect:
J.E. Anderson & Associates
Scott Stevenson
#1A - 3411 Shenton Road, Nanaimo,
B.C. V9T 2H1
P. 280, 798, 4831

Environmental: Toth & Associates Environmental Steve Toth 6821 Harwood Drive

Lantzville, B.C. VOR 2H0 P: 250-390-7602 E: stoth@shaw.ca

Rasila Herman
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B.C. V9R 682
P: 250-797-6469
E: maia@familytrenomes.ca

family tree developments

39 Videois Cressons, Namism, B.C. VIR 989

10 10 70 Feb (1998)

11 2021 05 11 DP Application

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Date Revision Notes

Hansen Road Development
Nanaimo
200 Hansen Road, Nanaimo, B.C.
Lot B, Section 14, Range 8, Mountain District, Plan EPP76054

Sheet Title


Cover Page Consultant List Drawing List

RECEIVED
DP1233
2021-MAY-11
Current Planning

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		Pro	ject Data					
Project Description:	Hansen Road Devel	lopment	: 1	Phase 1 of	2			
Civic Address:	200 Hansen Road, Nana							
Legal Address:	Lot B, Section 14, Range		ain District, I	Plan EPP76054	<u> </u>			
Zoning:	R8 – Medium Density Re	sidential						
Property Area: 200 Hansen Road, Nanaimo, B.C.			ft2 284,709	m2 26.450.29	6.54	Notes:		
- National Road, Indianio, D.C.			0	0.00	0.00	N/A		
Total Area:			284,709	26,450.29	6.54			
				_				
Building Type: A1 GFA	Qty of Building Type:	7	ft2	m2		Notes:		
Floor L1 - Including Area of Garage			2,637	244.96		Area per Garage: ft2	2	280
Floor L2			2,551	237.04				
Floor L3			0	0.00		N/A		
Total Building: GFA			5,188	482.00		0. 1		
Total Building Excluding Garages: G Total Quantity of Building Type: GFA			4,349	403.99 2.827.94		Qty of garages: 3 Excludes Area of Ga	rance for EAD cal	la .
Total Quantity of Building Type. GrA	·		30,440	2,827.94		Excludes Area of Ga	rages for PAR cal	IC.
Building Type: A2 & A3 GFA	Qty of Building Type:	3	ft2	m2		Notes:		
Fioor L1			2,637	244.96		Area per Garage: ft2	2	280
Floor L2			2,563	238.13				
Floor L3			0	0.00		N/A		
Total Building: GFA			5,200	483.09				
Total Building Excluding Garages: G	FA		4,360	405.09		Qty of garages: 3	U. w	
Total Quantity of Building Type: GFA	\		13,081	1,215.26		Excludes Area of Ga	rages for FAR cal	lc.
n .			l			l		
Building Type: B1 GFA	Qty of Building Type:	1	ft2	m2	1	Notes:		
Floor L1			2,910	270.33		Area per Garage: ft2	2	224
Fioor L2			2,805	260.62	-			
Floor L3			2,789	259.13				
Total Building: GFA Total Building <u>Excluding</u> Garages: G	EA		8,504	790.08		Qty of garages: 4		_
Total Quantity of Building Type: GFA			7,608 7,608	706.76 706.76		Excludes Area of Ga	range for FAR cal	lc.
Total quality of building Type. Of A	·		7,000	700.70		Excludes Alea of Ca	rages for Free ca	
Building Type: B2 & B3 GFA	Qty of Building Type:	3	ft2	m2		Notes:		
Floor L1			2,910	270.33		Area per Garage: ft2	>	224
Floor L2			2,795	259.63		raca per carage. Ita	-	224
Fioor L3			2,779	258.14				
Total Building: GFA			8,483	788.10				
Total Building Excluding Garages: G	FA		7,586	704.78		Qty of garages: 4		
Total Quantity of Building Type: GFA	1		22,759	2,114.34		Excludes Area of Ga	rages for FAR cal	lc.
			1		1	I		_
Building Type: C GFA	Qty of Building Type:	1	ft2	m2		Notes:		
Floor L1			2,187	203.22	_	Area per Garage: ft2	2	224
Floor L2			2,112	196.20	_			_
Floor L3 Total Building: GFA			2,104 6,403	195.45 594.87	_			
Total Building Excluding Garages: G	FA		5,730	532.38	_	Qty of garages: 3		_
Total Quantity of Building Type: GFA			5,730	532.38		Excludes Area of Ga	rages for FAR cal	lc.
, , , , , , , , , , , , , , , , , , , ,			10,1.00	1000.00				
Combined Building Areas:	Total Qty of Buildings:	15	ft2	m2		Notes:		
Total GFA: excluding garages			79,617	7,396.68		Used for FAR.		
Total GFA: including garages			92,273	8,572.48		Total garage area:	12,656	
		+			Area Total:			_
Floor Plan Types:	Description:	Qty:	ft2	m2	ft2	Notes:		
Type 01	3 bed, 3 bath, 2 storey	27	1,730	160.70	46,704			
Type 02	3 bed, 3 bath, 2 storey	3	1,742	161.80	5,225			
Type 03	3 bed, 3 bath, 3 storey	7	2,143	199.12	15,003			
Type 04	3 bed, 3 bath, 3 storey	9	2,104	195.42	18,932			
Type 05	3 bed, 3 bath, 3 storey	3	2,122	197.14	6,366			_
Residential Units Total Quantity:	-	49	-	0.00	92,230			-
Residential Onits Total Quantity.		49			92,230			_
Zoning Requirements:	Required / Allowed:	Propo	sed:	Notes:				
Site Coverage:	40%	14%						
Floor Area Ratio: 1.25	1.25	0.28						
Front Bldg Setback	6.00 m	С		See Site Pla	n .			
Flanking Bldg Setback	4.00 m	С		See Site Pla	en .			
Side Bldg Setback	3.00 m	С		See Site Pla				
Rear Bldg Setback	10.50 m	c		See Site Pla	an .			
Underground Parking Setback	1.80 m	0		N/A				
Max Building Height	14.0 m	0		See Site Ele	evations			
Number of Storeys	N/A	2 & 3						
Notes:								
Red = Variance								
		_						_


	Vehicle Park	king Requirements			
Location: Area 2					
Unit Description	Required	Res. Unit Qty	Required	Proposed	Notes:
Studio / Micro	1.05	0	0	-	
1 bed	1.26	0	0	-	
2 bed	1.62	0	0	-	
3 bed	1.84	49	90	111	Private + visitor stalls
Total Parking:		49	90	111	
Parking Stall Type	Required / Allowed	Proposed:	Proposed:		Notes:
Regular car (60%)	54	98		-	
Small car (40%)	36	-	-		
Drop off / Loading	-		-		N/A
Handicapped	-	-	-		N/A
Electric Vehicle (EV) (10%)	-	-	-		N/A
Electric Vehicle Rough-in (20%)	-	-	-		N/A
EV Level 1 Charge (1 per dwelling unit)	49	49	49		Bylaw 7266, 7.7.iii
Visitor Space (1 per 22 req'd stalls)	4	13	13		
Motorcycle / Scooter	-	-		-	
	Bicycle Pari	king Requirements			
	200,000	3			
Parking Stall Type	Required / Allowed	Proposed:	Proposed:		Notes:
Short Term (0.1/unit)	5	-			Bylaw 7266, 7.6
Long Term (0.5/unit)	25	-	-		
Subtotal:					




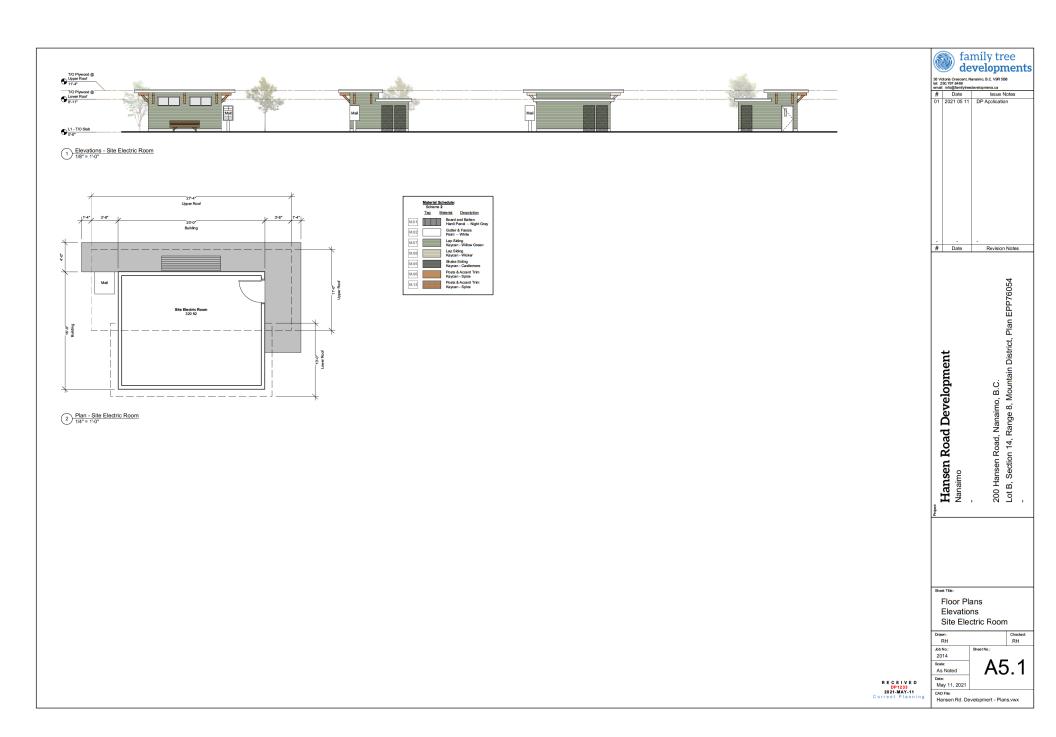






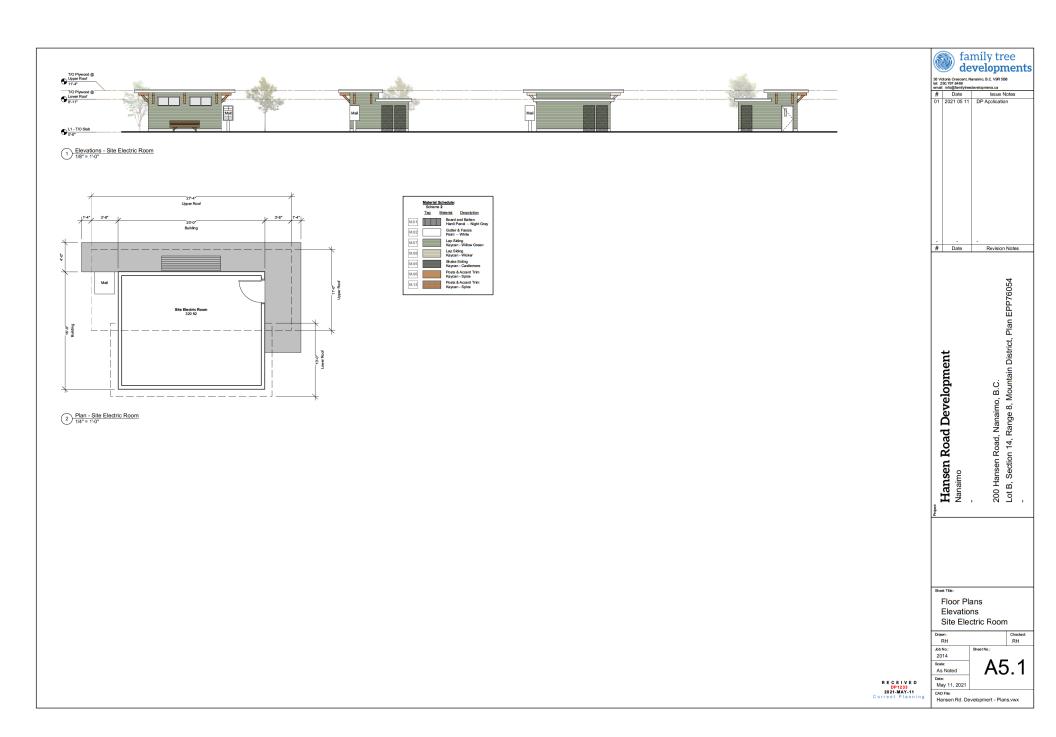

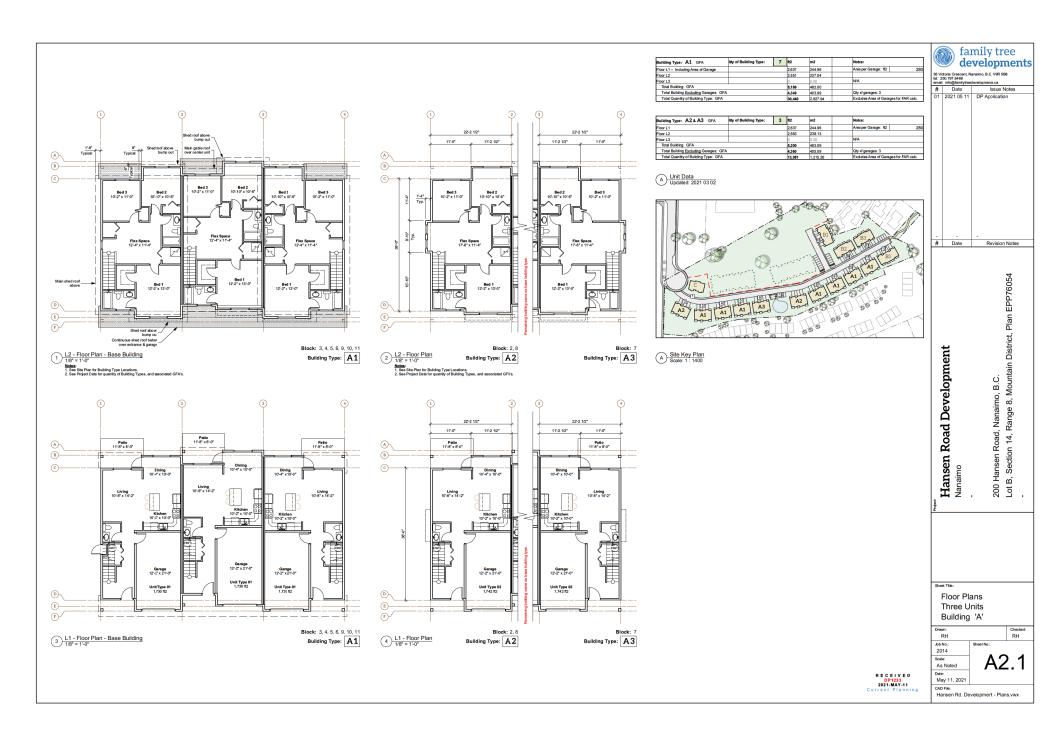



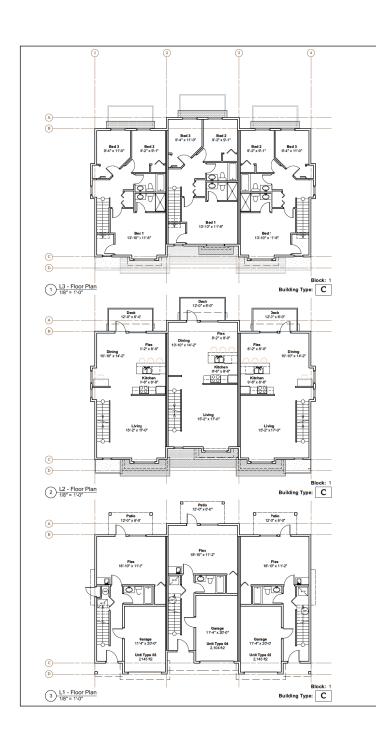


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Floor L1			2,187	203.22		Area per Garage: ft2	22
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Total Building: GFA		6,403	594.87				
Total Building Excluding Garages: GFA		5,730	532.38		Qty of garages: 3		
Total Countity of Building Type: CEA		£ 700	F00 00		Eveludes Associat Core	and for EAD sale	

A Unit Data Updated: 2021 03 02



A Site Key Plan Scale: 1: 1400

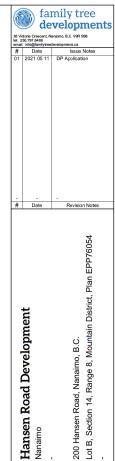

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Current Planning	

eet Title:	
Floor Plans	
Four Units	
Building 'C'	
	-

Hansen Road Development


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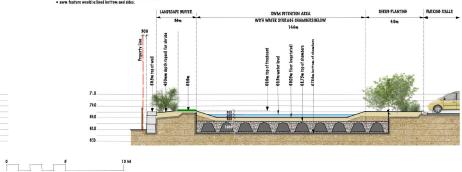


SECTION 1 SWM PETENTION AREA #1 Scale 1: 100


Ford at a surface area when flooded 250 sq.m.
typ of freeboard 68.3m
over flow -68.5m
facr - 68.0m
300mm soll over bottom of pond
bittom of drain rock - 670m



SECTION 2 SWM PETENTION AREA #4 Scale 1: 100

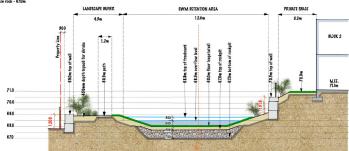


SECTION 3 THROUGH REAR GARDEN SPACE & BLOCK 13 Scale 1: 100

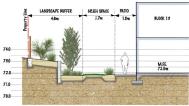

PLANT SCHEPULE

BOTANICAL NAME	COMMON NAME	CALIPER/HT.	QUANTITY
TREES			
HANSEN ROAD			
QUERCUS GARRYANA	PARRY DAK	40M GAL	7
SITE TREES - DECIDUOUS			
BETULA PAPYRIFERA	TAPERBARK BIRCH	50M CAL	
ORATAGOUS X LAVALLEI	LAVALLE HAWTHORN	50M CAL	
MAGNOLIA X VULCAN	TULCAN MARNOLIA	4CM CAL	
NYSSA SYLVATICA	PLACK TUPELO TREE	4CM CAL	
PARROTIA PERSICA VANESSA	MANESSA PERSIAN IRONWOOD	40M CAL	
THE PERSON NAMED OF THE PE	311134117111111111111111111111111111111	APPROX TOTAL #	51
SITE TREES - CONIFEROUS			
PICEA OMORIKA "BRUNS"	SERBIAN SPRUCE	420 POT, 2.0m	21
SMALL TREES / SPECIMEN SHRUBS			
AE BUTUS UNEDO "COMPACTA"	STEAMBERRY TREE	#1.5 POT	
MALUS 'APIRONDACK' / "ROYAL RAINDROPS"	IZAB APPLES VARIETIES	#10 POT	
SYRINGA CHARLES JOLY	ULAC	#10 POT	
OI KIRWA WINKERS WILL	иъно	APPROX. TOTAL *	40
PERIMETER SHRUB PLANTING, 1088 sq.m. plant	ted at 1 per 1 Sm2	APPROX. IUIAL F	70
GAULTHERIA SHALLON	SALAL	e1 POT	_
MAHONIA AQUIFOLIUM	OREGON GRAPE	#2 POT	
PHILADELPHUS LEWISII	MOCK ORANGE BLOSSOM	43 POT	
PHYSOCAR PUS CAPITATUS	MCIFIC NING-BARK	#2 POT	_
RIBES SANGUINEUM	LOWERING REDGUERANT	#1 POT	
ROSA NUTKANA	NOOLKY KORE	e1 POT	
ROSA RUPOSA	SHRUB ROSE, REP SCENTEP FLS	#3 POT	
SYMPHORICARPOS ALBUS	SNOWBERRY	a1 POT	
		APPROX. TOTAL .	725
FRONT & REAR YARD PLANTING, total area 130- SHRUBS & ORNAMENTAL GRASSES - 65% area F			_
CALAMAGEOSTIS "KARL FORESTER"	FATHER REED OF ASS	#1 POT	
CHOISVA TERNATA	MEXICAN OF ANGE BLOSSOM	al POT	_
CISTUS "DE AVSWOOD PINK"	PINK FL ROCK ROSE	#1 POT	_
HYPRANDEA QUERCIFOLIA	BAK LEAF HYDE ANGEA	#3 POT	_
MISCANTHUS SINGNSIS 'DE ACILLIMUS'	JAPANESE SILVEZ OZ ASS	#2 POT	_
MANDINA DOMESTICA 'MOON BAY'	MOON BAY HEAVENLY BAMBOO NON FLOWERING	#2 701	_
SPIREA JAPONICA "GOLPMOUND"	SPIREA	#2 POT	_
VIBUR NUM BOONANTENSE 'DAWN'	FORNANT VIBURNUM	45 POT	_
VIBURNUM CARLESII	TOREAN SPICE BUSH (FRAGRANT)	45 POT	_
TIPOKITOM OVERSEGII	NORSHIN OF THE PUBLI II KNOKNIKI /	APPROX. TOTAL *	848
GROUNDCOVER PLANTS / PERENNIALS - 35% ar	rea planted at 2 per 1m2 (456 som)	AFFROX. TOTAL	979
ARCTOSTAPHYLOS UVA URSI	CINNIKINNIK	a1 POT	
COTONEASTER "CORAL BEAUTY"	LOW OROWING COTONEASTER	al P01	
CORNUS SERICEA "KELSEYI"	PWARE KEP TWIG POGWOOP	#1 POT	
KNIPHOFIA PAPAYA POPSICLE	TWARF TORCH LILY	a1 POT	
MAHONIA NERVOSA	FULL OREGON GRAPE	APPROX. TOTAL *	912

PERIMETER SOLID WOOD FENCE Scale 1: 20

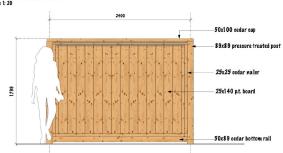

REPLACEMENT TREES

Refer to the free Management Report Prepared by Toth and Associates for tree resource information.

Total number of trees to be removed * 96

Total number of trees to replace * 49 comprising:

Obusiferous - 15 frees, the landscape plan proposes 21 trees.


Pecidious - 34 frees, the landscape plan proposes 51 medium size trees \$

40 small tree species / specimen shrubs.

Trees shall be maintained for a minmum of 2 years.

PLANT SCHEPULE
The plant species, sizes and quantities identified in the plant schedule are indicative of the planting concept.
Petalled planting plans will be prepared for all areas for the Building Permit application, and will include plant species, sizes at the time of planting and quantities.

REAR/SIDE YARD PRIVACY FENCE Scale 1: 20

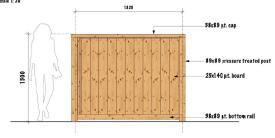

SMALL & ROSSELL LANDSCAPE ARCHITECTS INC

3012 manzer road, sooke, b.c., v9z 0c9 t: 250-642-6967

design@smallandrossell.com www.smallandrossell.com



FENCE DETAILS & PLANT SCHEDULE Drawn By SRLA Scale As shown

Townhouse Development,

Sheet Title CROSS SECTIONS,

RECEIVED DP1233 2021-MAY-11 Current Planning

AERIAL PHOTO





DEVELOPMENT PERMIT APPLICATION NO. DP001233



200 HANSEN ROAD