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February 3, 2020

For the attention of:

Lainya Rowett

Manager, Current Planning Section Development Approvals Department City of Nanaimo

Re: Nanaimo Correctional Centre Replacement – Development and Variance Rationale

Lainya,

Please find enclosed the Nanaimo Correctional Centre Replacement – Architectural Development and Variance Rationale. Included below is an explanation of the development and summary of information relevant to zoning bylaws.

1. Project Overview

The Nanaimo Correctional Centre (NCC) Project involves the replacement of the Existing Correctional Centre at 3945 Biggs Road, Nanaimo BC. The Site is located beside Brannen Lake and includes DPA1, DPA2 overlays and CS2, ALR Zoning. **Drawing A101 Site Plan** outlines the scope of the development within the site and its proximity to the zoning boundaries.

Over several construction phases, the existing centre will be demolished and 12 new Buildings will be constructed within the Secure Perimeter fence. The development includes a new secure administration building, a Program Services Building and a variety of Residences throughout the site. **Drawing A003 Project Data** summarises the development areas and the relevant zoning data for review, with Bylaw References.

2. Site and Context

The Project Site is bounded by Millstone Creek to the West, Brannen Lake to the North, the Agricultural Land Reserve to the East and Biggs Road to the South. Within this large site is the NCC Campus, encompassed by the Secure Perimeter fencing.

The NCC masterplan is designed to reflect a typical college campus, to the greatest extent possible within a Correctional Centre. The site is divided into four quadrants of distinct scale and character, each with a distinct use. The Main Administration Building (Block AE) is located in quadrant 1, the Medium Neighbourhood (Blocks F1-F3) in Quadrant 2, the Guthrie Neighbourhood (Blocks GS, H1-H4) in Quadrant 3, the Landscape Storage and Horticulture Centre in Quadrant 4 and the Program Services Building (Block D1) at the centre.

The Site is highest at Biggs Road, and descends in terraces towards the edge of Brannen Lake. As a result, the South Façade of the Main Administration Building (Block AE) is the only visible building face from Biggs Road. Where possible, landscaped berms and planting has been used as screening to obscure the scale of the development when viewed from Biggs Road or Brannen Lake.



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3. Massing, Form and Character

At the centre of the site, Block D1 contains educational and recreational components. This building is similar in scale to that of other Community Centres encountered across Vancouver Island and the Lower Mainland. The mass of the building is broken into 3 zones, with the Gym volume at the centre. From the South, a single storey is visible with the full mass of the building facing the lakeside residences to the north. The façade treatment reflects this building typology, with custom pattern metal cladding, fibre cement board cladding and generous curtainwall glazing.

The Medium Security and Guthrie Residences (Blocks F1-F3, H1-H4) are grouped in two distinct neighbourhoods of small, two storey buildings. The Guthrie Support Building (Block GS) forms a part of the Guthrie neighbourhood, similar in scale to the surrounding residences. The façade treatment is typical of multi-family developments, clad with fibre cement panels and horizontal lap siding. The building mass is broken down further with pattern elements inspired by traditional Coast Salish Architecture, with vertical trim elements extending the height of the buildings.

Each of these neighbourhoods contains a hardscape plaza, vehicle and pedestrian access.

Block AE, the main administration building, contains all the Secure populations, their supporting services, a healthcare component, staff offices and publicly accessible areas. The building massing ultimately reflects the functional program required for the efficient and safe operation of a Correctional Centre, with a focus on reducing the scale of the public facing facade. The resulting massing is a two storey institutional development, when viewed from Biggs Road. Across the length of the building the grade drops substantially. The building form varies across this length, appearing as 3 separate buildings due to setbacks and façade treatment. The public entry displays a large feature wall of natural wood cladding, fibre cement boards, pattern siding.

4. Vehicle Access and Circulation

The Nanaimo Correctional Centre is accessed from Biggs Road. Vehicular circulation is divided into two categories, Public and Secure.

The public parking lot is located close to the Biggs Road site entry, the visitor entrance plaza and the public lobby of Building AE. This parking lot contains Accessible Stalls and Electrical Vehicle Charging stands. A paved turnaround allows ambulant visitors to be dropped off close to the public entry. Public Vehicle Access is restricted at the end of the paved turnaround. Landscaping, Signage, monitored security and passive wayfinding elements enforce this restriction.

Secure Vehicle access continues beyond the entrance plaza to the North to the Staff Parking, Vehicle and Pedestrian Sallyports, Facilities and Maintenance Entrance and the exterior patrol road. Deliveries will be received at the loading bays. Fire Truck and Emergency Vehicle Access to the site is provided via the Vehicular Sallyport to the North of Block AE. Inside the NCC Campus a road provides access to all building entries, ending in a turnaround in front of Building D1.



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5. Pedestrian and Bicycle Access

The Nanaimo Correctional Centre is accessed from Biggs Road, the Public parking and Staff parking lots. Bicycle parking is located adjacent to the Public and Staff entrances. Landscaping, Signage, monitored security and passive wayfinding elements are used to reinforce and naturally delineate public access. Staff are provided with a dedicated entry in to the facility, that is discrete and separate from the main Reception and Visitation area used by the Public. Pedestrian walking paths are numerous, located throughout the campus to provide barrier free access to each building.

6. Sustainability

The Nanaimo Correctional Centre Replacement Project is designed to meet a high level of environmental stewardship. In addition to meeting the mandatory ASHREA 90.1 requirements, the new school is designed to achieve LEED Gold. The design places an emphasis on energy efficiency, indoor environmental quality, water efficiency, sustainable site design and waste management. The LEED score card will summarize the specific strategies used for this project.

7. Zoning

Please refer to **Drawing A003 Project Data** for a detailed summary of applicable Zoning Calculations with rationale and Bylaw references included.

8. Variance Rationale


A small portion of the Block AE Development infringes on the Maximum Allowable Building Height. The Infringing Area is comprised of the Central Control and Security System for the entire Prison Campus. This location is ideal for the function of this space, as view lines from the Central Control to the Public Entry, Public Parking Lot, Staff Parking Lot and the NCC Campus are essential for the safety of staff and inmates. The Central Control is set back from the South Façade and is partially obscured from view from Biggs Road. In addition to this, the finished grade at the public entry is a Storey above the Average Grade, further diminishing the appearance of the building height to the public. The infringing area is approximately 120m2 of the total 16,912m2 development.

The Average Grade Calculation, Maximum Building Height, Infringing Area and proximity to Biggs Road are outlined on **Drawings A5000** and **A5500**.

Yours truly,

Tony Gill, Architect MAIBC, MRAIC, AIA Global Director

LOCATION PLAN

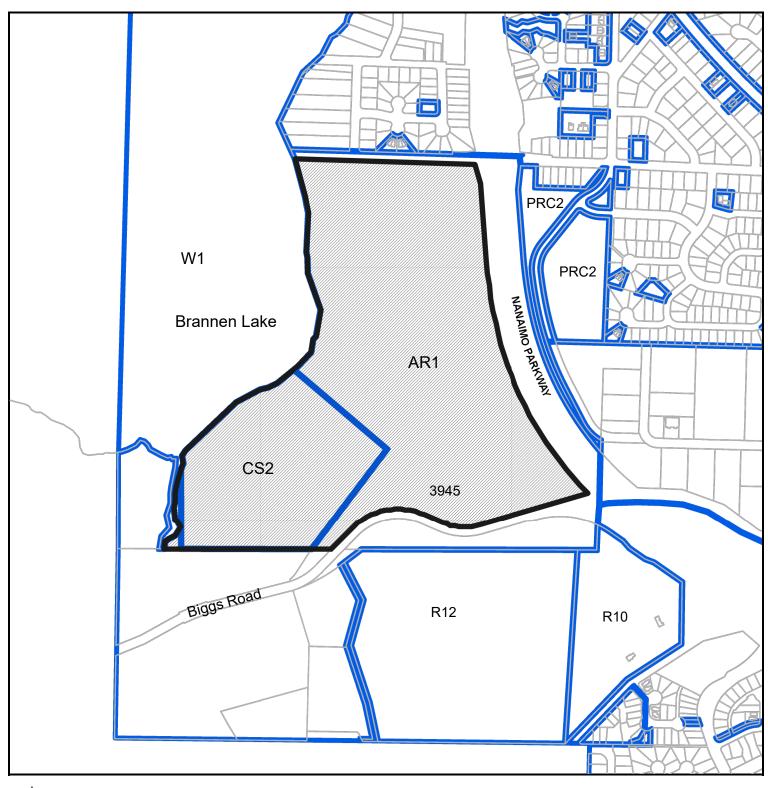



DEVELOPMENT PERMIT NO. DP001221

Subject Property

CIVIC: 3945 BIGGS ROAD

LEGAL: LOT 1, DISTRICT LOT 22G, WELLINGTON DISTRICT, PLAN VIP73819

NANAIMO CORRECTIONAL CENTRE REDEVELOPMENT


Project Data

Civic Address: Legal Description: PID: Zoning:

3945 Biggs Road, Nanaimo, B.C.
LOT 1, DISTRICT LOT 22G, WELLINGTON DISTRICT, PLAN VIP73819
025-242-530
CS-2, AR-1 (Split-zoned site. New building construction under this application confined to CS-2 zone)

Lot Area:

Item	Required/Permitted	Existing	Proposed	Caculation	Bylaw Reference	Rationale
Principle Use:	Jail	Jail	Jail		4500 - 14.2.1	
Occupants:						
Inmates: Staff:		190 124	202 165			
Building Height:	14 m				4500 - 14.6.1 & Part 5 - Height, Building	AE building control tower footprint area is a small porion of total building foot print. Excess control tower height is pushed well back
Building:			Proposed Building Height	Ave Finished Grade Calculation:		from building front such that it is screened by the lower portion of the building and by landscape elements. Elevator penthouses exempt.
AE			18.730 m	SEE BUILDING AE SHEET AE-A5000 FOR CALCS. AVE. FIN GRADE = 95.02 m		
D			8.846 m	SEE BUILDING SHEET D1-A1000 FOR CALCS. AVE. FIN GRADE = 94,904m		
F			8.450 m	ALL CORNERS AT 84.25 m AVE. FIN GRADE = 84.25 m		
GS			8.300 m	ALL CORNERS AT 85.50 m AVE. FIN GRADE = 85.50 m		
н			7.700 m	ALL CORNERS AT 84.50 m AVE. FIN GRADE = 84.50 m		
Lot Coverage	50%		8.65%	(AE + D + F + G + H + Ht + Ldsc) / CS-2 Area (5758.00 + 1359.93 + 418.32 + 417.38 + 209.99 + 120.1 + 141.1)/114,320		
Floor Areas				Deductions		
			Net Area	Base Area Service Rm Lobby Byc/Rec Green Net Area Storage Equip.		Exterior wals > 165mm thick. Interior face of wall used as area
Building AE: Building D:			10651.38 m ² 1758.24 m ²	10379.07 m ² 9.29 m ² 10.9 m ² 7.5 m ² 0 m ² 10651.38 m ² 1767.53 m ² 9.29 m ² 0 m ² 0 m ² 0 m ² 1758.24 m ²		boundary for Base Areas.
Buildings F: Buildings H:			2276.03 m ² 660.61 m ²	2285.32m ² 9.29 m ² 0 m ² 0 m ² 0 m ² 2276.03 m ² 1322.927 m ² 9.29 m ² 0 m ² 0 m ² 0 m ² 660.61 m ²		
Building G: Landscape Equipment Shed LE:			1313.63 m ² 111.1 m ²	369.90 m ² 9.29 m ² 0 m ² 0 m ² 0 m ² 1313.63 m ² 120.1 m ² 9.00 m ² 0 m ² 0 m ² 0 m ² 111.1 m ²		
Horticulture Center HT:			141.1 m ² 16912.09 m ²	141.1 m ² 0 m ² 0 m ² 0 m ² 0 m ² 141.1 m ²		
FAR	1.25		0.1479	16912.09 m ² / 114,320 m ² (CS-2 zone only)	4500 - 14.3.1	
Setbacks					4500 - 14.5.1	
Front: Front - Major Street:	7.5 m 10 m		N/A 75.763 m			
Side:	7.5 m		20.256 m			
Flanking Side: Rear:	7.5 m 7.5 m		N/A N/A			
Watercourse - Brannen Lake: Watercourse - Millstone River:	15 m 30 m		35.378 m 34.527 m		4500 - 6.3.1.1 & Sched C 4500 - 6.3.1.4	
Flood Control Elevation			81.7 m per Civil consultant		7226 - 7.2 Table 4	Proposed bwest floor level: 84.25 m (Building F)
Off-Street Parking					7226 - 7.2 Table 4	Proposed inmate population increase: 12/190 = 6.31% increase
Conurs		0	18			Proposed staff increase: 41/124 = 33.1% increase
Secure: Special:		12	15			Proposed parking stall increase: 74/99 = 74.7% increase. Proposed parking increase is much greater than proposed inmate and staff
Staff: Visitor:		12 72 15	110 30			population increase.
Total:		99	173			
Accessible Stalls:	5	0	5		7226 - 7.5 Table 6	
EV Charging Stalls:	Not defined.	ō	9		7226 - 7.7	
Off-Street Loading Stalls	4	4	4		7226 - 6.1(i)(b)	
Bicycle Parking	Not defined	0	4 Public plus 4 Employee - Total: 8		7226 - 7.6 Table 7	Similar to hospital use

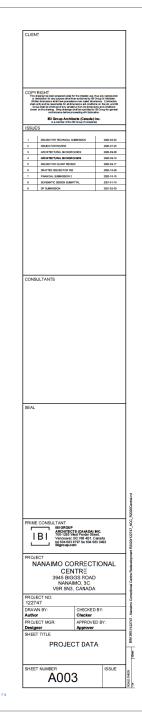



ISSUE	S	
No.	DESCRIPTION	DATE
1	ISSUED FOR TECHNICAL SUBMISSION	2020-05-03
2	ISSUED FOR REVIEW	2000-07-25
3	ARCHITECTURAL BACKSROUNDS	2020-09-08
4	ARCHITECTURAL BACKSROUNDS	2020-09-10
5	ISSUED FOR CLIENT REVIEW	2020-09-17
6	DRAFTED ISSUED FOR FS2	2020-10-09
7	FINANCIAL SUBMISSION 2	2020-10-15
	SCHEMATIC DESIGN SUBMITTAL	2021-01-15
9	DP SUBMISSION	2021-02-03

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PROJECT
NANAIMO CORRECTIONAL
CENTRE
3945 BIGGS ROAD
NANAIMO, 3C
V9R 5N3, CANADA

PROJECT NO: 122747

DRAWN BY: NM

PROJECT MGR: TED


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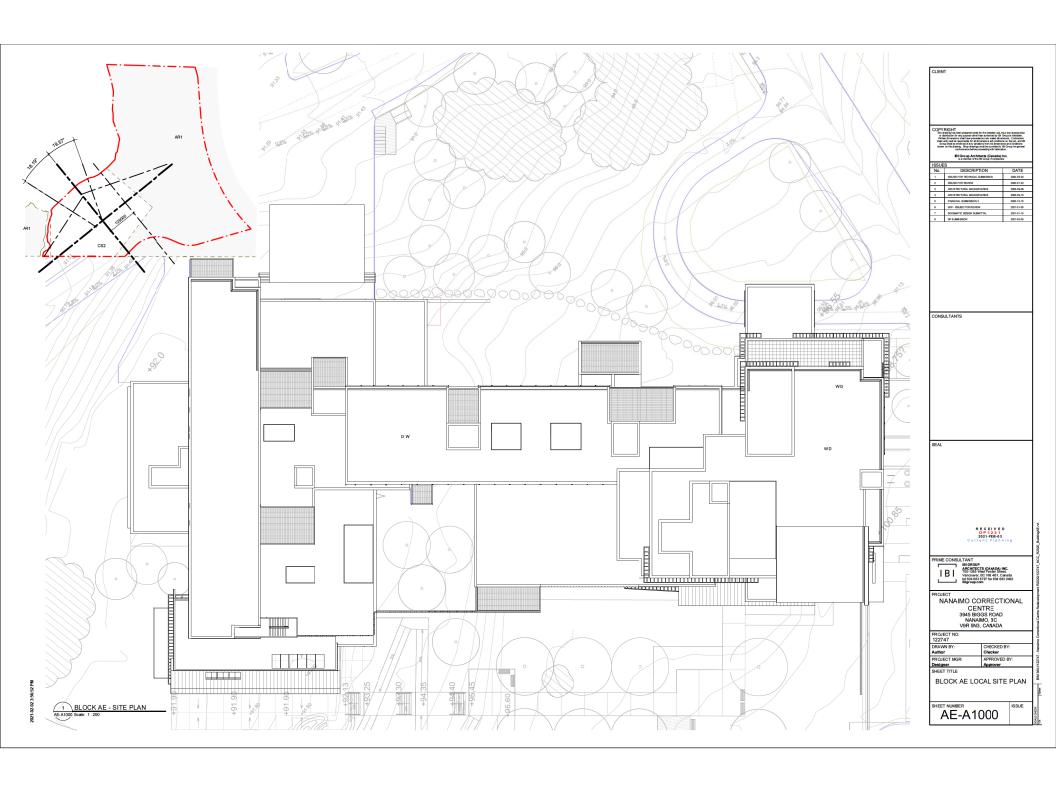
FECEIVED
DP1221
2021-FEB-03
Current Plannir


SITE PLAN - EXISTING

A100


1 SITE PLAN-LEVEL 01-Existing
A100 Scale: 1:1000 CJ. = 0.5 m



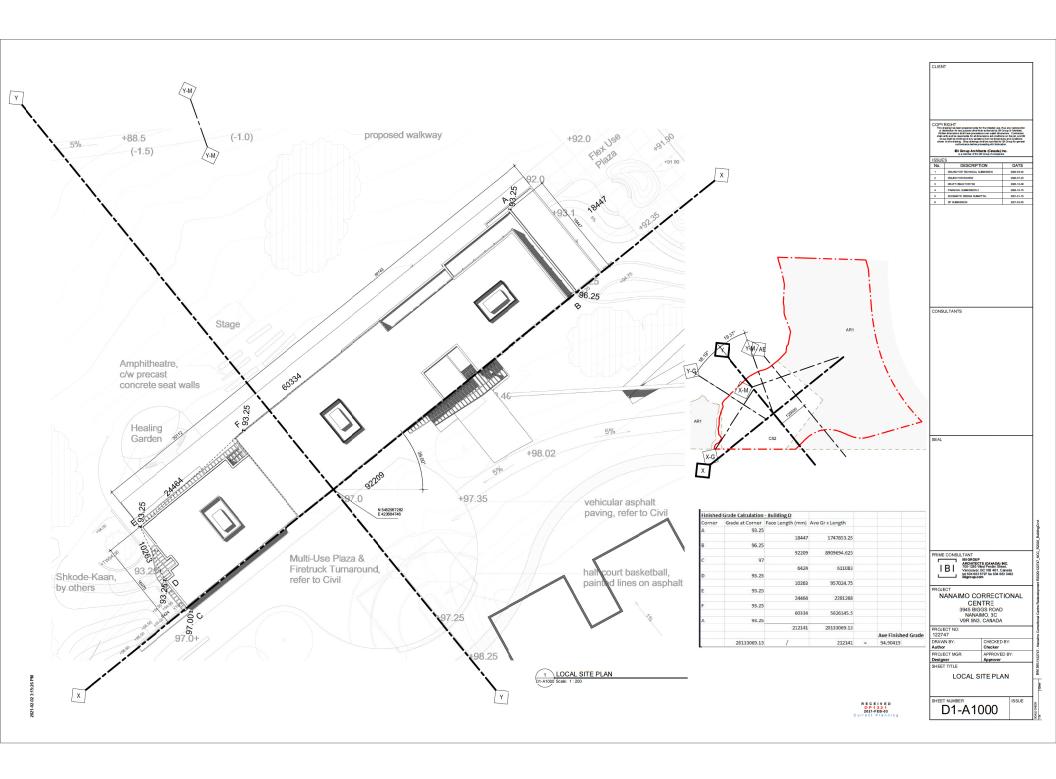

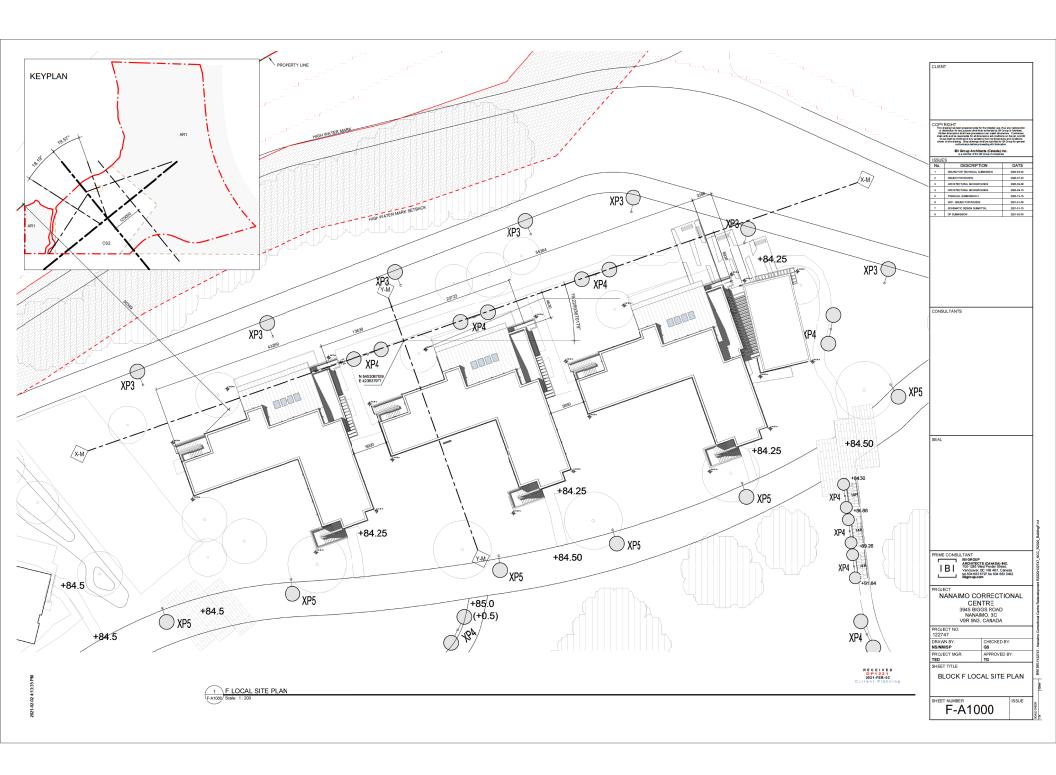





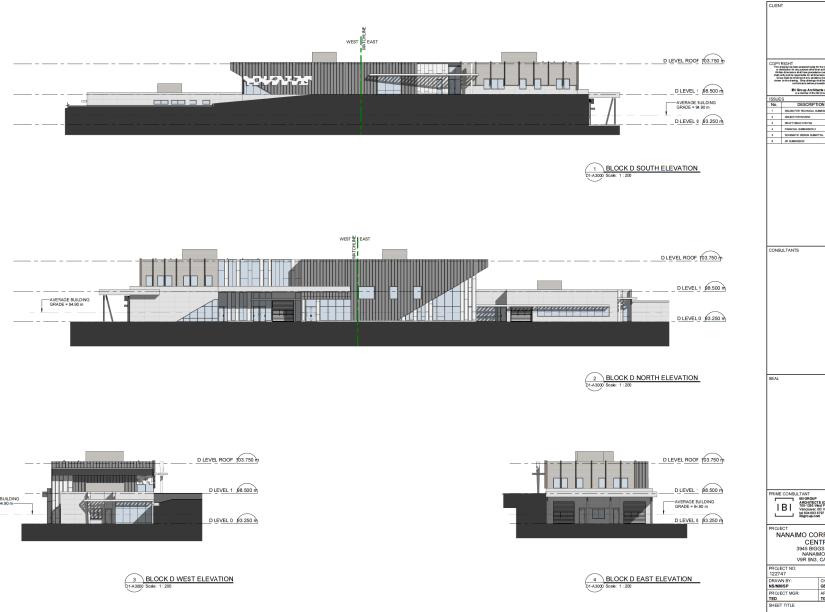

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NANAIMO CORRECTIONAL CENTRE 3945 BIGGS ROAD NANAIMO, 3C V9R 5N3, CANADA PROJECT NO: 122747 CHECKED BY: GS APPROVED BY: TG PROJECT MGR: TED SHEET TITLE BLOCK D - BUILDING ELEVATIONS KEY D1-A3000 RECEIVED DP1221 2021-FEB-03 Current Planning

2000-05-03 2000-07-23 2000-10-09 2000-10-15 2021-01-15

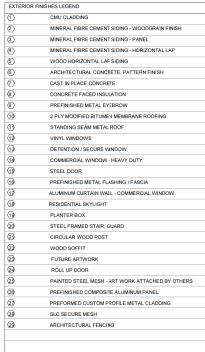

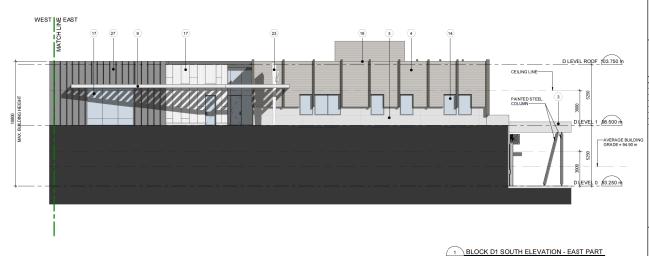



RECEIVED
DP1221
2021-FEB-03
Current Planning 2 BLOCK D1 SOUTH ELEVATION - WEST PART 01-A3001 Scale: 1:100

CLIENT DATE 2009-07-29 2009-10-09 2009-10-15 2001-01-15 5 SCHEMATIC DESIGN SUBMITTAL CONSULTANTS RIME CONSULTANT JLTANT
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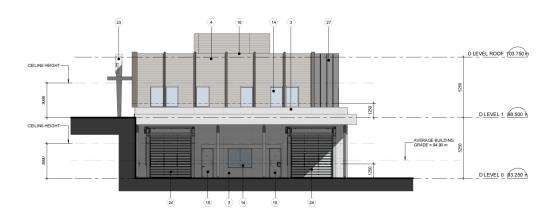
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BLOCK D - BUILDING **ELEVATIONS SOUTH**


D1-A3001



EVTEDIOD ENW	NIEG LEGEND
EXTERIOR FINIS	
1	CMU CLADDING
2	MINERAL FIBRE CEMENT SIDING - WOODGRAIN FINISH
3	MINERAL FIBRE CEMENT SIDING - PANEL
4	MINERAL FIBRE CEMENT SIDING - HORIZONTAL LAP
(5)	WOOD HORIZONTAL LAF SIDING
6	ARCHITECTURAL CONCRETE, PATTERN FINISH
⑦	CAST IN PLACE CONCRETE
8	CONCRETE FACED INSULATION
9>	PREFINISHED METAL EYEBROW
10	2 PLY MODIFIED BITUMEN MEMBRANE ROOFING
11)	STANDING SEAM METAL ROOF
12	VINYL WINDOWS
(13)	DETENTION / SECURE WINDOW
14	COMMERCIAL WINDOW - HEAVY DUTY
19	STEEL DOOR
10	PREFINISHED METAL FLASHING / FASCIA
17	ALUMINUM CURTAIN WALL - COMMERCIAL WINDOW
(18)	RESIDENTIAL SKYLIGHT
19	PLANTER BOX
20	STEEL FRAMED STAIR, GUARD
2)	CIRCULAR WOOD POST
2	WOOD SOFFIT
23	FUTURE ARTWORK
24	ROLL UP DOOR
29	PAINTED STEEL MESH - ART WORK ATTACHED BY OTHERS
26	PREFINISHED COMPOSITE ALUMINUM PANEL
27	PREFORMED CUSTOM PROFILE METAL CLADDING
2 ₽	SLC SECURE MESH
29	ARCHITECTURAL FENCING





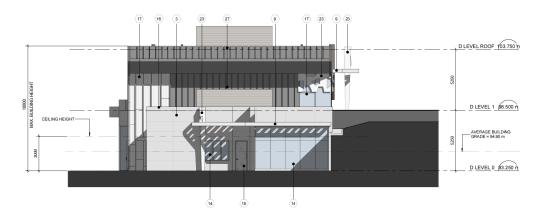





CLIENT 2000-05-03 2000-07-23 2000-10-09 2000-10-15 2001-01-15 2001-02-03 2 ISSUED FOR RENEW

3 DRAFT ISSUE P FOR FS2

4 FINANCIAL SUBMISSION 2

5 SCHEMATIC DESIGN SUBMITTAL


0 DP SUBMISSION CONSULTANTS PRIME CONSULTANT
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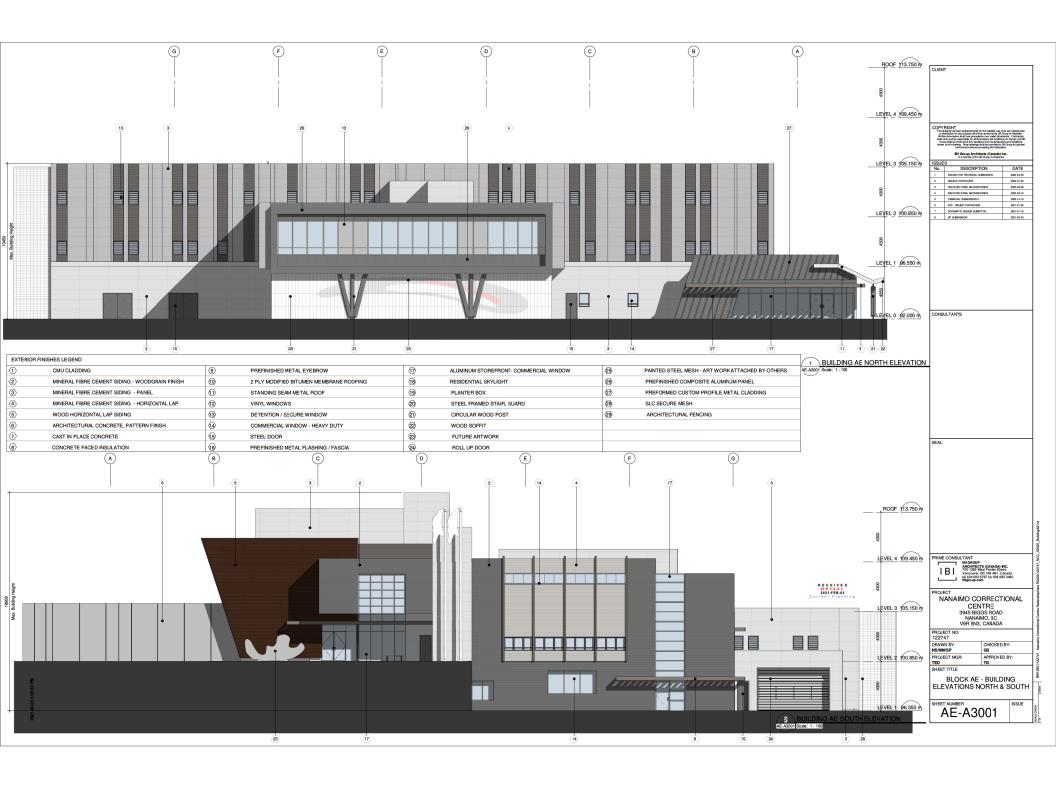
PROJECT
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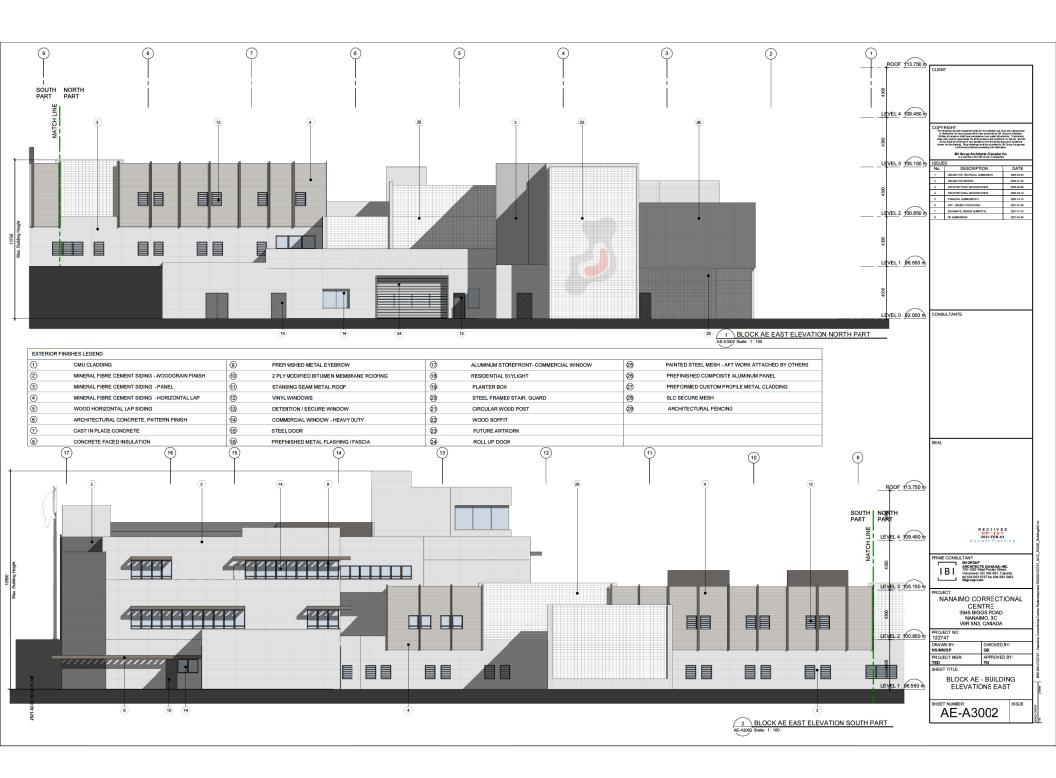
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NS/NM/SP
PROJECT MGR:
TED
SHEET TITLE CHECKED BY: GS APPROVED BY: TG


BLOCK D - BUILDING ELEVATIONS EAST & WEST


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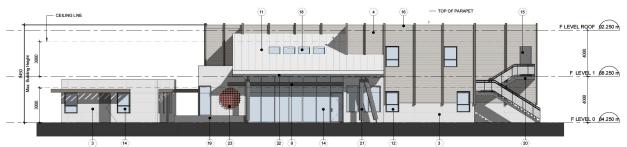






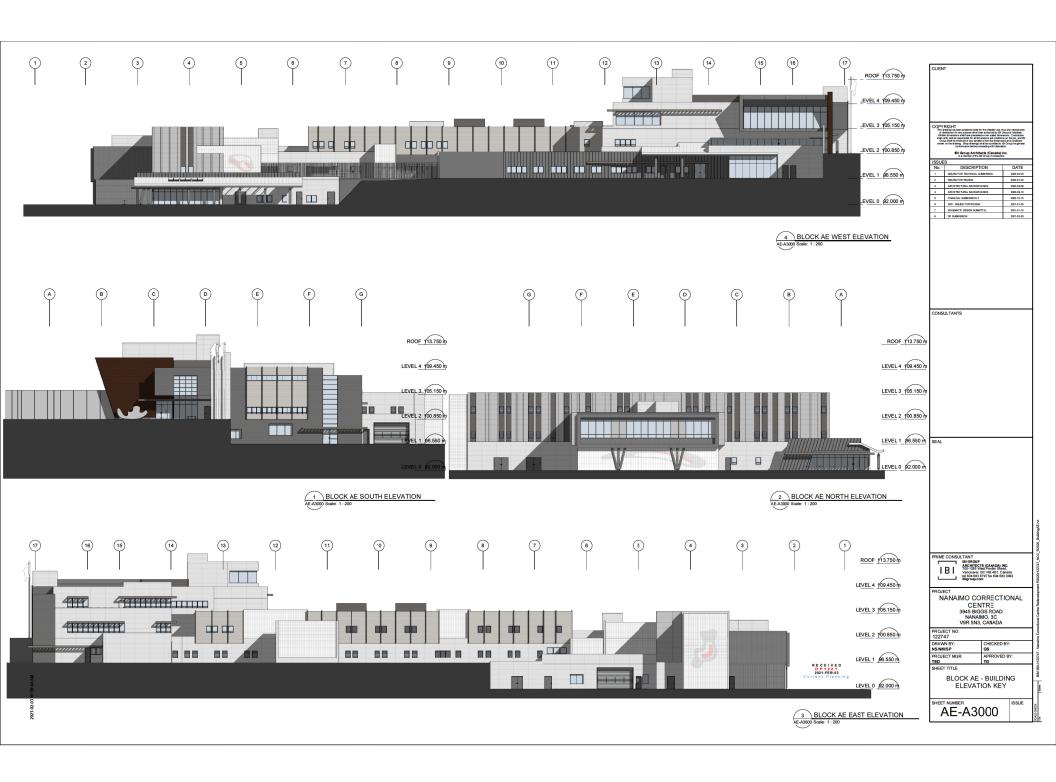


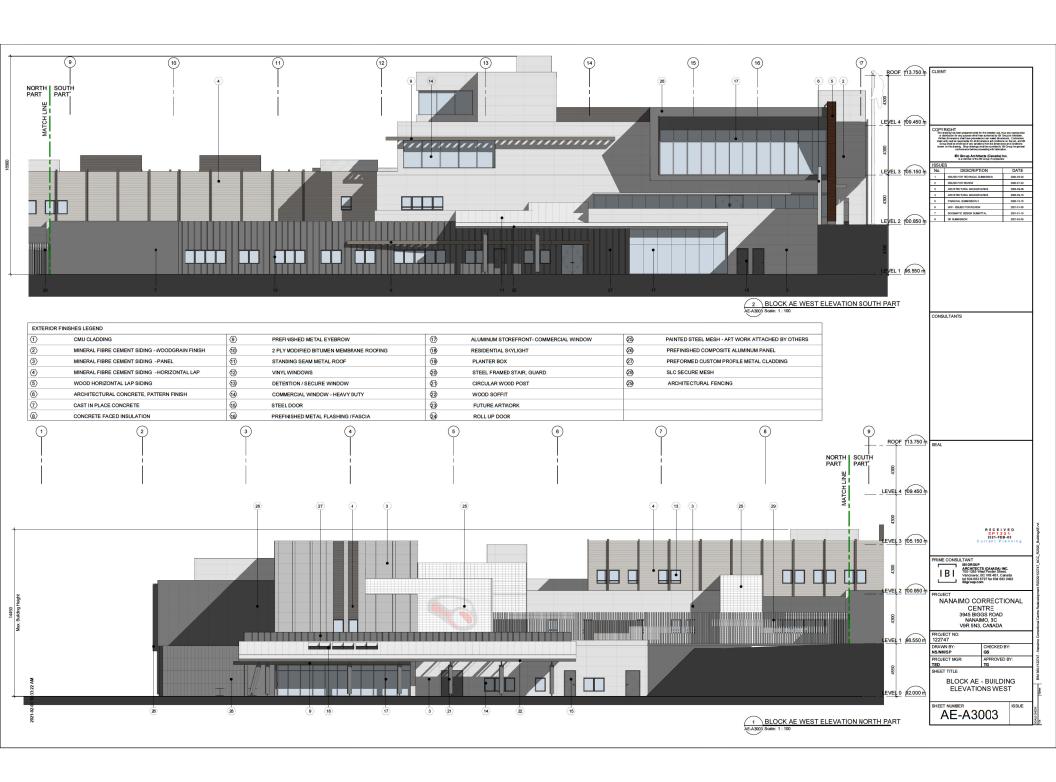

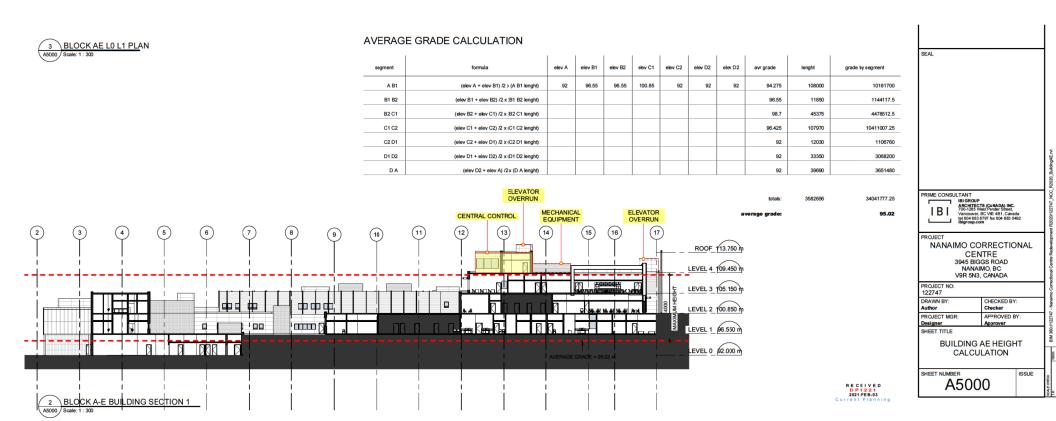






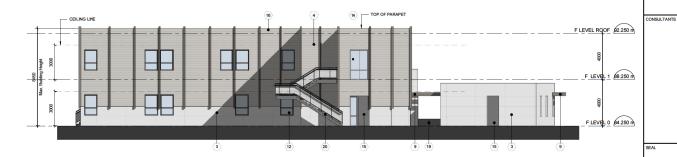

BLOCK F1 SOUTH ELEVATION
F1-A3000 Scale: 1:100

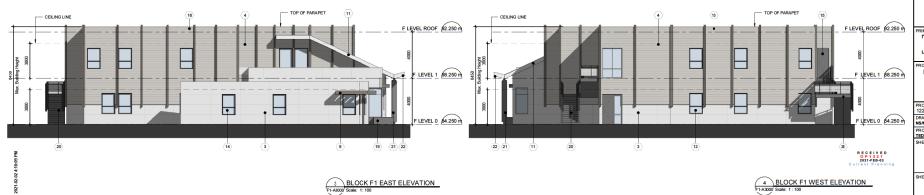

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PROJECT
NANAIMO CORRECTIONAL
CENTRE
3945 BIGGS ROAD
NANAIMO, 3C
V9R 5N3, CANADA

PROJECT NO:
122747

DRAWN BY: CHECKED BY:
NSAMISP


PROJECT MGR: APPROVED BY:
TED TG

SHEET TITLE

BLOCK F1+SUPPORT -BUILDING ELEVATIONS

F1-A3000 ISSUI


\supset	CMU CLADDING
	MINERAL FIBRE CEMENT SIDING - WOODGRAIN FINISH
3	MINERAL FIBRE CEMENT SIDING - PANEL
1)	MINERAL FIBRE CEMENT SIDING - HORIZONTAL LAP
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29	ARCHITECTURAL FENCING

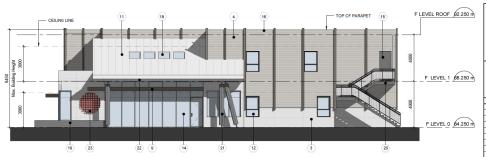



ISSUES						
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5	FINANCIAL SUBMISSION 2	2020-10-15				
	WP - ISSUED FOR REVIEW	2021-01-05				
7	SCHEMATIC DESIGN SUBMITTAL	2021-01-15				
	DP SUBMISSION	2021-02-03				

BLOCK F2-F3 NORTH ELEVATION F-A3000/ Scale: 1:100

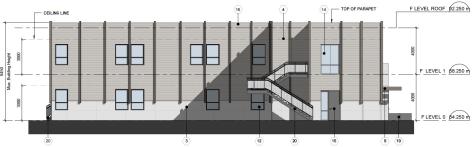



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BLOCK F2-F3 SOUTH ELEVATION FA3000/ Scale: 1:100

4 BLOCK F2-F3 WEST ELEVATION

(F-A3000) Scale: 1: 100



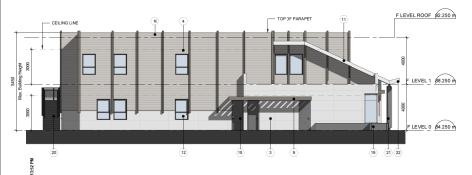
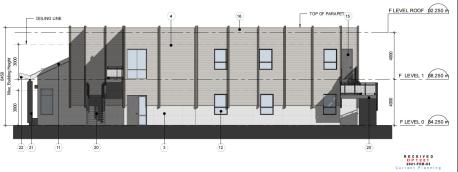
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ROJECT
NANAIMO CORRECTIONAL CENTRE 3945 BIGGS ROAD NANAIMO, 3C V9R 5N3, CANADA

PROJECT NO: 122747 CHECKED BY: GS APPROVED BY: TG PROJECT MGR: TED SHEET TITLE


BLOCK F2+F3 - BUILDING ELEVATIONS

F-A3000


BLOCK F2-F3 EAST ELEVATION

F-A3000/ Scale: 1:100




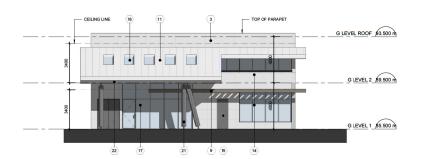



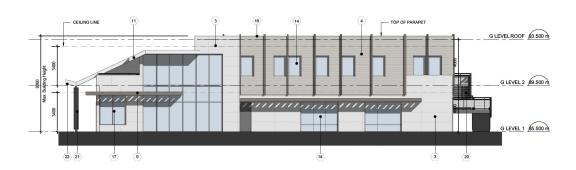



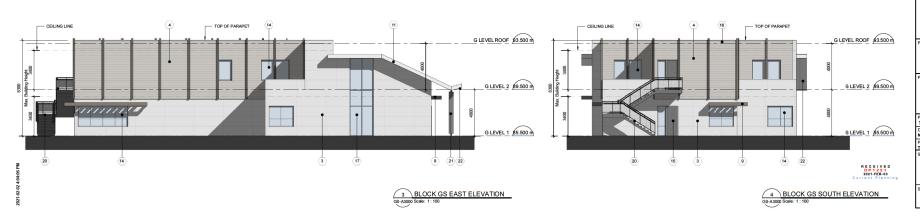

CLIENT

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7	SCHEMATIC DESIGN SUBMITTAL	2021-01-15
	DP SUBMISSION	2021-02-09

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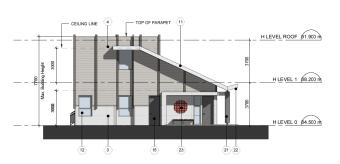
ROJECT NANAIMO CORRECTIONAL CENTRE 3945 BIGGS ROAD NANAIMO, 3C V9R 5N3, CANADA

PROJECT NO: 122747 DRAWN BY: NS/NM/SP PROJECT MGR: APPROVED BY: TED SHEET TITLE


BLOCK GS - BUILDING ELEVATIONS

GS-A3000


EXTERIOR FINISHES LEGEND






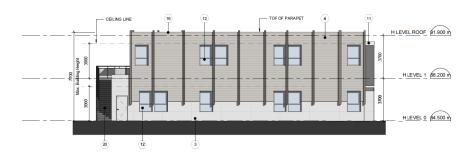

1 BLOCK H NORTH ELEVATION

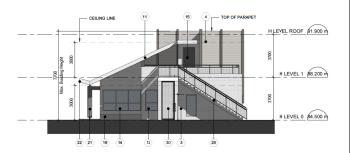

BLOCK H WEST ELEVATION H-A3000 Scale: 1:100

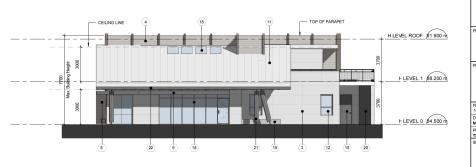



CLIENT

SSUES					
No.	DESCRIPTION	DATE			
1	ISSUED FOR TECHNICAL SUBMISSION	2000-05-03			
2	ISSUED FOR REVIEW	2000-07-23			
3	ARCHITECTURAL BACKGROUNDS	2000-09-08			
4	ARCHITECTURAL BACKSROUNDS	2000-09-10			
s	FINANCIAL SUBMISSION 2	2000-10-15			
1	WP - ISSUED FOR REVIEW	2021-01-05			
,	SCHEMATIC DESIGN SUBMITTAL	2021-01-15			
	DP SUBMISSION	2021-02-03			

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bilgroup.com

ROJECT
NANAIMO CORRECTIONAL CENTRE 3945 BIGGS ROAD NANAIMO, 3C V9R 5N3, CANADA


PROJECT NO: 122747 CHECKED BY: APPROVED BY: PROJECT MGR: TED SHEET TITLE

BLOCK H - BUILDING ELEVATIONS

H-A3000

BLOCK H EAST ELEVATION

H-A3000/ Scale: 1:100

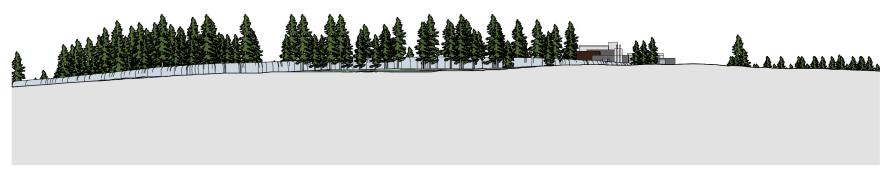

1 Streetscape from Biggs Road A6000 Scale: 1:500

CONSULTANTS

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ON THE PRIME STREET, STANDAY INC.
TOTAL 1885 Visit Practice Street.
Vancouver, EC Visit 481, Canada tel 604 683 8797 fax 604 683 0492 bilgroup.com

PROJECT
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CENTRE
3945 BIGGS ROAD
NANAIMO, 3C
V9R 5N3, CANADA

PROJECT NO: 122747
DRAWN BY: Author
PROJECT MGR: Designer
SHEET TITLE CHECKED BY: Checker APPROVED BY: Approver

NEIGHBOURHOOD CONTEXT / STREETSCAPE

A6000



BUILDING AE / MAIN ENTRANCE

CONSULTANTS іві PROJECT
NANAIMO CORRECTIONAL
CENTRE
3945 BIGGS ROAD
NANAIMO, 3C
V9R SN3, CANADA PROJECT NO: 122747 DRAWN BY: Author PROJECT MGR: Designer SHEET TITLE RENDERS A7000

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BUILDING D1 / BUILDING AE BLOCK GS / BLOCK H





BLOCK F **BLOCK GS**

No.	DESCRIPTION	DATE
	ISSUED FOR TECHNICAL SUBMISSION	2020-05-00
2	ISSUED FOR REVIEW	2000-07-20
3	ARCHITECTURAL BACKGROUNDS	2000-09-08
4	ARCHITECTURAL BACKSROUNDS	2020-09-10
5	ISSUED FOR QUENT REVIEW	2000-09-17
•	DRAFTED ISSUED FOR FS2	2000-10-09
7	FINANCIAL SUBMISSION 2	2020-10-15
	SCHEMATIC DESIGN SUBMITTAL	2021-01-15
	DP SUBMISSION	2021-02-09

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1el 604 683 5797 fax 604 683 0492
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V9R 5N3, CANADA

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RENDERS

A7001



SOUTHWEST VIEW

CONSULTANTS PRIME CONSULTANT

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tibigroup.com PROJECT
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3945 BIGGS ROAD
NANAIMO, 3C
V9R 5N3, CANADA PROJECT NO: 122747 DRAWN BY: Author PROJECT MGR: Designer SHEET TITLE CHECKED BY: Checker APPROVED BY: RENDERS A7002

1-02-02 5:12:54

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EXTERIOR FINISHES LEGEND								
1	CMU CLADDING	(9)	PREFINISHED METAL EYEBROW	17	ALUMINUM CURTAINWALL - COMMERCIAL WINDOW	25	PAINTED STEEL MESH - ART WORK ATTACHED BY OTHERS	
2	MINERAL FIBRE CEMENT SIDING - WOODGRAIN FINISH	10	2 PLY MODIFIED BITUMEN MEMBRANE ROOFING	18	RESIDENTIAL SKYLIGHT	26	PREFINISHED COMPOSITE ALUMINUM PANEL	
3	MINERAL FIBRE CEMENT SIDING - PANEL	11)	STANDING SEAM METAL ROOF	19	PLANTER BOX	27	PREFORMED CUSTOM PROFILE METAL CLADDING	
4	MINERAL FIBRE CEMENT SIDING - HORIZONTAL LAP	12	VINYL WINDOWS	20)	STEEL FRAMED STAIR, GUARD	28	SLC SECURE MESH	
(5)	WOOD HORIZONTAL LAP SIDING	13>	DETENTION / SECURE WINDOW	21)	CIRCULAR WOOD POST	29	ARCHITECTURAL FENCING	
6	ARCHITECTURAL CONCRETE, PATTERN FINISH	14	COMMERCIAL WINDOW - HEAVY DUTY	22	WOOD SOFFIT			
7	CAST IN PLACE CONCRETE	15	STEEL DOOR	23	FUTURE ARTWORK			
8	CONCRETE FACED INSULATION	16	PREFINISHED METAL FLASHING / FASCIA	24	ROLL UP DOOR			





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R. Kim Perry & Associates Inc. 112 E Broadway Vancouver, BC V5T 1V9 604 738 4118 www.perryandassociates.ca

February 03, 2021

NCCR Landscape Rationale – Issued for DP

The landscape design for the project aims to provide impactful exterior spaces that support the modern, progressive approach of the facility and create safe and secure outdoor spaces. A normalized, campus like design is supporting an atmosphere of learning and growth while being grounded in the natural landscape character of the site offering opportunities for daily interaction with the natural world.

Distinct landscape spaces are created throughout the site in response to the building program areas and existing site features, promoting diverse uses and positive human interaction. The Site plan aims to retain existing trees where possible and aims to respect the existing topography and character of the site. Views onto the facility and views from the facility onto Brennan Lake and the forest edge are carefully considered.

The site is organized into four quadrants with distinct uses and characters.

Quadrant 1 located at the NW corner of the site adjacent the lake riparian landscape contains the Guthrie Community, support building and neighbourhood plaza. This quadrant is somewhat secluded from other areas by the existing mature woodland to the south and a proposed wetland and planted berm to the east.

Quadrant 2 located at the NE corner of the site contains the Medium residences organized around a shared Commons with filtered views through stands of mature trees of Brennen Lake and views of open meadow and forest edge to the east.

The Guthrie and Medium communities are linked to the Main Building with accessible walkway and stair connections across a sloped open grassland area with stands of mature trees. Quadrant 3 located in the SE portion of the site contains the Main Building, is characterized by a structured campus landscape typology in responding to the adjacent building program spaces and Institutional character of the architecture. The Commons Plaza is a central hub for pedestrian circulation that connects the Main and Program Services buildings, offers outdoor dining, seating and gathering spaces and an outdoor workshop plaza space. A small amphitheater is located north of the Program Services building offering views over the lower buildings onto Brennan Lake. A flex-use plaza located south of the Program Services building offers space for large group gatherings and outdoor basketball. The Common Green is a further extension of the athletic functions located within the Program Services and adjacent plaza. A gravel running and walking loop is circling a generous flex-use grass area which can be used for a variety of sports and recreational programming.

Quadrant 4 located at the SW corner of the site contains the agriculture and landscape storage buildings. This area offers opportunities for food production and orchard planting as part of the operational programming of the facility. Indigenous and spiritual programming is supported by the addition of a council circle, Shkode-Kaan, Sweat Lodge and healing garden in proximity to a large stand of mature conifers. The addition of a future longhouse is anticipated within this quadrant and schematically illustrated if the landscape site plan.





The wide variety of landscape spaces provided within the facility creates opportunities for positive interaction, organized group activities, outdoor classroom programming, personal reflection, physical activity and recreation. Careful placement of gathering spaces, walkways and stair connections is aiming to offer freedom of movement and intuitive wayfinding throughout the site while respecting the requirements for efficient and secure pedestrian travel routes and required inmate population separations. Although the site is sloped, the design provides universal access to all major program areas. Where possible existing pathways and roads are retained to minimize site disturbance.

The planting strategy for the project relies heavily on the existing landscape typologies within the site and it's immediate context. The current facility features large open grass areas which are retained, however transformed from a more manicured lawn aesthetic towards a rougher, more drought tolerant grassland typology. The lakefront and riparian plant typologies present along Brennan Lake are reflected in the Wetland and meadow planting areas within the secure perimeter. A 'hedgerow and thicket' plant typology is borrowed from the site's agricultural context and is utilized to provide separation between uses where required and limit views onto the facility from Biggs Road. The retention of existing mature trees and addition of deciduous and coniferous tree clusters is connecting the on site landscape to the surrounding woodland and forest edge typologies.

Street trees at a regular spacing are provided along the Commons and the lower road alongside the Guthrie and Medium communities. This aims to evoke normalized environments of a campus mews and typical streetscape with a familiar rhythm of buildings, trees and entrance walkways. Large deciduous trees are provided along staff and visitor parking areas to provide canopy shade and reduce the heat island effect.

The plant palette relies heavily on native and adaptive plant material, drought tolerant, resilient and low maintenance species. The planting strategy follows biophilic design principles aiming to provide seasonal interest, connection to nature and creation of habitat.

Sustainable stormwater management practices include retention of soil permeability, rainwater infiltration and retention within landscape areas which is reflected in the Civil consultant's stormwater management plan.

The site lighting plan has been developed in coordination with the Electrical consultant and aims to provide safe, secure and well lit conditions in all relevant areas of the site.
















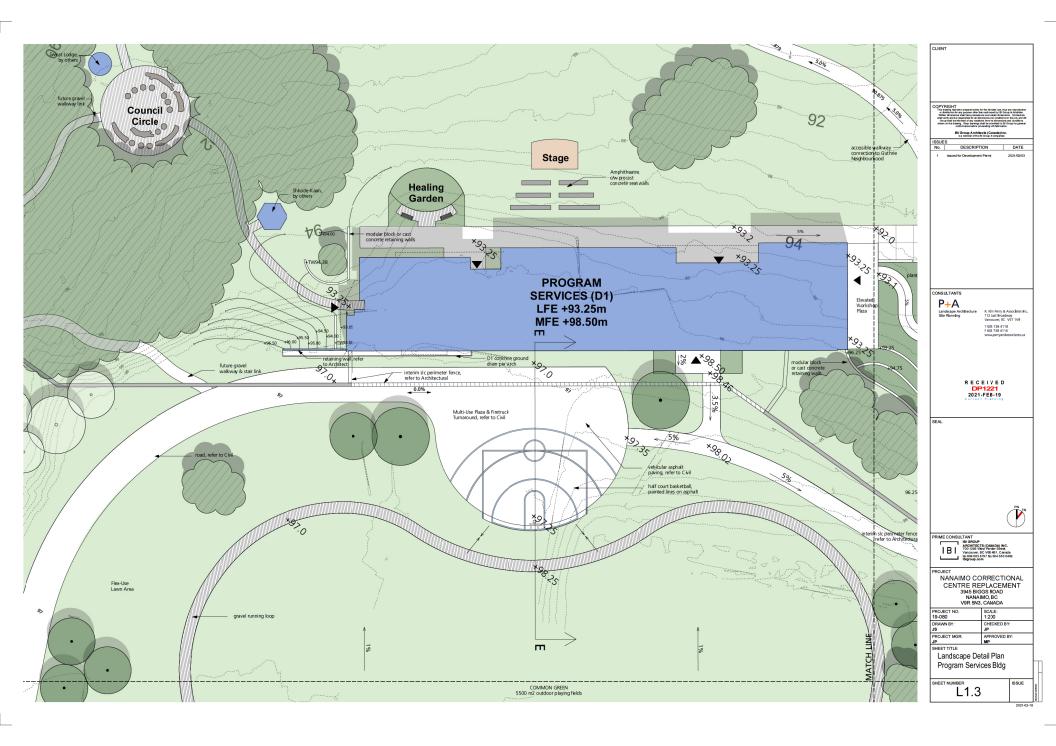


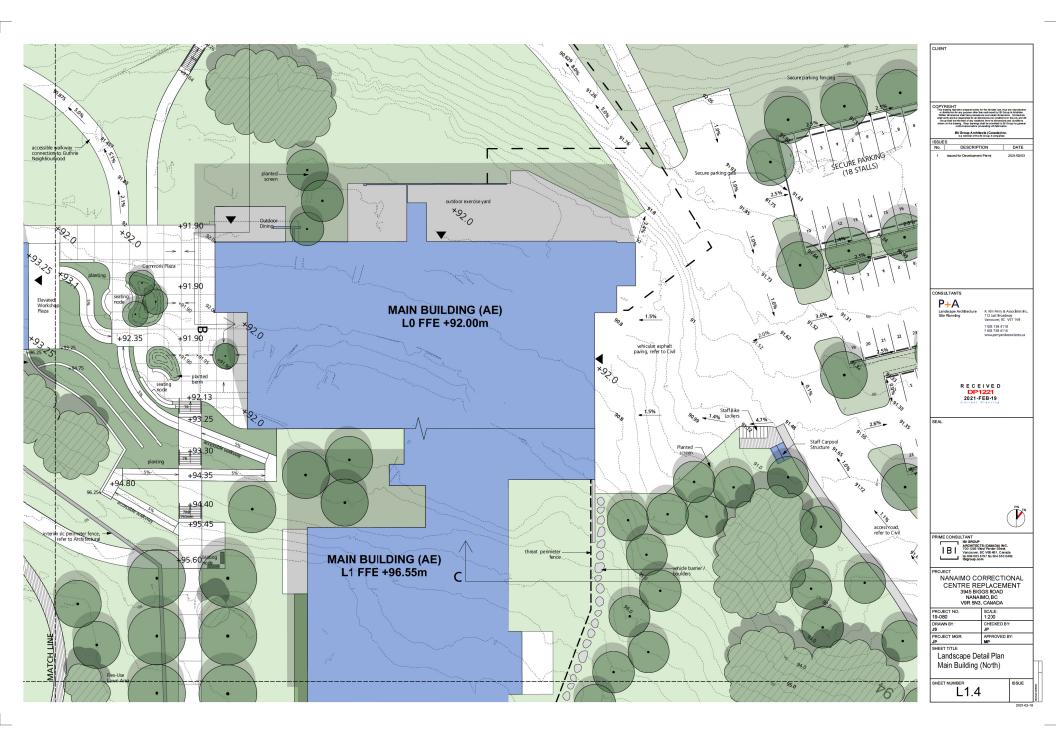


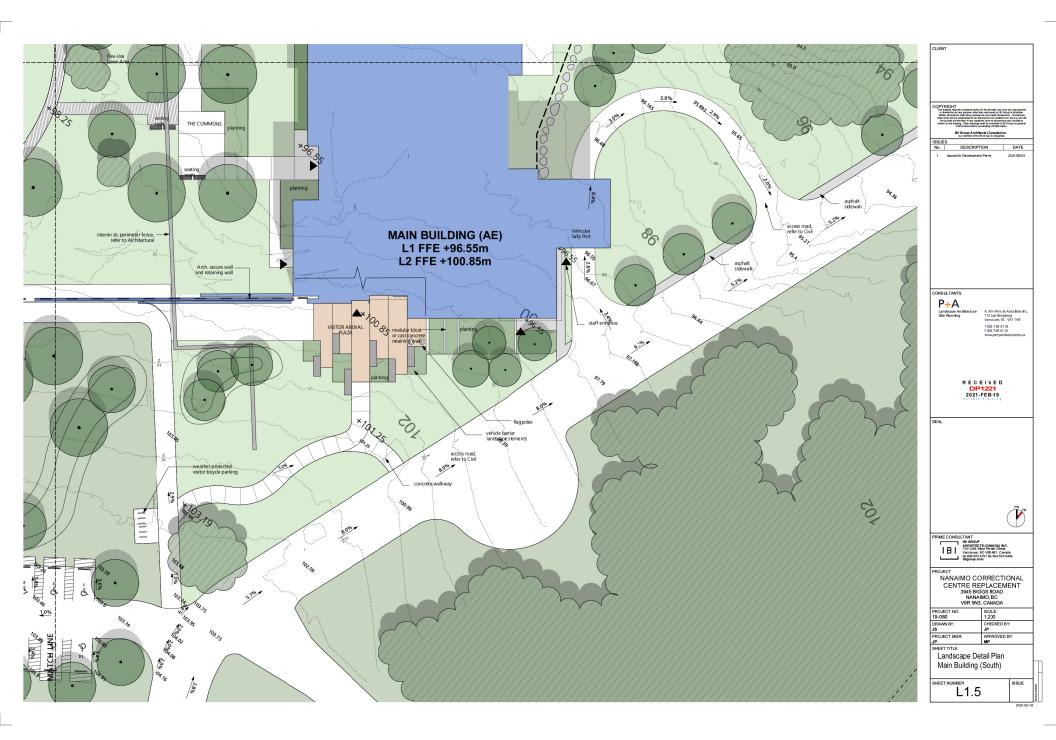


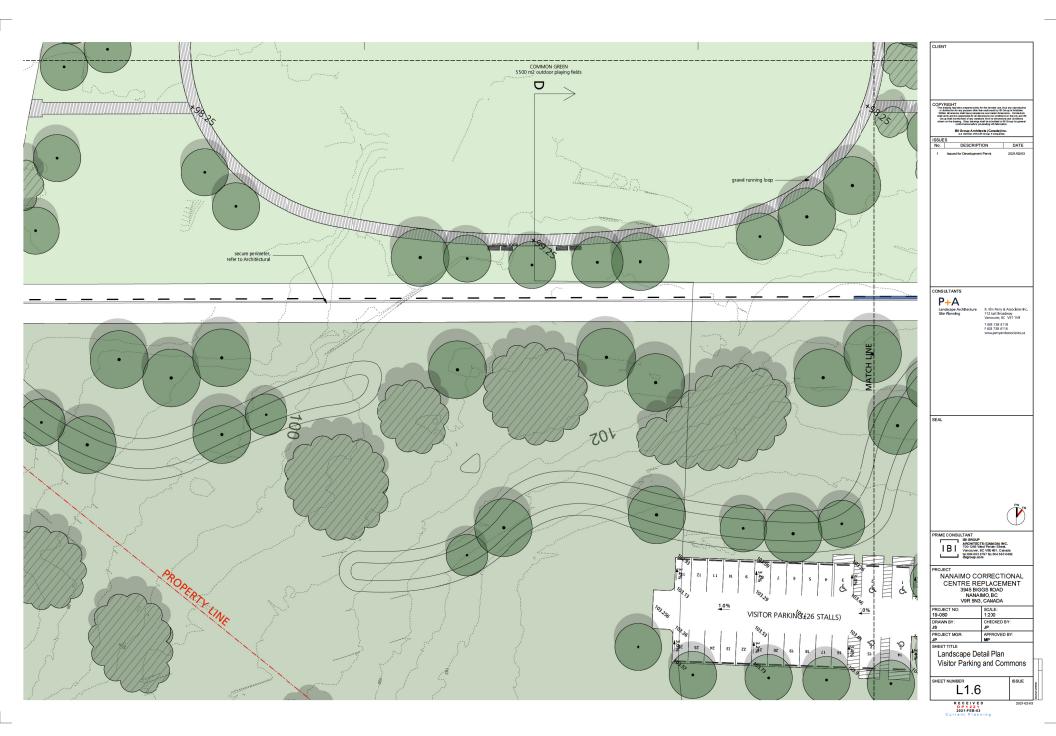

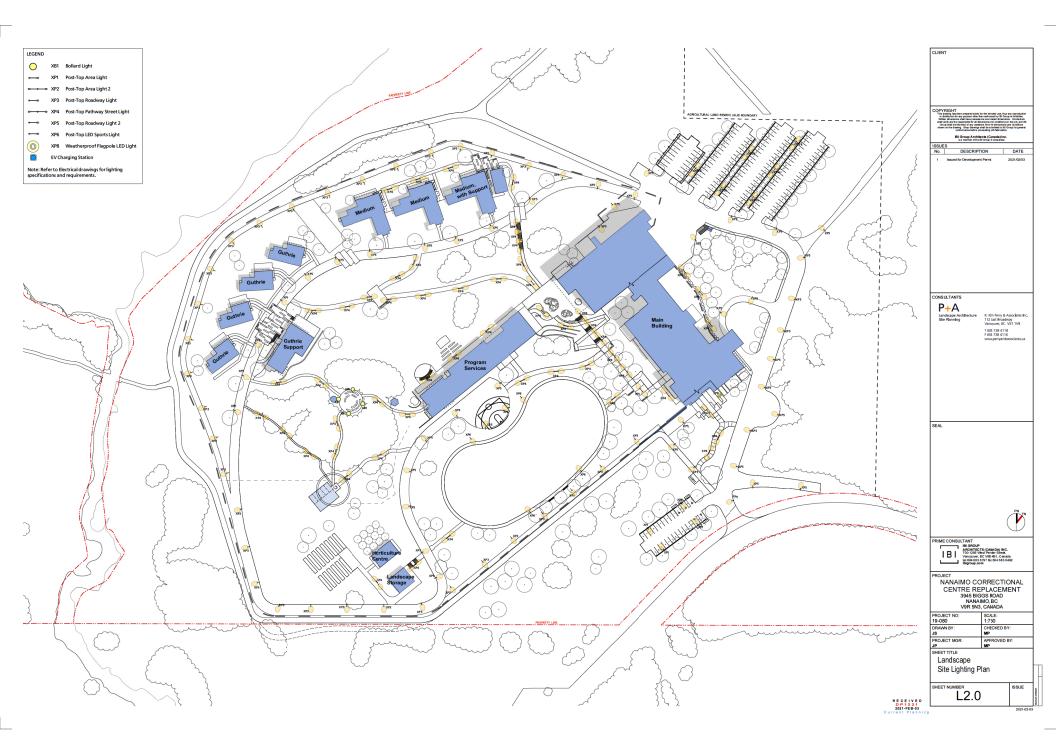

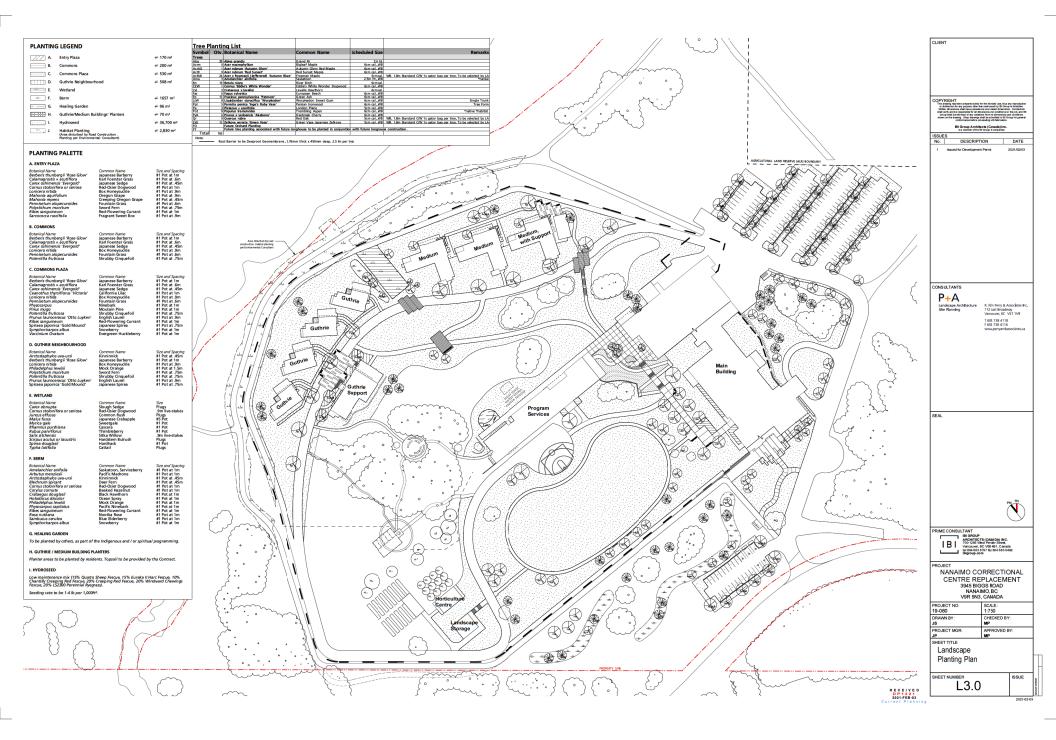

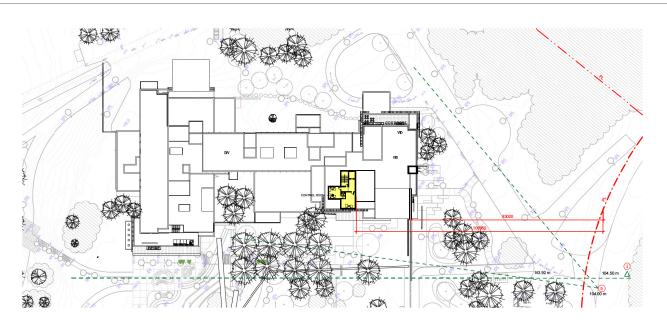

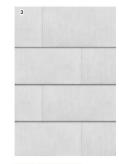

3. MINERAL FIBRE CEMENT PANEL



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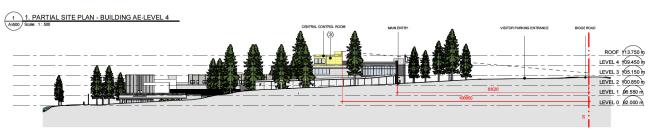
PROJECT
NANAIMO CORRECTIONAL
CENTRE
3945 BIGGS ROAD
NANAIMO, 3C
V9R 5N3, CANADA

PROJECT NO: 122747 DRAWN BY: Author PROJECT MGR: Designer SHEET TITLE

CHECKED BY: Checker APPROVED BY:

VIEW LINES FROM BIGGS ROAD

A5500



Site Section from Biggs Road to AE South Façade
Al500 Scale: 1: 500









4 VIEW FROM BIGGS ROAD 2 Scale:


5 VIEW FROM BIGGS ROAD 3
A5500 Scale:

3 VIEW FROM BIGGS ROAD 1 Scale:

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Landscape Precedents
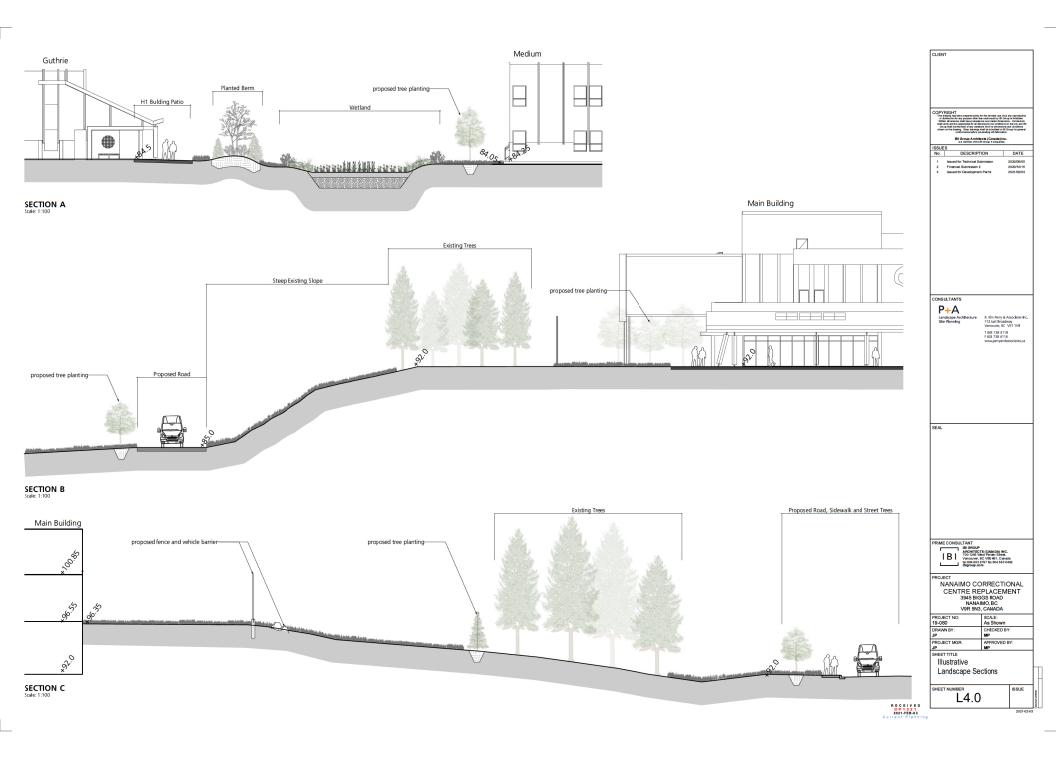
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VAL PLAZA	
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Visitor Arrival Plaza with Planting, Seating Elements and Flag Poles

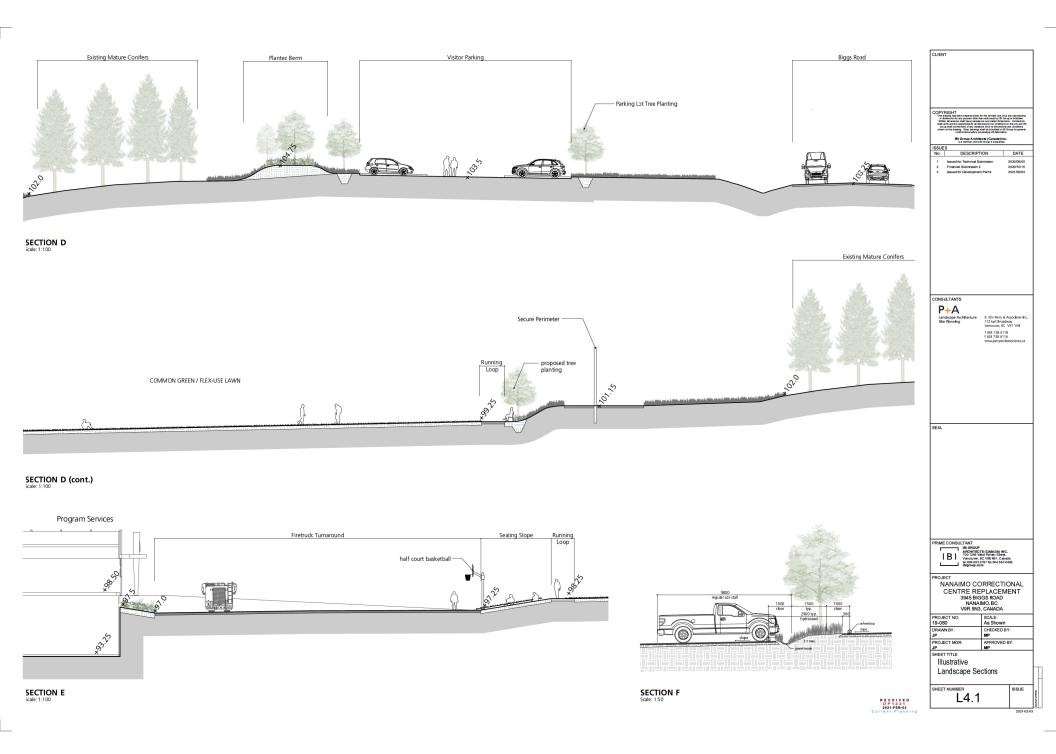L6.0

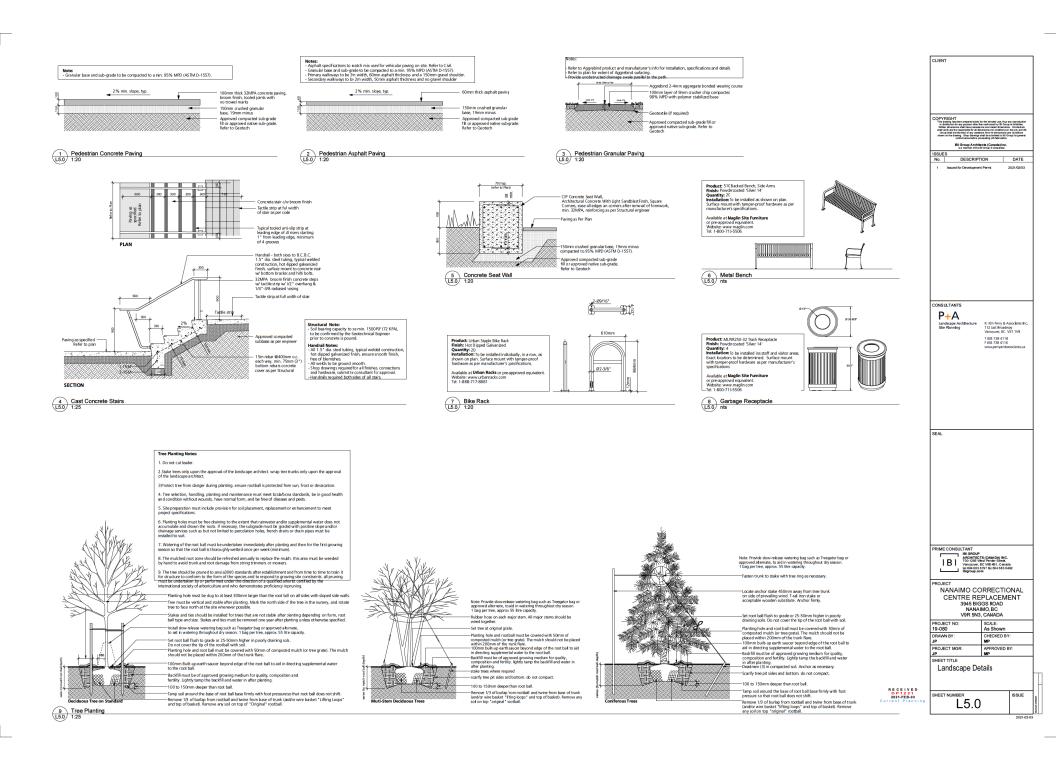















Maglin 250 Trash Container Powdercoat Silver 14, Surface Mount



Dero 'Single Locker', Powdercoat Grey - Secure Staff Bicycle Parking



Precast Concrete Whe







CONSULTANTS P+A

R. Kim Perry & Associates Inc 112 last Broadway Vantouver, BC V5T 1V9 T 604 738 4118 F 604 738 4116

PROJECT
NANAIMO CORRECTIONAL
CENTRE REPLACEMENT
3945 BIGGS ROD
NANAIMO BC
V9R 5N3, CANADA
L 9cu g:


19-080 DRAWN BY: JS	1:750 CHECKED BY:
PROJECT MGR:	APFROVED BY:


Landscape Precedents

L6.1


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Maglin 510 Backed Bench, Powdercoat Silver 14, Surface Mount Basketball Hoop



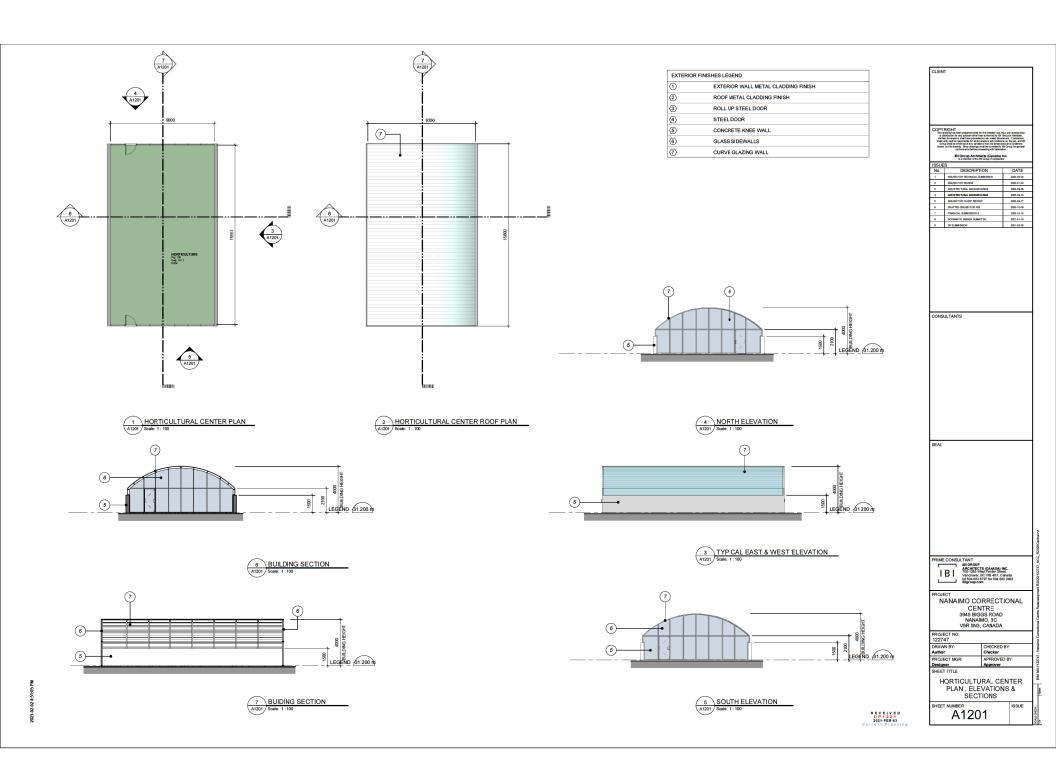

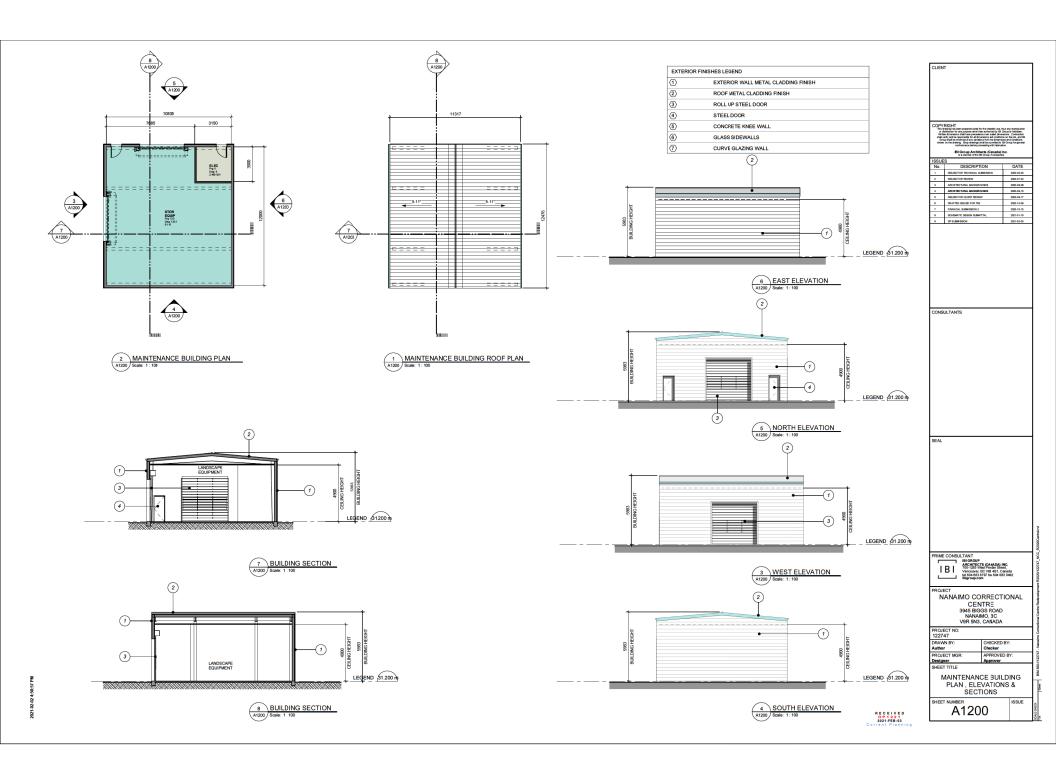AERIAL PHOTO



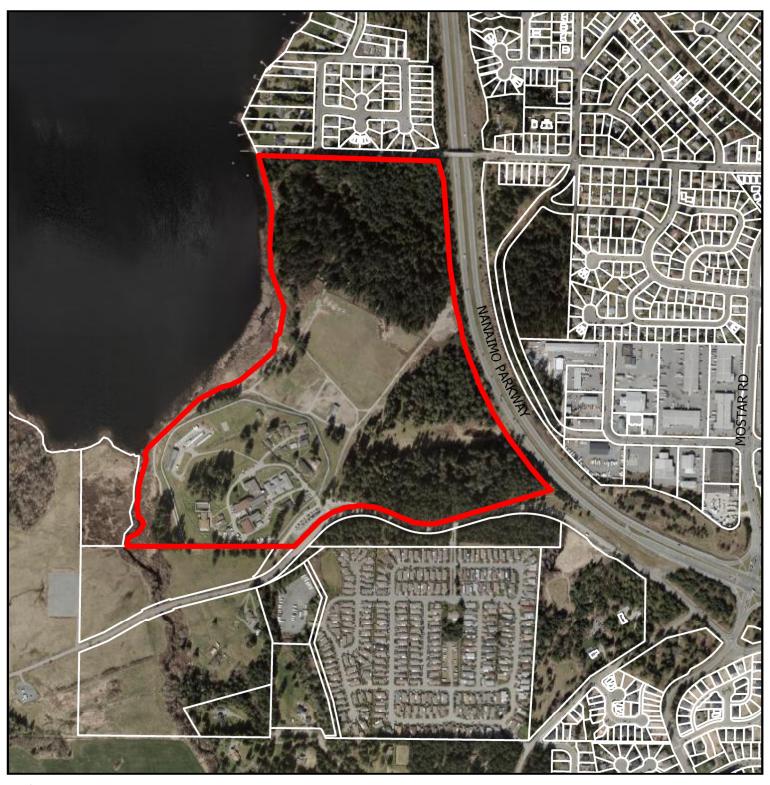

DEVELOPMENT PERMIT NO. DP001221



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