


ATTACHMENT A

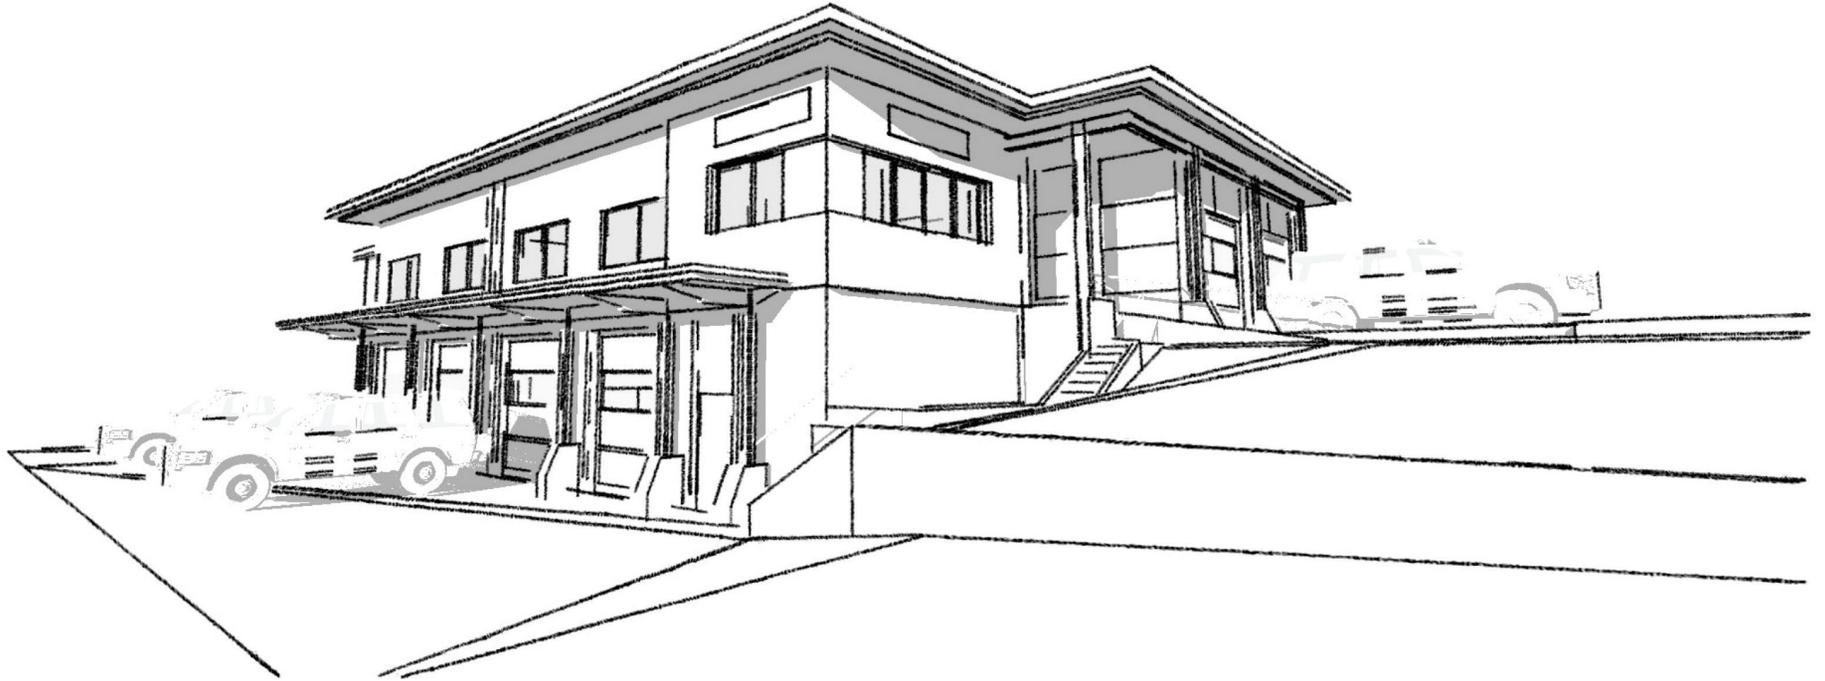

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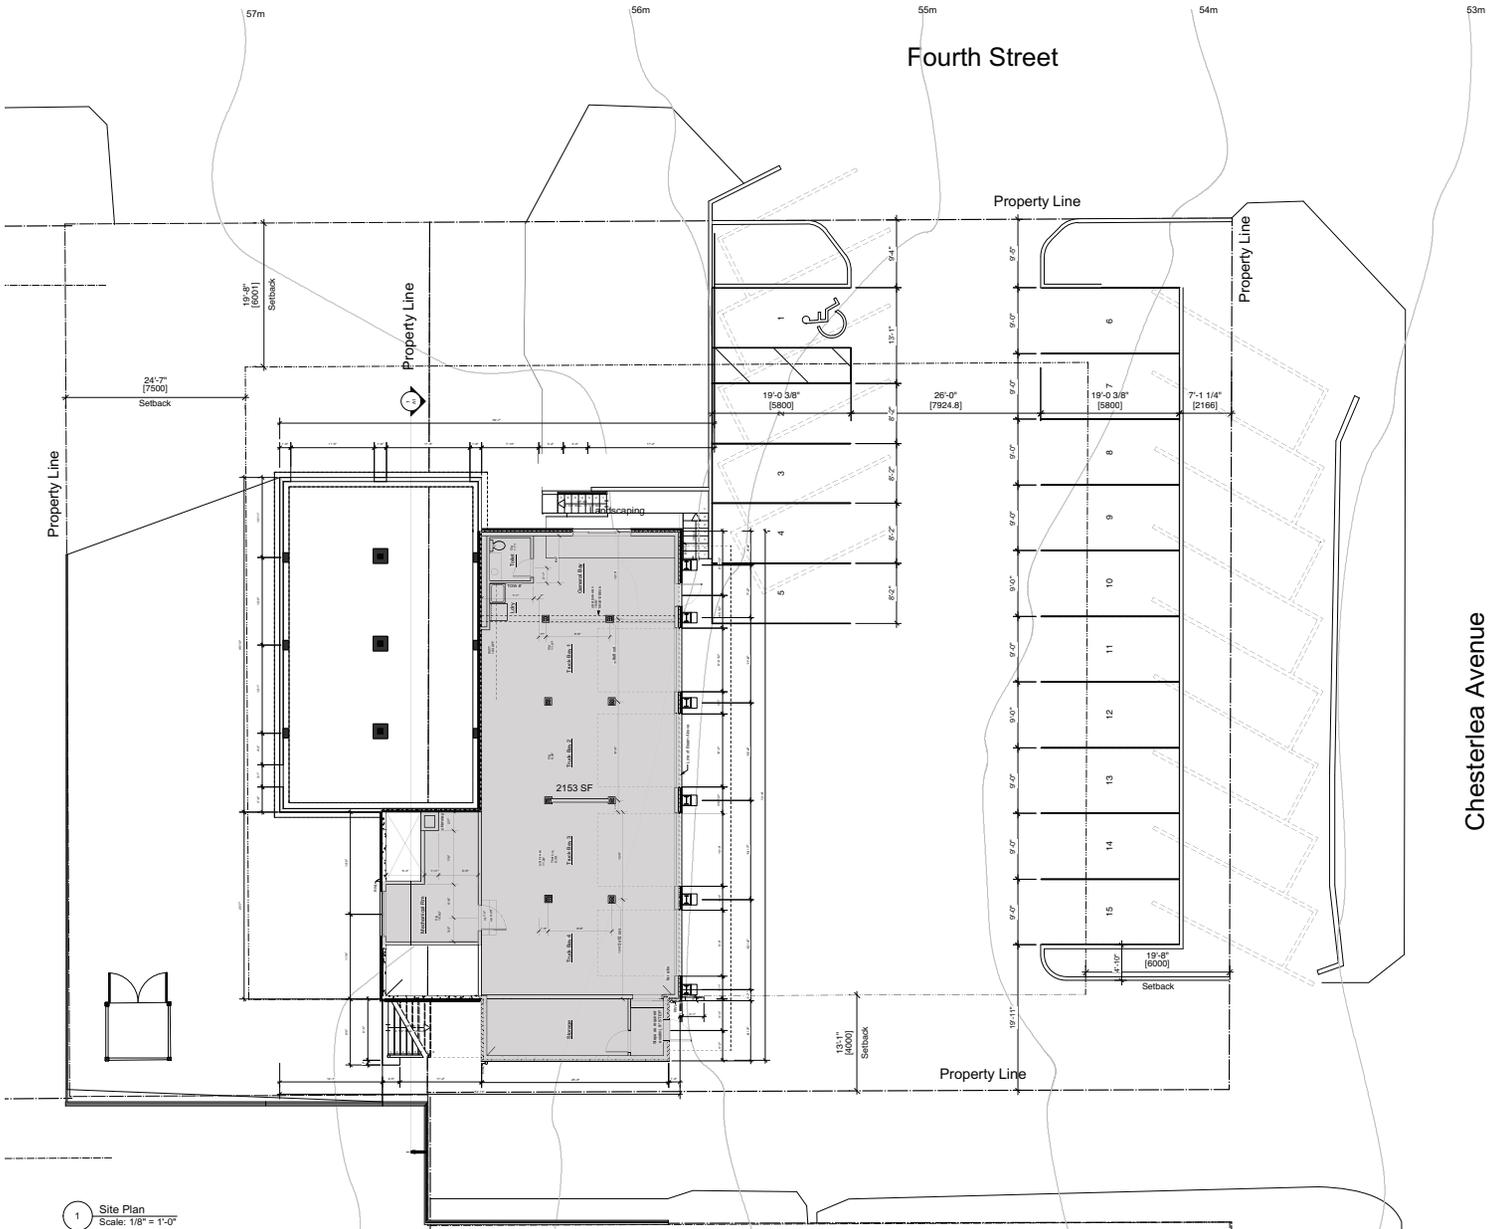
NOTES: All dimensions are shown in feet & inches.


de Hoog & Kieruff architects
 107 East 5th Street
 Nanaimo, BC V9B 2K1
 Tel: 250-251-5187

107 East 5th Street
 Nanaimo, BC V9B 2K1
 Tel: 250-251-5187

Nanaimo Search & Rescue
 1911 56th Street
 Nanaimo, BC

Cover Page
 A100 -



1 Site Plan
Scale: 1/8" = 1'-0"

2 Site Data

LEGAL DESCRIPTION
 LOT A, SECTION 1, NANAIMO DISTRICT, PLAN 10331, HAREWOOD FIREHALL-
 COMMUNITY HALL, ETC
 &
 THAT PART OF SECTION 28, RANGE 9, SECTION 1, NANAIMO DISTRICT, PLAN 630,
 SHOWN OUTLINED IN RED ON PLAN 563R (LEASE TO RDN - SEARCH & RESCUE)

Municipal Address
 191 & 195 Fourth Street,
 Nanaimo, B.C.

SITE DATA

Site Area : 13200 6000 19200 SF total
 Site coverage : 18.5%

Building Area:
 Main Floor: 3547 sq.ft. 329 m2
 Lower Floor: 2153 sq.ft. 200 m2

Occupancy unchanged
 Fire Hall / Search & Rescue
 Parking unchanged, Overhead doors reinstalled at lower level.

A total of 16 Currently provided, 3 to be removed at reinstallation overhead doors
 13 Provided Parking Stalls

Chesterlea Avenue

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de Hoog & Kieruff architects
 107 East Street
 Nanaimo, BC V9R 1K1
 Tel: 250-251-5157


107 East Street
 Nanaimo, BC V9R 1K1
 Tel: 250-251-5157

Nanaimo Search & Rescue
 191 & 195 4th Street
 Nanaimo, BC

Lower Level Site Plan



A101



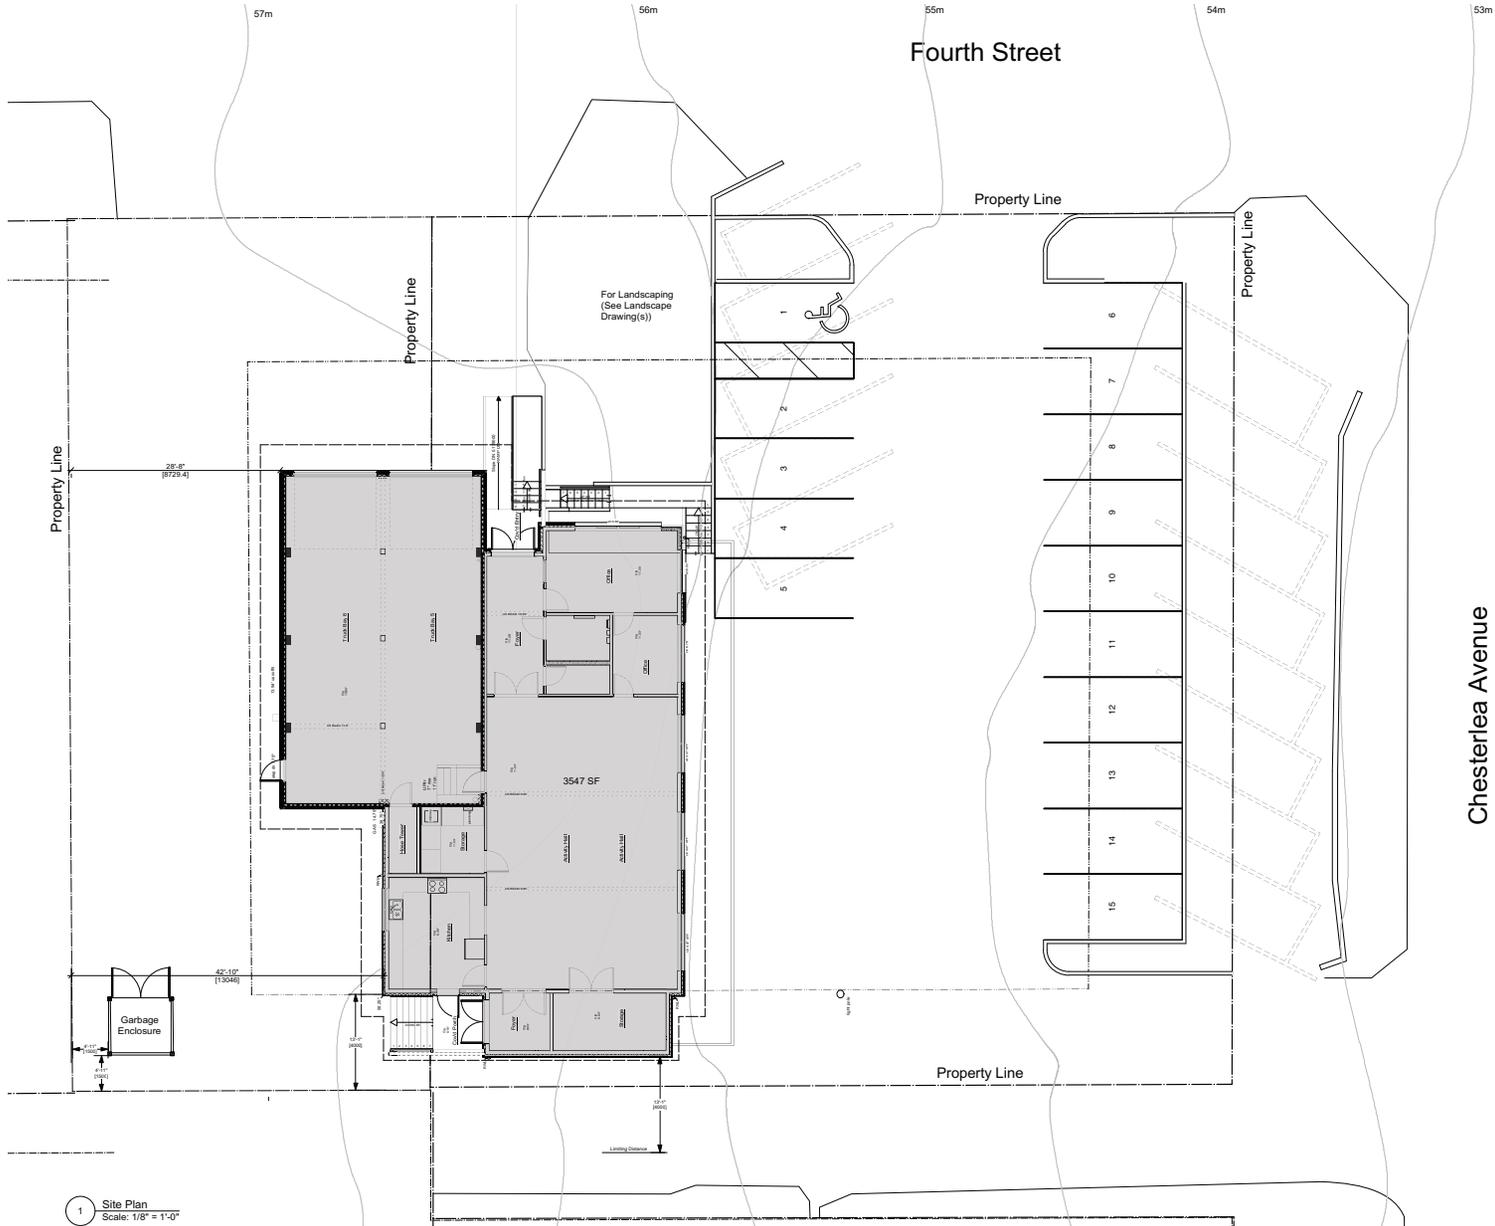

1 Site Plan
Scale: 1/8" = 1'-0"

2 Garbage Enclosure

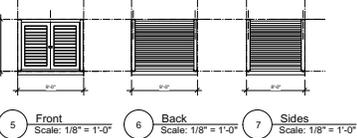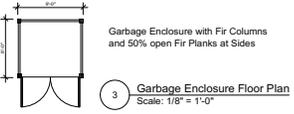

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11	2020-03-18	Issued for RP Application
12	2020-03-21	For Review
13	19-01-2020	Approved
14	18-01-2020	Approved
15	18-01-2020	Approved
16	18-01-2020	Approved
17	18-01-2020	Approved
18	18-01-2020	Approved
19	18-01-2020	Approved
20	18-01-2020	Approved

NOTE: All dimensions are shown in feet & inches

de Hoog & Kieruff architects
 1377 East Street
 Nanaimo, BC V9A 5K1
 1-250-464-5147

1377 East Street
 Nanaimo, BC V9A 5K1
 1-250-464-5147

Nanaimo Search & Rescue
 1311 50th Street
 Nanaimo, BC


Upper Site Plan

A102



Chesterlea Avenue

Fourth Street

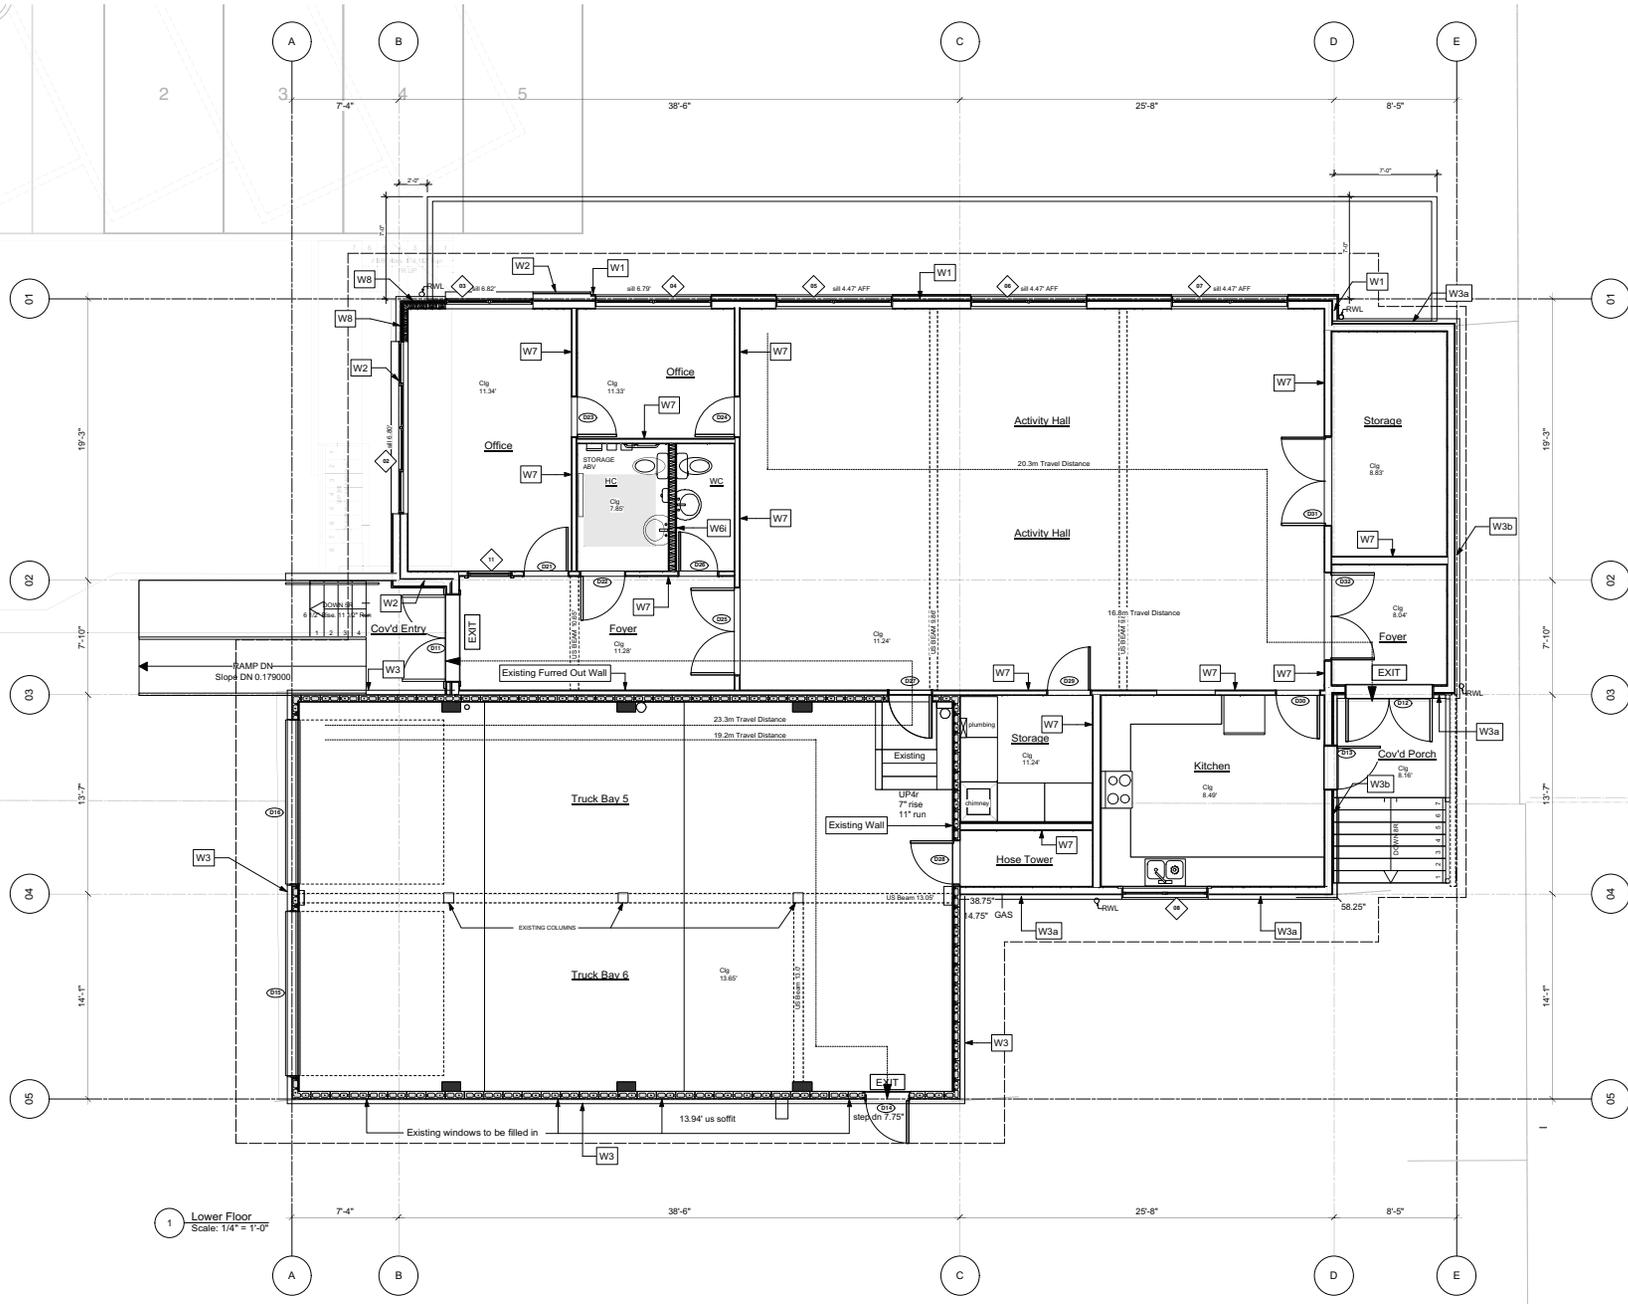

1 Lower Floor
Scale: 1/4" = 1'-0"

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11	2020-05-18	Issued for RF Application
12	2020-05-21	For Review
13	19-05-2020	Approved
14	18-05-2020	Approved
15	18-05-2020	Approved
16	18-05-2020	Approved
17	18-05-2020	Approved
18	18-05-2020	Approved
19	18-05-2020	Approved
20	18-05-2020	Approved

NOTE: All dimensions are shown in feet and inches.


de Hoog & Kieruff architects
 1377 East Street
 Nanaimo, BC V9A 5K1
 Phone: 250-754-1111
 Fax: 250-754-1112

Nanaimo Search & Rescue
 13911 95th Street
 Nanaimo, BC
 Phone: 250-754-1111
 Fax: 250-754-1112

Main Floor Plan

A201	-
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11	2020-05-18	Issued for RF Application
12	2020-05-21	Final Design
13	19-05-2020	RF Application
14	NAE	NAE
15	AK/MSD	MSD
16		MSD

NOTE: All dimensions are shown in Feet & Inches

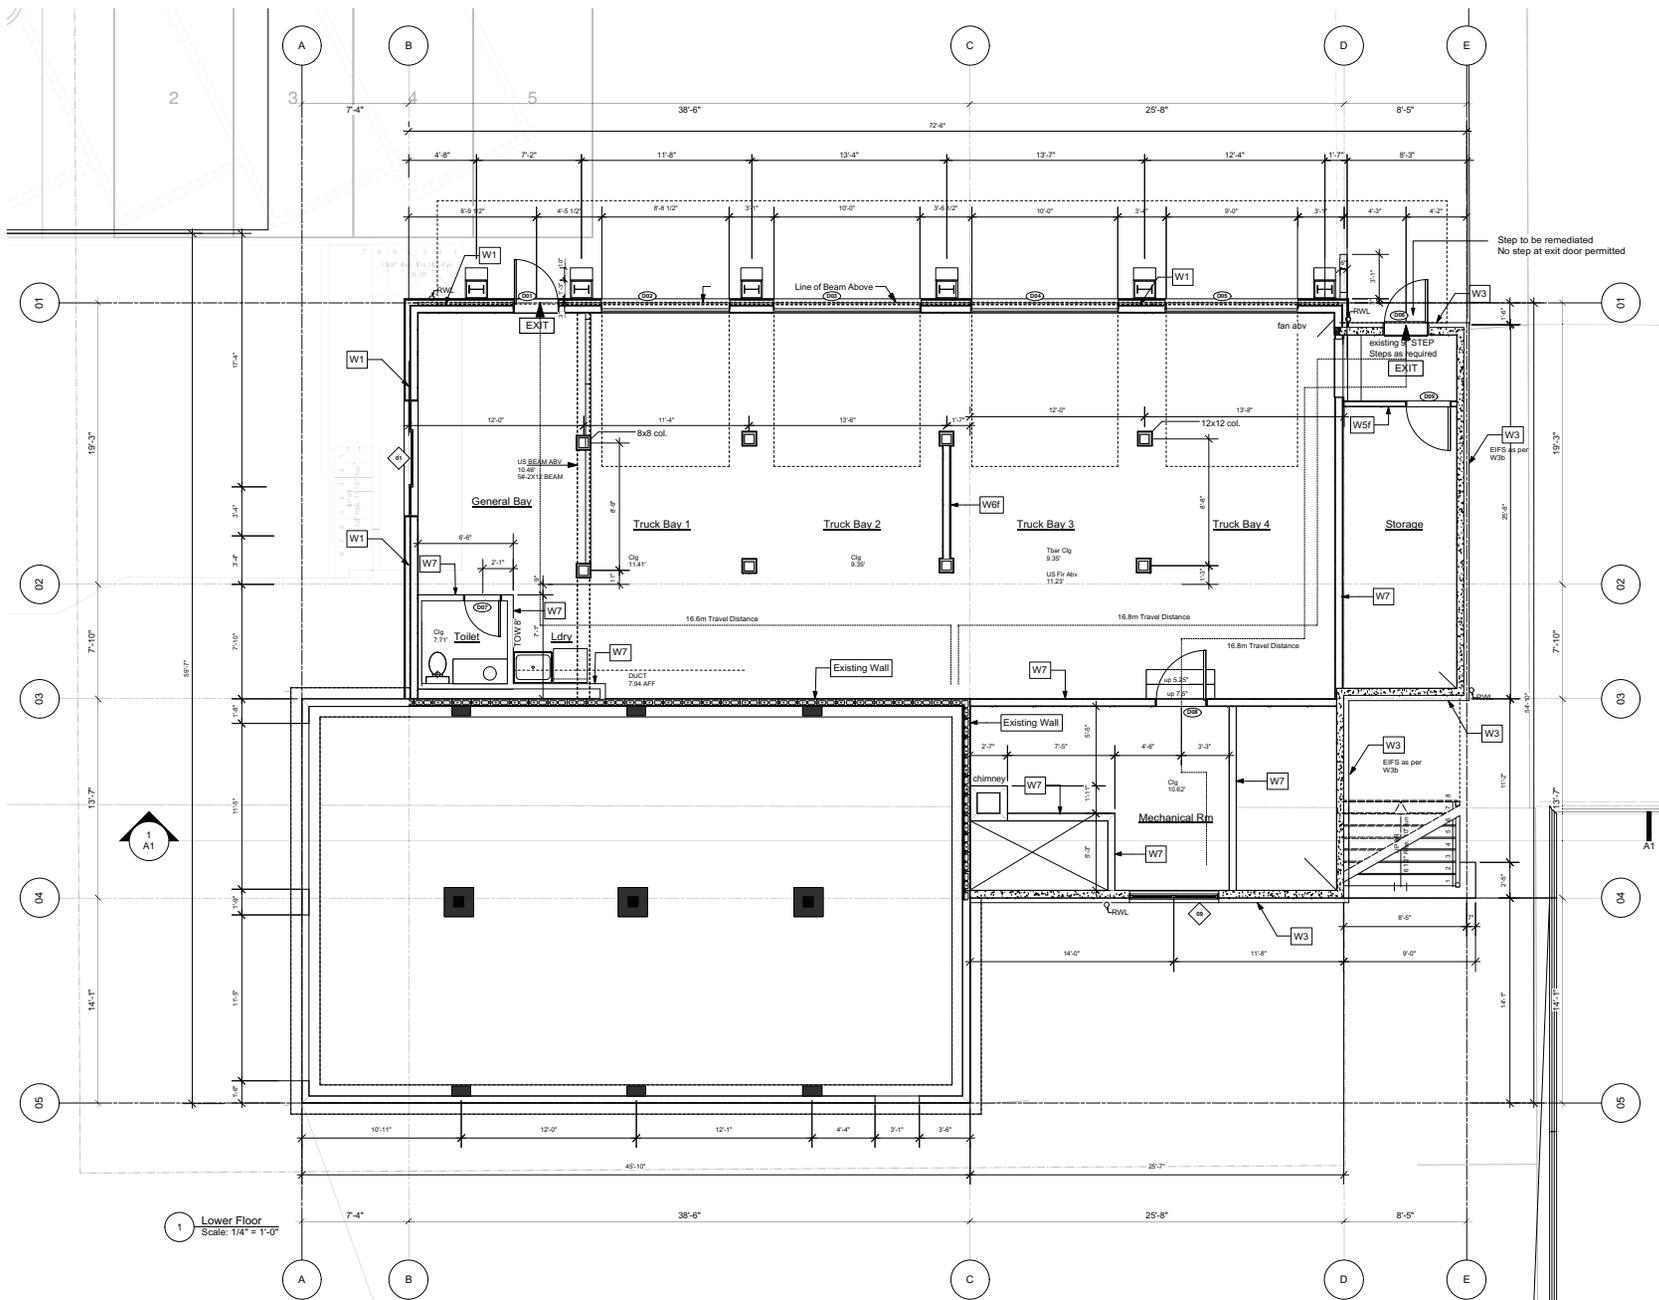de Hoog & Kieruff architects
 137 East 5th Street, Nanaimo, BC V9A 2E1
 250.248.1111


Nanaimo Search & Rescue
 1391-136 4th Street, Nanaimo, BC

Lower Floor Plan

A202



1 Lower Floor
 Scale: 1/4" = 1'-0"

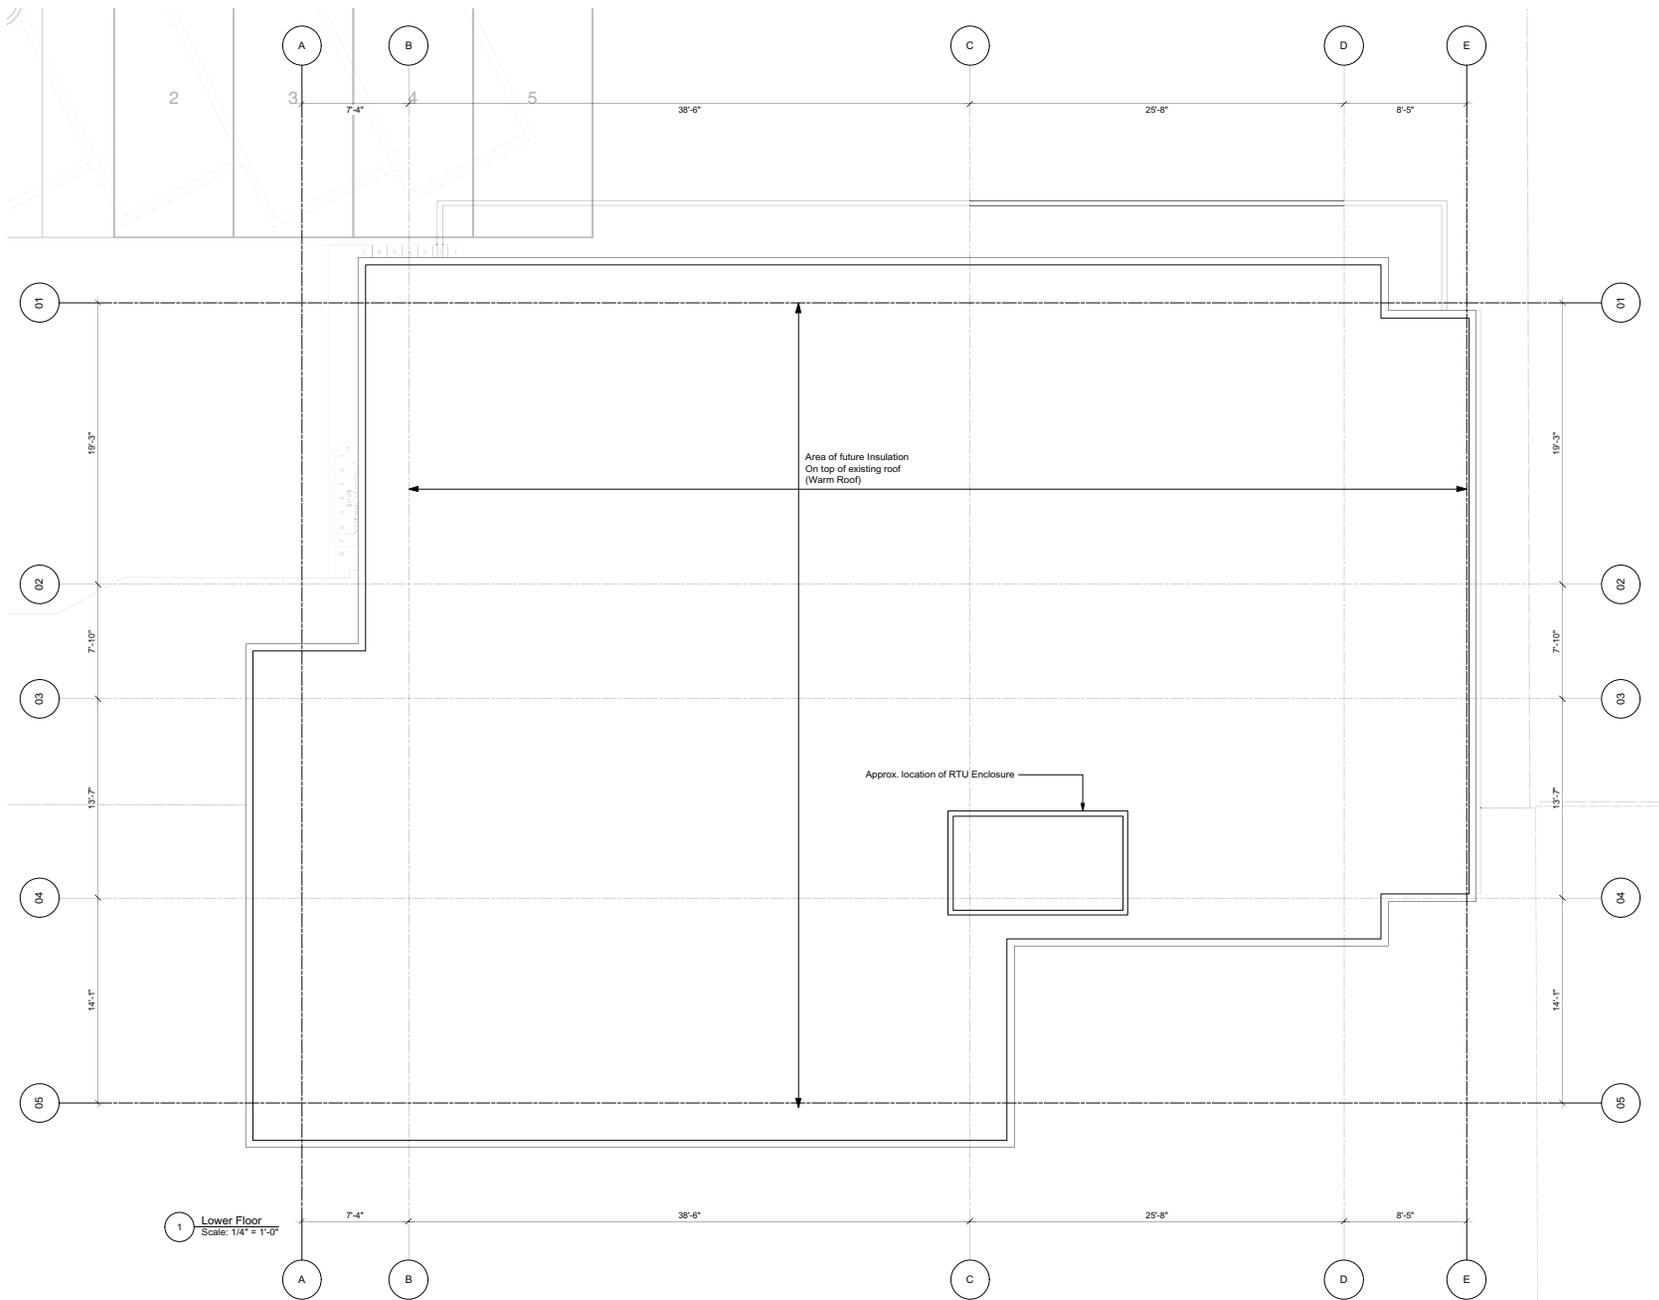

1 Lower Floor
Scale: 1/4" = 1'-0"

Area of future Insulation
On top of existing roof
(Warm Roof)

Approx. location of RTU Enclosure

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NOTE: All dimensions are shown in feet & inches

de Hoog & Kieruff architects
 1377 East 5th Street, Nanaimo, BC V9X 1K1
 250.248.5117


Nanaimo Search & Rescue
 1371 1/2 4th Street
 Nanaimo, BC

Roof Plan

Project No.	2020-02-21
Client	NSR
Scale	1/4" = 1'-0"
Date	2020-02-21
Drawn by	AK
Checked by	AK
Project	2020-02-21

A203



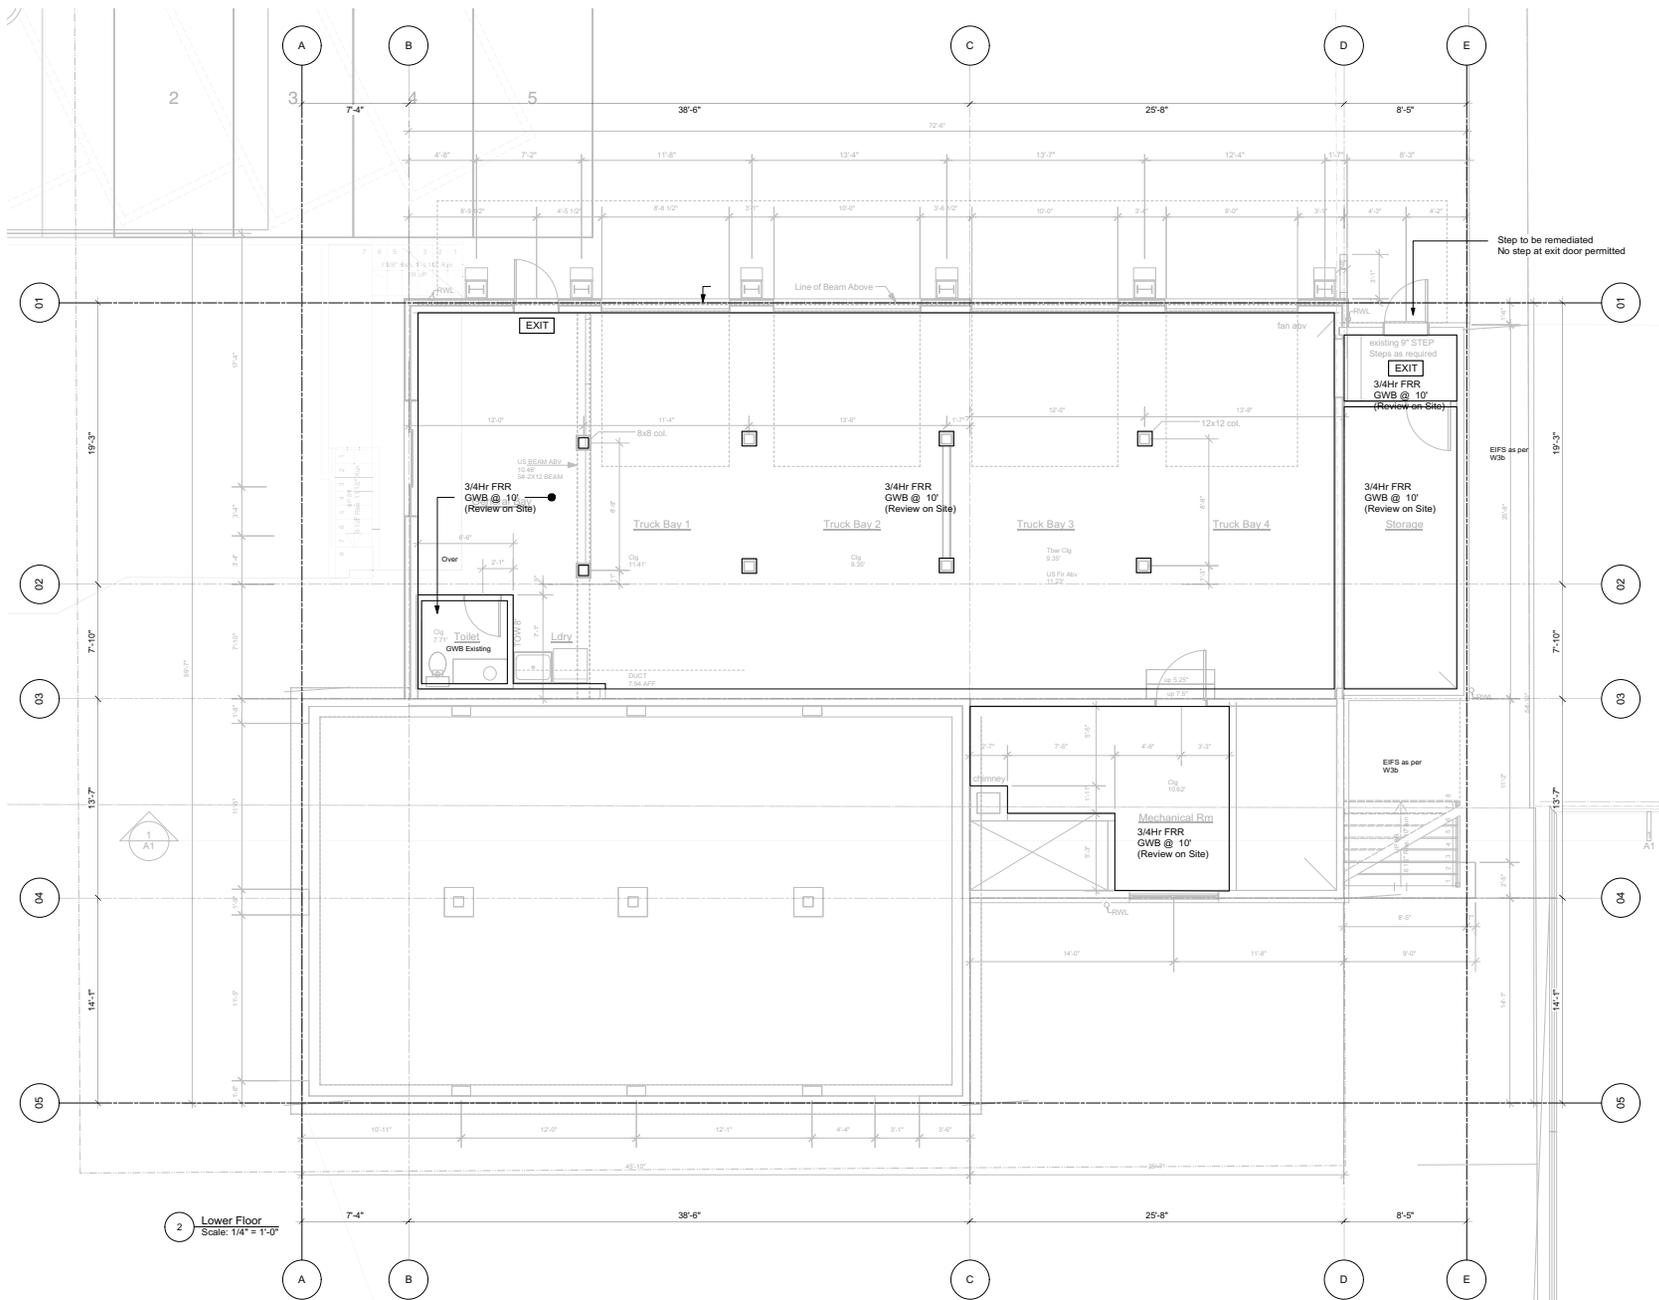

Step to be remediated
No step at exit door permitted

3/4 Hr FRR
GWB @ 10'
(Review on Site)

3/4 Hr FRR
GWB @ 10'
(Review on Site)

existing 9" STEP
Steps to be removed
EXIT
3/4 Hr FRR
GWB @ 10'
(Review on Site)
Storage

Mechanical Rm
3/4 Hr FRR
GWB @ 10'
(Review on Site)

EIFS as per
W30

2 Lower Floor
Scale: 1/4" = 1'-0"

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11	2020-05-18	Issued for RF Application
12	2020-05-21	For Review
13	18-05-2020	Approved
14	AK	OK
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18	AK	OK
19	AK	OK
20	AK	OK


NOTE: All dimensions are shown in feet & inches

de Hoog & Kieruff architects
 177 East 5th Street, Nanaimo, BC V9B 2G4
 250.755.1111 | 250.755.1112 | 250.755.1113

Nanaimo Search & Rescue
 1911 35th Street, Nanaimo, BC

RCP Lower Floor

Project No.	A204
Sheet No.	-

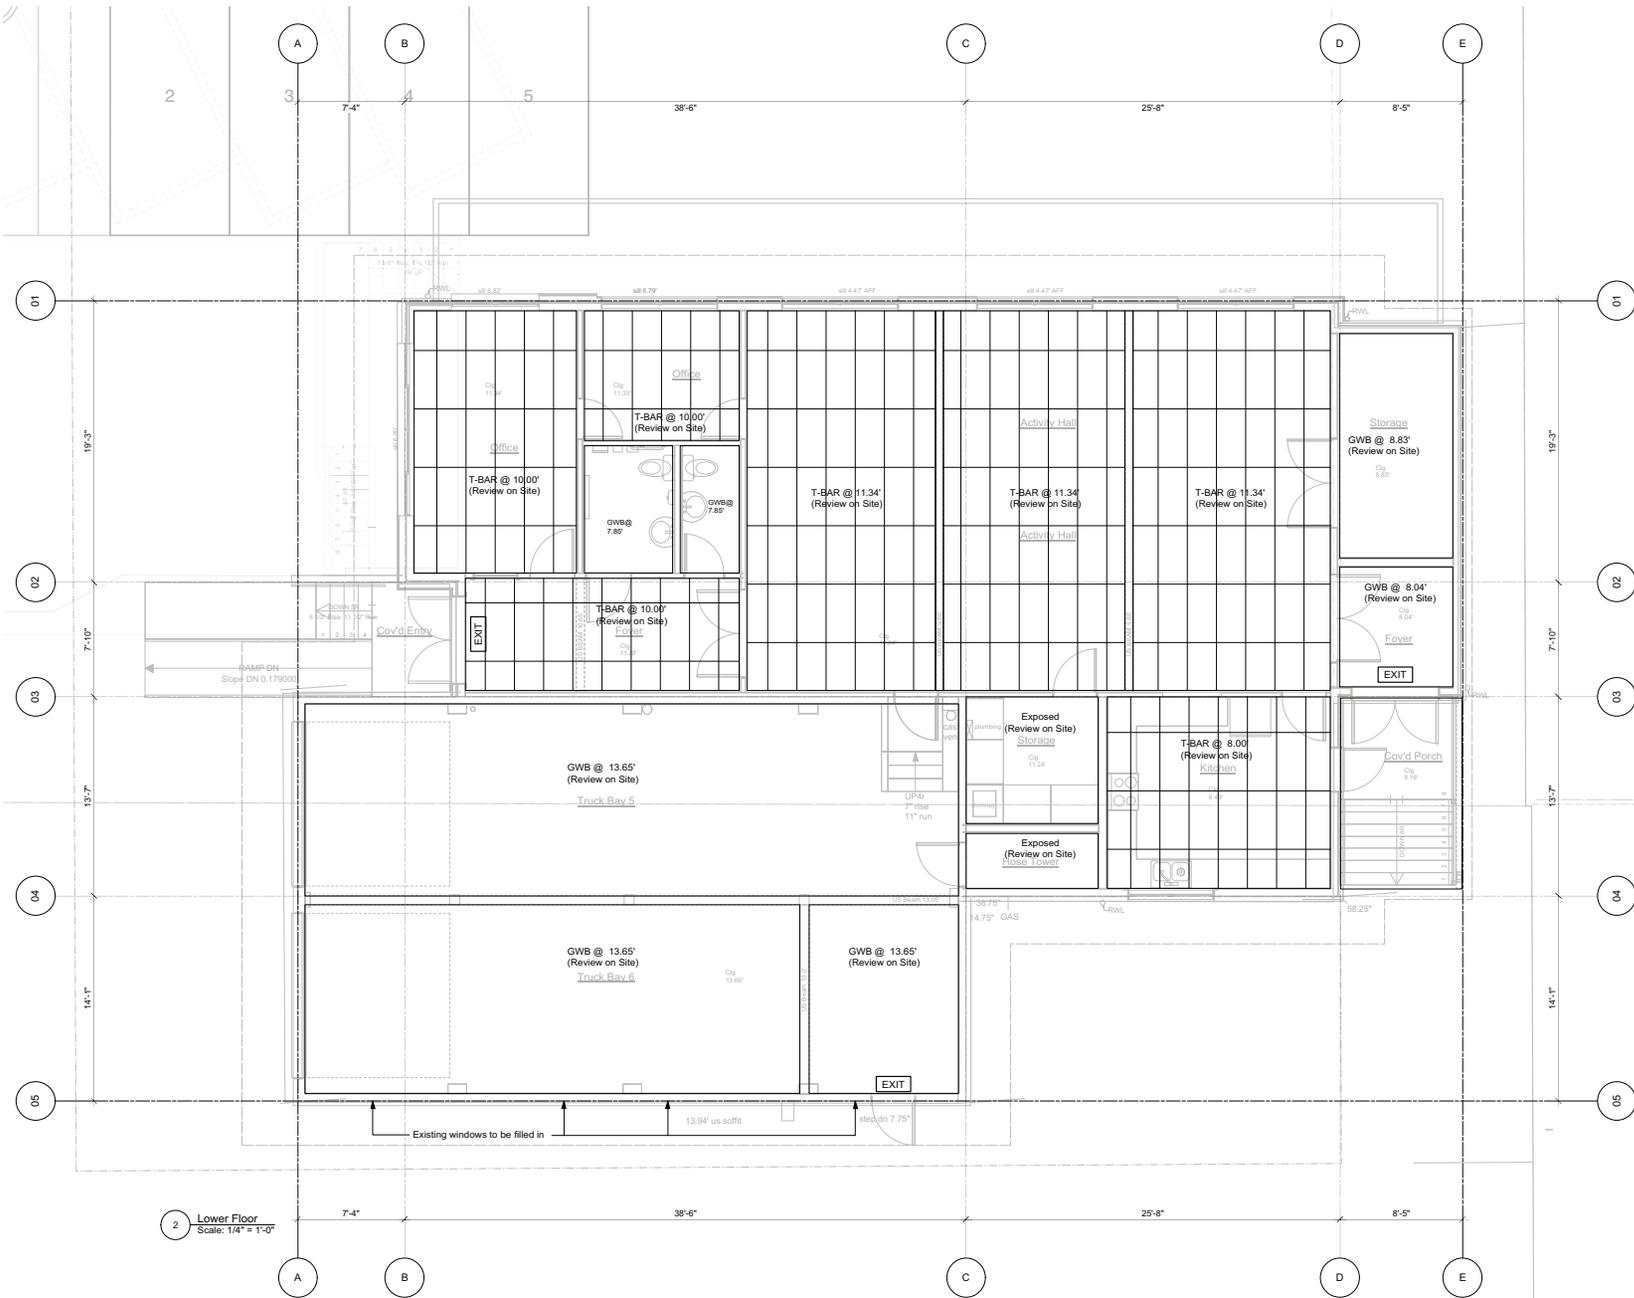

2 Lower Floor
Scale: 1/4" = 1'-0"


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de Hoog & Kieruff architects
 137 East 5th Street, Nanaimo, BC V9B 3K1
 107-6198 Pacific Way, Nanaimo, BC V9B 3K4
 1-250-454-5147





Nanaimo Search & Rescue
 1311 56th Street, Nanaimo, BC

RCP Main Floor

Project No.	2020-02-21
Client	SEARCH & RESCUE
Architect	de Hoog & Kieruff
Date	2020-02-21
Scale	1/4" = 1'-0"
Sheet No.	A205
Total Sheets	1

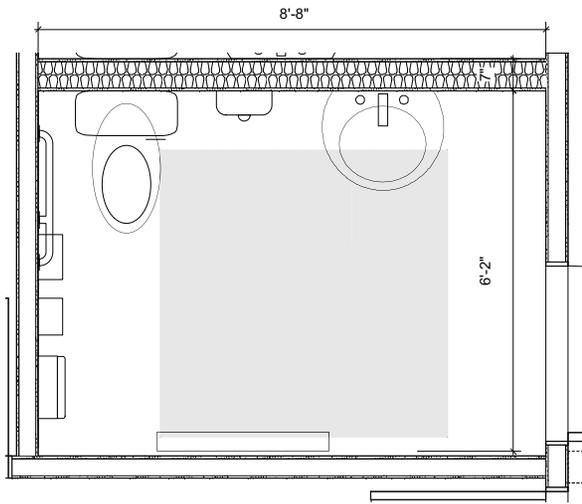

1 HIC PLAN
Scale: 1" = 1'-0"

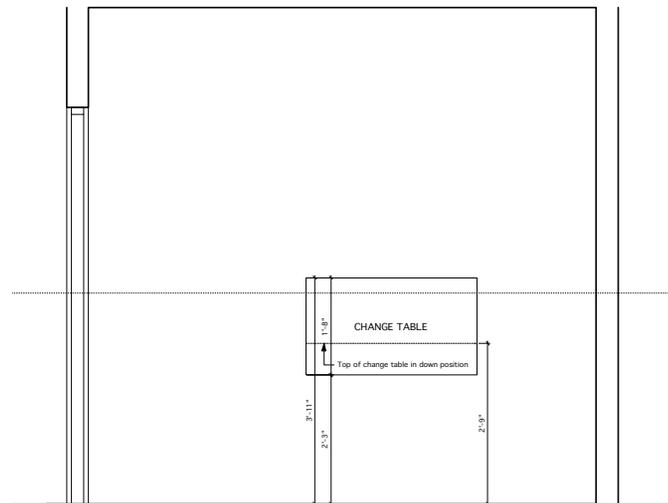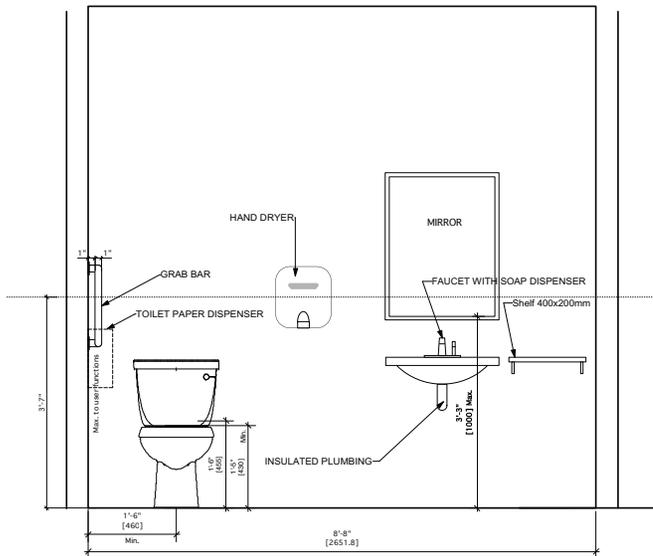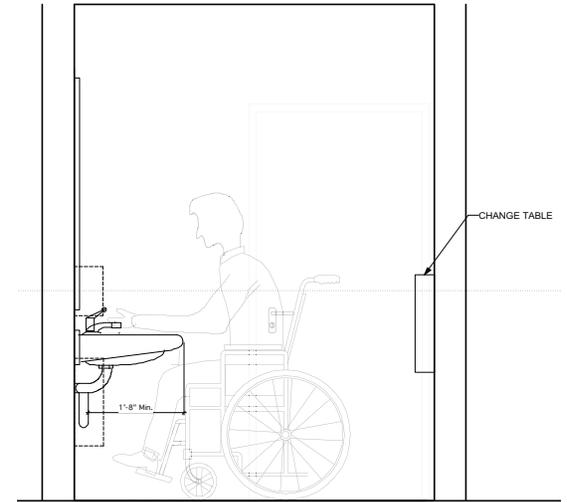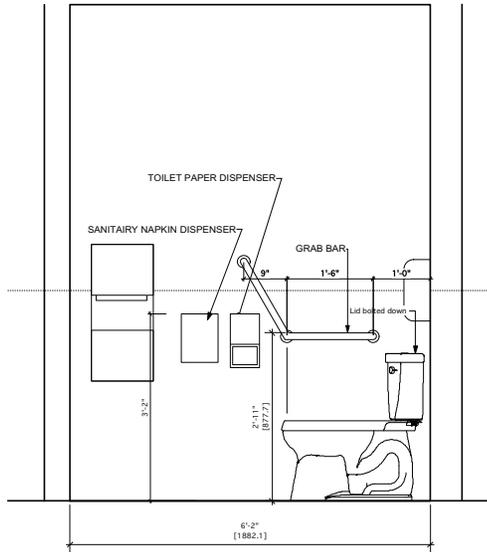

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11	2020-03-18	Issued for RF Application
12	2020-03-21	For Review
13	19-01-2020	Approved
14	18-01-2020	OK
15	18-01-2020	OK
16	18-01-2020	OK
17	18-01-2020	OK
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19	18-01-2020	OK
20	18-01-2020	OK

NOTE: All dimensions are shown in feet & inches


de Hoog & Kieruff architects
 137 East 5th Ave. | 107 East 5th Ave. West
 Nanaimo, BC V9S 1K3 | Nanaimo, BC V9S 1K6
 T 250-253-5187 | F 250-253-5189

Nanaimo Search & Rescue
 1311 36th Street
 Nanaimo, BC

HIC Washroom

Project No.	
Revision No.	
Scale	
Author	
Checker	
Designer	
Project Manager	
Client	
Site	
Date	
Sheet No.	A206
Total Sheets	-

Roof and Floor Elevations unchanged

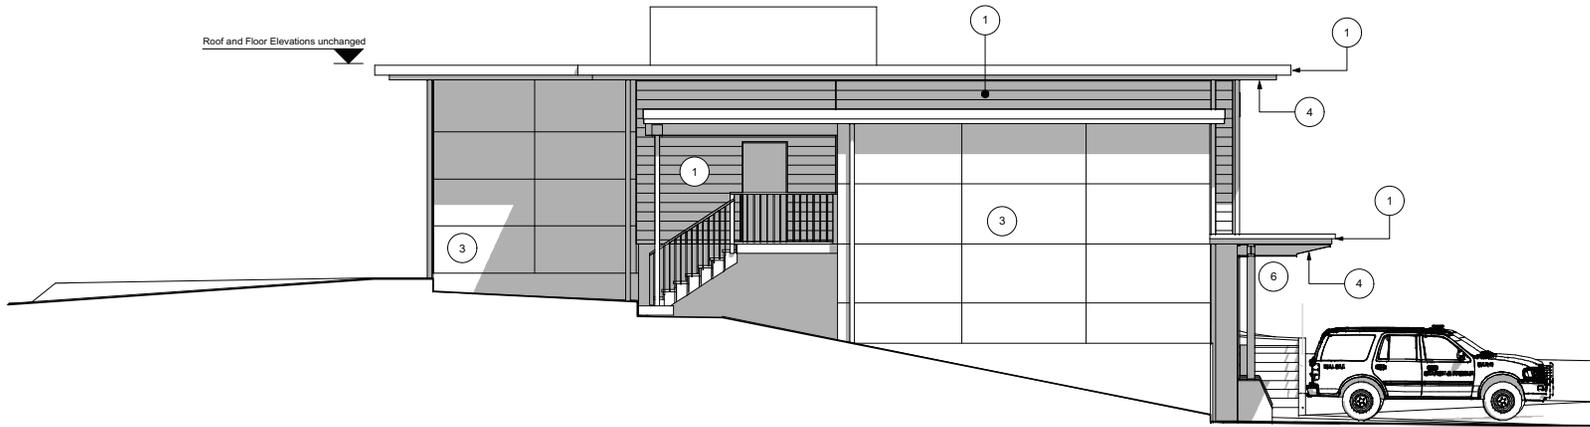

1 South Elevation
Scale: 1/4" = 1'-0"

1 Fibre Cement board
Fascia's and Wall



2 Corrugated Metal



3 EIFS



4 Vinyl Soffits, Wood look




5 Fibre Cement Panel
Blue Accent



6 Seismic Steel Structure
Yellow Accent



Roof and Floor Elevations unchanged

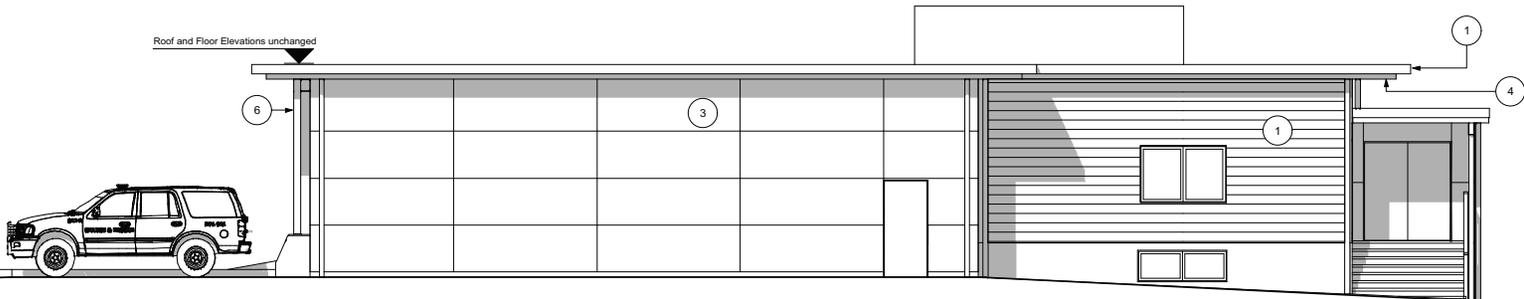

2 West Elevation
Scale: 1/4" = 1'-0"

1	0000-00-10	Issued for RF Application
2	0000-00-20	For Review
3	19-00-0000	Final
4	0000-00-00	OK
5	0000-00-00	OK


NOTE: All dimensions are shown in feet & inches


de Hoog & Kieruff architects
 1377 East 5th Street
 Nanaimo, BC V9Y 1K1
 Tel: 250-754-5147


1076-10880 Highway 10
 1076-10880 Highway 10
 Nanaimo, BC V9Y 1K1
 Tel: 250-754-5147

Nanaimo Search & Rescue
 13911 50th Street
 Nanaimo, BC


Elevations 2
 A302 -

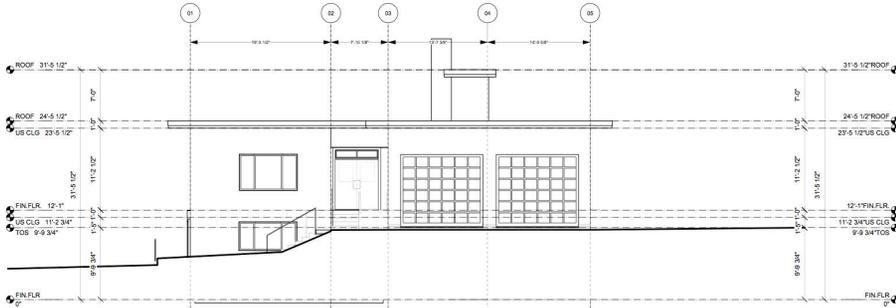


4 NORTH ELEVATION
Scale: 1/8" = 1'-0"

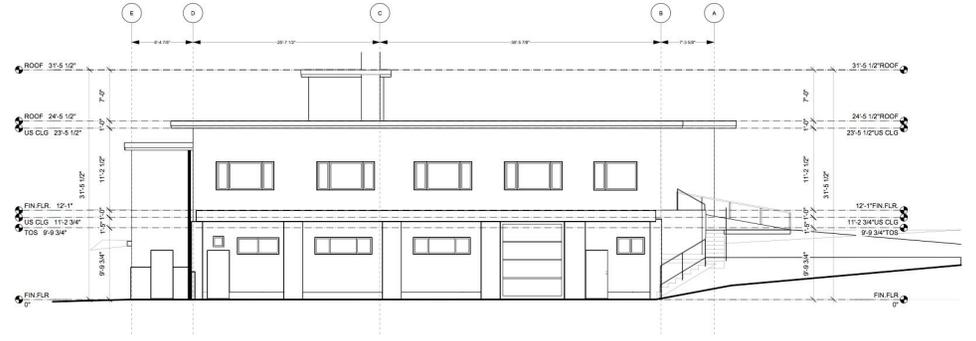

1 EAST ELEVATION
Scale: 1/8" = 1'-0"

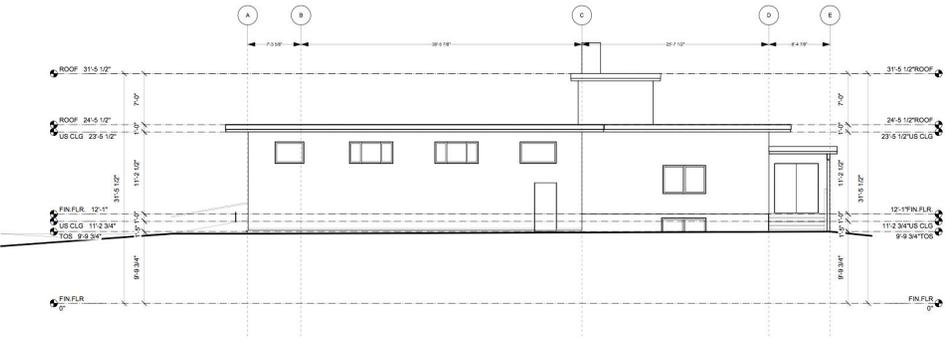

5 WEST ELEVATION
Scale: 1/8" = 1'-0"

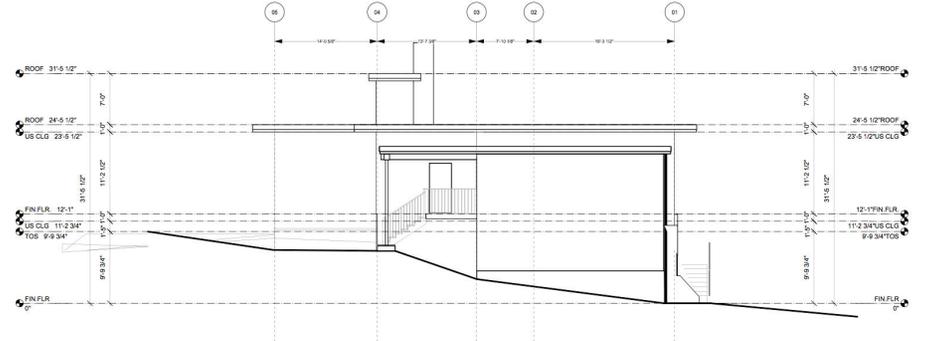

3 SOUTH ELEVATION
Scale: 1/8" = 1'-0"

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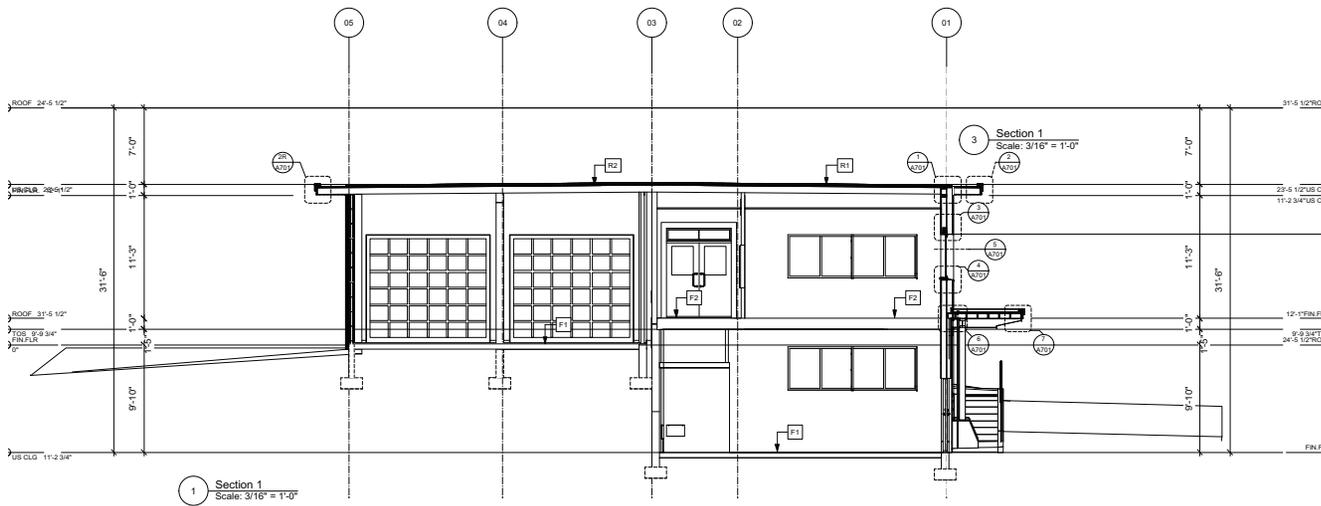
NOTES: All dimensions are shown in feet & inches.

de Hoog & Kieruff architects
 137 East 5th Street, Nanaimo, BC V9B 2K1
 250.755.1111, 250.755.1112, 250.755.1113
 1070 Douglas Street, Nanaimo, BC V9B 2K1
 250.755.1111, 250.755.1112, 250.755.1113


Nanaimo Search & Rescue
 1311 56th Street
 Nanaimo, BC

Elevations Existing

NO. 1	NO. 2
NO. 3	NO. 4
NO. 5	NO. 6
NO. 7	NO. 8
NO. 9	NO. 10
NO. 11	NO. 12
NO. 13	NO. 14
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1 Section 1
Scale: 3/16" = 1'-0"



2 Section 2
Scale: 3/16" = 1'-0"
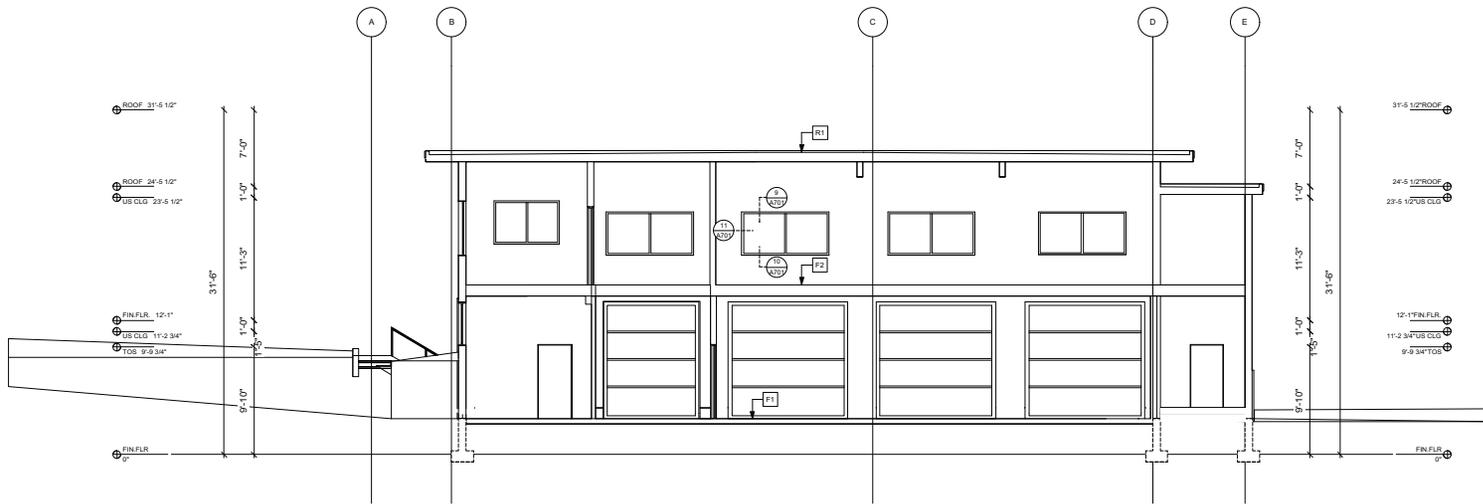
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11	2020-05-18	Issued for RF Application
12	2020-05-21	For Review
13	19-05-2020	Approved
14	NAE	Client
15	Architect	Project
16		00002

NOTE: All dimensions are shown in Feet & Inches

de Hoog & Kieruff architects
 137 East 5th Street, Nanaimo, BC V9A 2K1
 107 East 5th Street, Nanaimo, BC V9A 2K1
 250-755-5117, 250-755-5118, 250-755-5119

Nanaimo Search & Rescue
 1371 26th Street
 Nanaimo, BC

Sections

Section	A401	-
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1 ASSEMBLIES

W1		EXTERIOR WOOD FRAME WALL (Heated) <ul style="list-style-type: none"> 5/16" Fibre Cement Plank 3/4" 1x4 FT Strapping 4" EPS c.l. Insulation, R16 Tyvek commercial wrap air - moisture barrier Existing Plywood 3 1/2" Wood Studs @ 600mm. o.c. 5/8" Type "X" GWB 	
W2		EXTERIOR STEEL FRAME WALL (Heated) <ul style="list-style-type: none"> 7/8" Corrugated metal (Horizontal) 1/2" Hat rack Rain screen drainage system 6" EPS c.l. Insulation, R24 Tyvek commercial wrap air - moisture barrier Existing Plywood 3 1/2" Wood Studs @ 600mm. o.c. 5/8" Type "X" GWB 	
W3		EXTERIOR CONCRETE BLOCK WALL (Heated) <ul style="list-style-type: none"> 4" EPS Exterior EPS insulation c/w Synthetic Stucco Finish, U=0.064 or R16 (Continuous Insulation) (Dryvit) Rain screen drainage system according manufacturers instructions Moisture / Air barrier according manufacturers instructions Existing (152mm) Reinforced Concrete Block or Poured Concrete (refer to structural for rebar/cmp) 	
W3a		EXTERIOR WOOD FRAME WALL (Heated) <ul style="list-style-type: none"> 4" EPS Exterior EPS insulation c/w Synthetic Stucco Finish, U=0.064 or R16 (Continuous Insulation) (Dryvit) Rain screen drainage system according manufacturers instructions Moisture / Air barrier according manufacturers instructions Existing Plywood 3 1/2" Wood Studs @ 600mm. o.c. 5/8" Type "X" GWB 	
W3b (AS W3a)		EXTERIOR WOOD FRAME WALL (Heated) <ul style="list-style-type: none"> 4" EPS Exterior EPS insulation c/w Synthetic Stucco Finish, U=0.064 or R16 (Continuous Insulation) (Dryvit) Rain screen drainage system according manufacturers instructions Moisture / Air barrier according manufacturers instructions Existing Plywood 3 1/2" Wood Studs @ 600mm. o.c. 5/8" Type "X" GWB 	
W4		EXTERIOR WOOD FRAME WALL (Heated) <ul style="list-style-type: none"> 5/16" Fibre Cement Paneling 3/4" 1x4 FT Strapping 4" EPS c.l. Insulation, R16 Tyvek commercial wrap air - moisture barrier Existing Plywood 3 1/2" Wood Studs @ 600mm. o.c. 5/8" Type "X" GWB 	
W5 W5f		INTERIOR WALL (CBC 2018, W1d) <ul style="list-style-type: none"> 5/8" Gwb Type X 3 1/2" Wd Studs @ 16-24" o.c. 5/8" Gwb Type X <p>W5f with 1hr FRR (ULC Design U309)</p>	STC 32
W6 W6i W6f		INTERIOR WALL (CBC 2018, W1a) <ul style="list-style-type: none"> 5/8" Gwb Type X 5 1/2" Wd Studs @ 16-24" o.c. 5/8" Gwb Type X W6i with acoustic batt insulation W6f with 1 hr FRR (ULC Design U309) 	STC 32 / 36
W7		INTERIOR WALL EXISTING <ul style="list-style-type: none"> Gwb Studs Gwb 	
W8		EXTERIOR WOOD FRAME WALL (Heated) <ul style="list-style-type: none"> 5/16" Fibre Cement Plank 3/4" 1x4 FT Strapping 4" EPS c.l. Insulation, R5 Tyvek commercial wrap air - moisture barrier Existing Plywood 5 1/2" Wood Studs @ 600mm. o.c. filled with FG Batt Insulation (R21) Gwb Poly Vapour retarder (overlapping) 5/8" Type "X" GWB 	


F1		EXISTING CONCRETE SLAB ON GRADE <ul style="list-style-type: none"> CONCRETE SLAB ON GRADE (see structural) UNKNOWN SUB FLOOR CONDITIONS
F2		MAIN FLOOR - 1HR F.R.R. / CBC F4a 1 HR. F.R.R. (CBC Appendix D D-2.3.4.4,F,G) <ul style="list-style-type: none"> 1/2" SUB FLOOR 5/8" PL WOOD (see structural) 3/4" T&G SHLAP (see structural) 2X10" WOOD JOIST @ 16" O/C (see structural) REBAR AT 16" O/C 2 LAYERS 1/2" TYPE X GYPSUM WALLBOARD
R1		FLAT ROOF (Existing) <ul style="list-style-type: none"> AS IS. NEW 1-BAR CEILING
R2		FLAT ROOF (TO RCBC STANDARDS) <ul style="list-style-type: none"> AS IS. EXISTING ROOF SHEATHING (REPAIRED WHERE NEEDED) EXISTING ROOF STRUCTURE EXISTING GYPSUM WALLBOARD CEILING RENEW WERE NEEDED

2 BUILDING CODE SUMMARY


Article	Code Requirements	CBC 2018	Comments	Mar 19, 2025
	Sprinklered	Yes	To be added to existing	
	Fire Alarm	NO		
	No. of Storeys	2 Storey		
3.1.2.1.	Occupancy Classification:	Part 3, A2 Assembly F5 Storage garage		
3.1.3.1.	Major Occupancy Separation	1 Hr FRR requirement between A and F1		
3.1.17.1	Occupant Load	Unchanged use	As per existing	
3.2.2.86.	Building Classification:	Combustible or non-combustible construction	Combustible Construction	
3.2.2.86.(a)	Combustible or non-combustible construction	OK	Combustible Construction	
3.2.2.86.	Roof Assembly F.R.R.	N/A		
3.2.2.86.(2)(a)	Floor Assembly F.R.R.	Fire Separation & Fire Resistance Rating min. 3/4 HR if of combustible construction		
3.2.2.86.(2)(b)	Load Bearing Assembly F.R.R.	3/4 HR or Non-combustible		
3.2.3.1.-D	Limiting Distance @ North	100% unprotected openings allowed at Ld of 0m. (existing 3m)	Actual distance > 6m No FRR required (3.2.3.7)	
3.2.3.1.-D	Limiting Distance @ South towards street	19.9m2 m2 exposing building face. 100% unprotected openings allowed at Ld of 4m.	Actual distance = 4m No FRR required (3.2.3.7)	
3.2.3.1.-D	Limiting Distance @ South towards Residential	19m2 m2 exposing building face. 100% unprotected openings allowed at Ld of 3m.	Actual distance = 3m No FRR required (3.2.3.7)	
3.2.3.1.-D	Limiting Distance @ West	67m2 exposing building face. 100% unprotected openings allowed at Ld of 7m.	Actual distance > 7m No FRR required (3.2.3.7)	
3.2.3.1.-D	Limiting Distance @ East	69m2 exposing building face. 100% unprotected openings allowed at Ld of 7m.	Actual distance > 7 No FRR required (3.2.3.7)	
3.3.1.21.(3)	Janitor's Rooms	Fire Separation with OHR FRR (Sprinklered Floor Area)		
3.3.5.5	Repair Garage Separation	2 HR Fire Separation not required	Other functions Part of Garage	
3.1.8.4.(2)	45 Min. Closures Allowed	>= 1HR Fire Separation	N/A	
3.1.17.1	Occupant Load	N/A	N/A	
3.4.2.3	Distance Between Exits	1/2 of Maximum Diagonal Floor Area but Not > 9m. or Fire Separation 1/3 Floor Area	N/A	
3.4.2.5	Travel Distance	< 45m (Impedance < 100 Ft)	General	
3.7.2.2	Two existing washrooms upstairs One existing washroom downstairs	The two washrooms will be renewed and one will be an Accessible H/C Washroom		
3.8.2.7	Floor Drains	Where Available	N/A	
3.8.	Accessibility: General	Exempt Storey Above or Below, Access from Street to Main Entry, Parking, Toilet Room, Other Washroom (>150 Persons), Power Assisted Doors, Access to Areas Admitted to Public	N/A Yes Yes Yes N/A Yes	
3.8.3.6.	Interior Passageways	<= 13 mm Change G/F Floor Level, Except as Ramped		

5 DOOR SCHEDULE

DOOR NO	ROOM NAME	DOORS		WIDTH Ft	HEIGHT Ft to FFE	Header	MAT	FRR	FN	AUTO DOOR OPENER	Frame			Keyed	HARDWARE SET	REMARKS	2020-03-19
		AMOUNT	TYPE								Mat	FN	Closer				
001	General Bay 1	1	1	3'-0"	Exist				PT	-	PT	X	X		Panic h/w Weather Stripping, Existing		
002	Truck Bay 1	1	4	8'-10"	10'-0"	HMI	PT	-	STL	Galv	-	-	-	-	Lock Weather Stripping, insulated, O/H-dr		
003	Truck Bay 2	1	4	10'-0"	10'-0"	HMI	PT	-	STL	Galv	-	-	-	-	Lock Weather Stripping, insulated, O/H-dr		
004	Truck Bay 3	1	4	10'-0"	10'-0"	HMI	PT	-	STL	Galv	-	-	-	-	Lock Weather Stripping, insulated, O/H-dr		
005	Truck Bay 4	1	4	9'-0"	10'-0"	HMI	PT	-	STL	Galv	-	-	-	-	Lock Weather Stripping, insulated, O/H-dr		
006	EXIT	1	1	3'-0"	Exist	HMI	PT	-	HMI	PT	X	X			Panic h/w Weather Stripping, Existing Door		
007	Washroom	1	1	Exist	Exist	Wd	PT	-	WD	PT	-	-	-	-	Privacy Weather Stripping, Existing Door		
008	Mesh Room	1	1	Exist	Exist	Wd	PT	-	WD	PT	-	-	-	-	Lock Weather Stripping, Existing Door		
009	Storage	1	1	3'-0"	Exist	Wd	PT	-	WD	PT	-	-	-	-	Lock Weather Stripping, Existing Door		
010	N/A			-	-	-	-	-	-	-	-	-	-	-	-	-	
011	Main Entry	2	2	3'-0"	Exist	Exist	PT	-	Exist	PT	X	X			Panic h/w Weather Stripping, Existing Door		
012	EXIT	2	1	3'-0"	Exist	Exist	PT	-	Exist	PT	X	X			Panic h/w Weather Stripping, Existing Door		
013	Exterior into Kitchen	1	1	3'-0"	Exist	Exist	PT	-	Exist	PT	-	X			Lock Weather Stripping, Existing Door		
014	Ext. into Truck Bay	1	1	3'-0"	Exist	Exist	PT	-	Exist	PT	X	X			Panic h/w Weather Stripping, Existing Door		
015	Truck Bay 5	1	4	11'-3"	Exist	HMI	PT	-	STL	Galv	-	-	-	-	Lock Weather Stripping, insulated, O/H-dr		
016	Truck Bay 6	1	4	11'-3"	Exist	HMI	PT	-	STL	Galv	-	-	-	-	Lock Weather Stripping, insulated, O/H-dr		
021	Into Office	1	2	3'-0"	Exist	Wd	PT	-	WD	PT	-	X			Lock Weather Stripping, Existing Door		
022	H/C	1	1	3'-0"	Exist	Wd	PT	-	WD	PT	-	-	-	-	Privacy/H/C Weather Stripping, Existing Door		
023	Office	1	1	3'-0"	Exist	Wd	PT	-	WD	PT	-	-	-	-	Weather Stripping, Existing Door		
024	Office	1	1	3'-0"	Exist	Wd	PT	-	WD	PT	-	X			Lock Weather Stripping, Existing Door		
025	Foyer	1	1	3'-0"	Exist	Wd	PT	-	WD	PT	-	-	-	-	Weather Stripping, Existing Door		
026	Washroom	1	1	Exist	Exist	Wd	PT	-	WD	PT	-	-	-	-	Privacy/H/C Weather Stripping, Existing Door		
027	into Truck Bay	1	1	Exist	Exist	Wd	PT	-	WD	PT	-	-	-	-	Weather Stripping, Existing Door		
028	Hoist Tower	1	1	Exist	Exist	Wd	PT	-	WD	PT	-	-	-	-	Weather Stripping, Existing Door		
029	Storage	1	1	Exist	Exist	Wd	PT	-	WD	PT	-	-	-	-	Existing Door		
030	Kitchen	1	1	Exist	Exist	Wd	PT	-	WD	PT	-	-	-	-	Existing Door		
031	Storage	2	1	Exist	Exist	Wd	PT	-	WD	PT	-	-	-	-	Existing Doors		
032	Into Exit Foyer	2	1	3'-0"	Exist	Wd	PT	-	WD	PT	-	-	-	-	Weather Stripping, Existing Door		

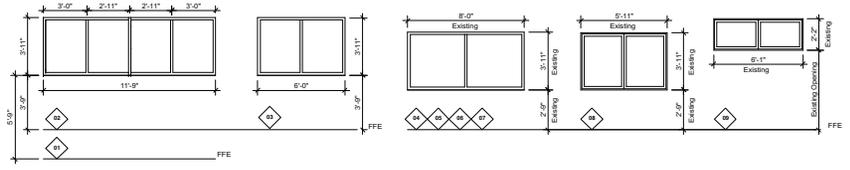

3 Windows Scale: 1/4" = 1'-0"

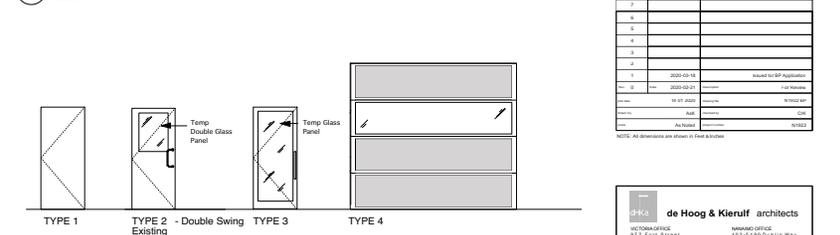


4 Doors Scale: 1/4" = 1'-0"

NO.	DATE	BY	DESCRIPTION
1	2020-03-18		Issued for BP Approval
2	2020-03-21		For Review
3	2020-03-21		For Review
4	2020-03-21		For Review
5	2020-03-21		For Review
6	2020-03-21		For Review
7	2020-03-21		For Review
8	2020-03-21		For Review
9	2020-03-21		For Review
10	2020-03-21		For Review
11	2020-03-21		For Review
12	2020-03-21		For Review
13	2020-03-21		For Review
14	2020-03-21		For Review
15	2020-03-21		For Review
16	2020-03-21		For Review
17	2020-03-21		For Review
18	2020-03-21		For Review
19	2020-03-21		For Review
20	2020-03-21		For Review
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44	2020-03-21		For Review
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48	2020-03-21		For Review
49	2020-03-21		For Review
50	2020-03-21		For Review

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Nanaimo Search & Rescue
 1911 36th Street, Nanaimo, BC
 Assemblies Code, D & W Schedule
 A501

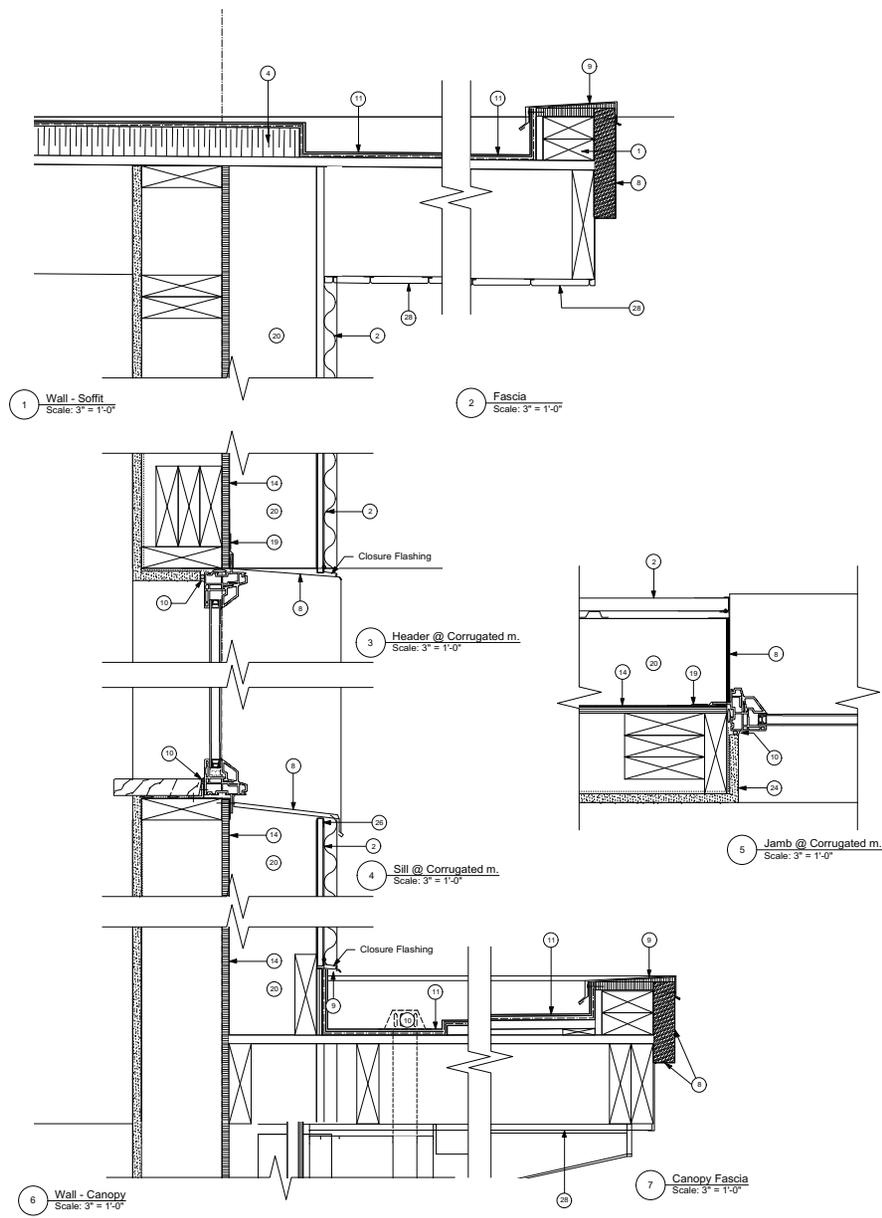

- 1 Fibre Cement Panel
- 2 Corrugated Metal Cladding
- 3 4" EPS (Back Grooved) EPS Insulation on Water / Air Barrier Coatings
- 4 Existing Rigid Roof Insulation
- 5 Batt Insulation, 6"
- 6 Batt Insulation, 8"
- 7 Batt Insulation fill cavity
- 8 Flashing
- 9 Cap Flashing
- 10 Caulk & Rod
- 11 2 Ply SBS Roofing membrane + protection Board
- 12 Plywood
- 13 Roof Drain
- 14 Tyvek moisture & air barrier
- 15 6 mil poly vapour retarder overlapping seams. (not taped)
- 16 Existing Roof Deck
- 17 Blocking
- 18 PT Furring (1x4)
- 19 SAM
- 20 EPS Insulation
- 21 Roof Drain
- 22 Scupper
- 23 Existing GWB
- 24 5/8" Type-X GWB
- 25 5/8" Exterior grade GWB
- 26 Bag Screen
- 27 Angle Profile
- 28 Longboard

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Details
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