


ATTACHMENT H LANDSCAPE PLANS AND DETAILS



THIS DRAWING IS NOT FINAL AND SHALL NOT BE USED FOR CONSTRUCTION WORK UNLESS IT HAS BEEN STAMPED AND SIGNED BY THE LANDSCAPE ARCHITECT. THE COPYRIGHT TO ALL DESIGN AND DRAWINGS ARE THE PROPERTY OF MACDONALD GRAY CONSULTANTS ARCHITECTURE INC. NO PART MAY BE REPRODUCED OR TRANSMITTED IN ANY FORM OR BY ANY MEANS WITHOUT PERMISSION IN WRITING FROM MACDONALD GRAY CONSULTANTS ARCHITECTURE INC.

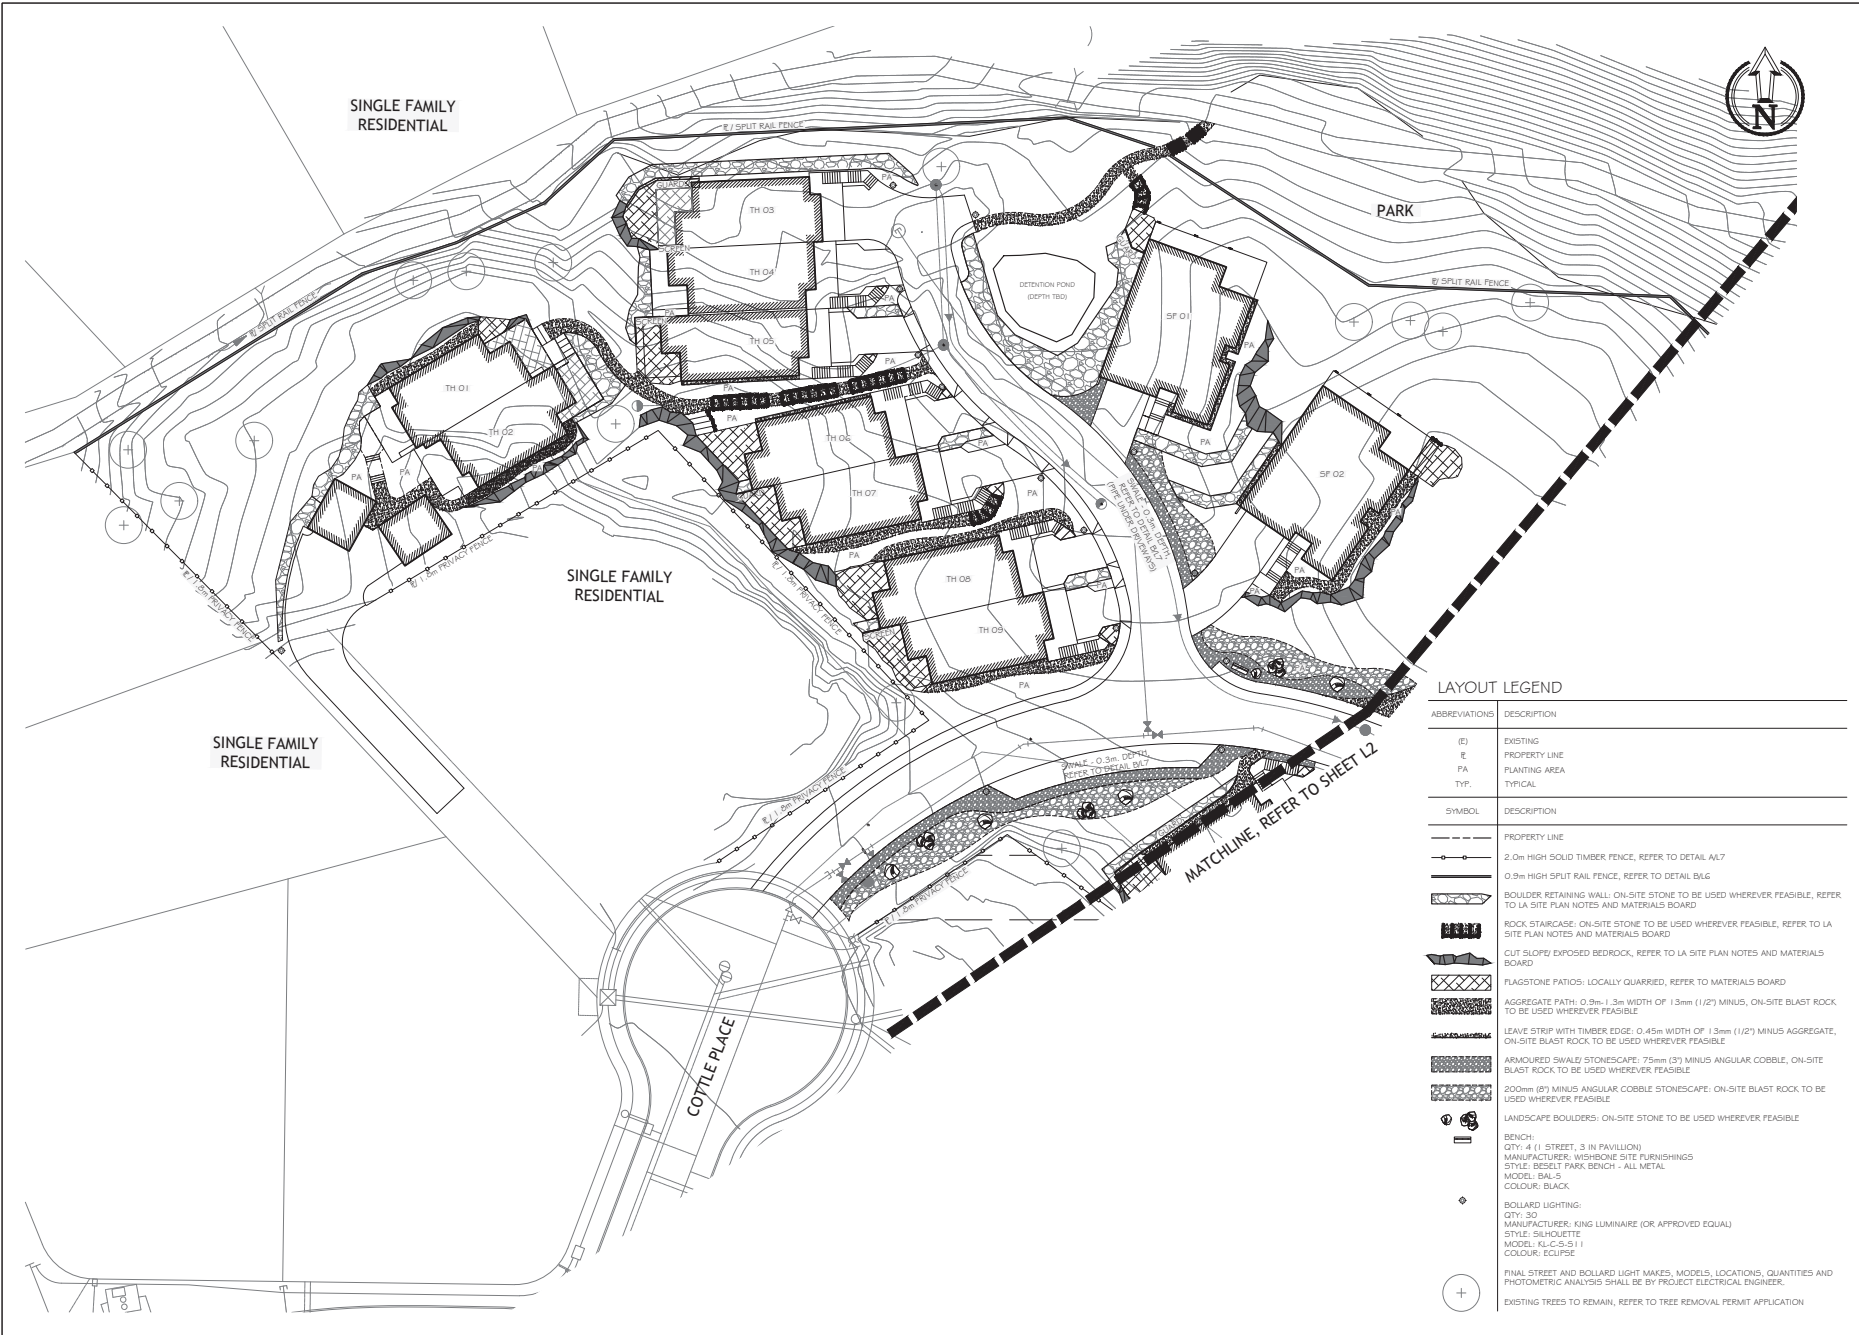

LAYOUT LEGEND

ABBREVIATIONS	DESCRIPTION
(E)	EXISTING
E	PROPERTY LINE
PA	PLANTING AREA
TYP.	TYPICAL
SYMBOL	DESCRIPTION
(---)	PROPERTY LINE
(---)	2.0m HIGH SOLID TIMBER FENCE, REFER TO DETAIL A4.7
(---)	0.9m HIGH SPLIT RAIL FENCE, REFER TO DETAIL B4.6
(---)	BOULDER RETAINING WALL: ON-SITE STONE TO BE USED WHEREVER FEASIBLE, REFER TO LA SITE PLAN NOTES AND MATERIALS BOARD
(---)	ROCK STAIRCASE: ON-SITE STONE TO BE USED WHEREVER FEASIBLE, REFER TO LA SITE PLAN NOTES AND MATERIALS BOARD
(---)	CUT SLOPE/ EXPOSED BEDROCK, REFER TO LA SITE PLAN NOTES AND MATERIALS BOARD
(---)	FLAGSTONE PATIOS: LOCALLY QUARRIED, REFER TO MATERIALS BOARD
(---)	AGGREGATE PATH: 0.9m - 1.3m WIDTH OF 1.3mm (1/2") MINUS, ON-SITE BLAST ROCK TO BE USED WHEREVER FEASIBLE
(---)	LEAVE STRIP WITH TIMBER EDGE: 0.45m WIDTH OF 1.3mm (1/2") MINUS AGGREGATE, ON-SITE BLAST ROCK TO BE USED WHEREVER FEASIBLE
(---)	ARMOURED SWALE/ STONESCAPE: 75mm (3") MINUS ANGULAR COBBLE, ON-SITE BLAST ROCK TO BE USED WHEREVER FEASIBLE
(---)	200mm (8") MINUS ANGULAR COBBLE STONESCAPE: ON-SITE BLAST ROCK TO BE USED WHEREVER FEASIBLE
(---)	LANDSCAPE BOULDERS: ON-SITE STONE TO BE USED WHEREVER FEASIBLE
(---)	BENCH: QTY: 4 (1) STREET, 3 IN PAVILLION) MANUFACTURER: WISHBONE SITE FURNISHINGS STYLE: BISSET PARK BENCH - ALL METAL MODEL: BAL-5 COLOUR: BLACK
(---)	BOLLARD LIGHTING: QTY: 30 MANUFACTURER: KING LUMINAIRE (OR APPROVED EQUAL) STYLE: SILHOUETTE MODEL: KL-C-S-511 COLOUR: ECLIPSE
(---)	FINAL STREET AND BOLLARD LIGHT MAKES, MODELS, LOCATIONS, QUANTITIES AND PHOTOMETRIC ANALYSIS SHALL BE BY PROJECT ELECTRICAL ENGINEER.
(+)	EXISTING TREES TO REMAIN, REFER TO TREE REMOVAL PERMIT APPLICATION

380 Cottle Place
Mödev
Nanaimo, BC

**LANDSCAPE ARCHITECTURE
SITE PLAN**
Date: December 7, 2017
Drawn: CW
Checked: NG
Project Number: 17-0176
Drawing Number: **L1 of 7**

#	REVISION	SCHEDULE	NOTES
0	25AUG2017	Pre-application	Review
1	26SEP2017	DP Submission	
2	07DEC2017	DP Re-submission	




THIS DRAWING IS NOT FINAL AND SHALL NOT BE USED FOR CONSTRUCTION WORK UNTIL IT HAS BEEN STAMPED AND SIGNED BY THE LANDSCAPE ARCHITECT. THE COPYRIGHT TO ALL DESIGN AND DRAWINGS ARE THE PROPERTY OF MACDONALD GRAY CONSULTANTS INC. NO PART MAY BE REPRODUCED OR TRANSMITTED IN ANY FORM OR BY ANY MEANS WITHOUT PERMISSION BY MACDONALD GRAY CONSULTANTS INC.

LANDSCAPE ARCHITECTURE SITE PLAN NOTES

- REFER TO SITE PLAN PREPARED BY HILLEL ARCHITECTURE FOR SITE PLAN LAYOUT, PROPOSED FINISHED FLOOR ELEVATIONS, INDIVIDUAL UNIT ATTACHED STAIR DESIGN, SITE GRADING AND OTHER ARCHITECTURAL INFORMATION.
- REFER TO CIVIL PLANS AND REPORT PREPARED BY NEWCASTLE ENGINEERING LTD. FOR ALL ROADWORKS AND SITE SERVICING INFORMATION.
- REFER TO TREE REMOVAL PERMIT REPORT PREPARED BY TOTH ENVIRONMENTAL SERVICES FOR TREE RETENTION AND REMOVAL INFORMATION.
- AREA OF EXPOSED BEDROCK IS APPROXIMATE BASED ON THE TOPOGRAPHICAL SURVEY AND PROPOSED FINISHED FLOOR ELEVATIONS PREPARED BY OTHERS.
- THE PRECISE HEIGHT AND DESIGN OF BOULDER RETAINING WALLS TO BE DETERMINED UPON COMPLETION OF BLASTING AND SITE EXCAVATION WORK. ALL RETAINING WALLS OVER 1.0m IN HEIGHT SHALL BE DESIGNED BY A STRUCTURAL ENGINEER.
- THE PRECISE NUMBER AND LOCATION OF ROCK STAIRCASE RISERS IS TO BE DETERMINED IN THE FIELD UPON COMPLETION OF BLASTING AND SITE EXCAVATION WORK.

IRRIGATION NOTES

- ALL NON RE-VEGETATION PLANTING AREAS SHALL BE WATERED VIA AN UNDERGROUND IRRIGATION SYSTEM. THE IRRIGATION SYSTEM SHALL BE AUTOMATICALLY CONTROLLED WITH SMART "ET" EQUIPMENT AND SHALL OPERATE WITHIN THE CITY OF NANAIMO WATER RESTRICTION SCHEDULE.
- THE IRRIGATION SYSTEM SHALL MEET OR EXCEED THE MOST CURRENT STANDARDS AND SPECIFICATIONS SET OUT BY THE IRRIGATION INDUSTRY ASSOCIATION OF BRITISH COLUMBIA (IABIC) AS REFERENCED IN THE MOST CURRENT EDITION OF THE BC LANDSCAPE STANDARD.
- IRRIGATION EMISSION DEVICES SHALL BE LOW VOLUME ROTARY NOZZLES OR MICRO DRIP EQUIPMENT.
- THE PLACEMENT AND RADIUS OF SPRINKLERS SHALL BE ADJUSTED AS REQUIRED BY FIELD CONDITIONS TO ACHIEVE FULL COVERAGE OF ALL PLANTED AREAS AND TO MINIMIZE OVER-SPRAY ONTO ADJACENT HARD SURFACES, FENCES AND PROPERTY LINES.
- ALL PIPING UNDER PAVING SHALL BE INSTALLED IN SEPARATE SCHEDULE. 40 SLEEVES AT A MINIMUM DEPTH OF 600mm WITH 150mm OF SAND BACKFILL ABOVE AND BELOW PIPE. ALL WIRING UNDER PAVING SHALL BE INSTALLED IN SEPARATE SCHEDULE. 40 PVC CONDUIT. ALL SLEEVES AND CONDUIT SHALL BE INSTALLED PRIOR TO PAVEMENT INSTALLATION AND SHALL EXTEND 150mm BEYOND EDGE OF PAVEMENT OR CURB. BACKFILL FOR SLEEVES SHALL BE COMPACTED TO THE SPECIFIED DENSITY FOR THE SUBGRADE.
- ESTABLISHMENT WATERING SHALL MEET OR EXCEED THE LATEST EDITION OF THE BC LANDSCAPE STANDARD (BC SOCIETY OF LANDSCAPE ARCHITECTS/ BC LANDSCAPE AND NURSERY ASSOCIATION).

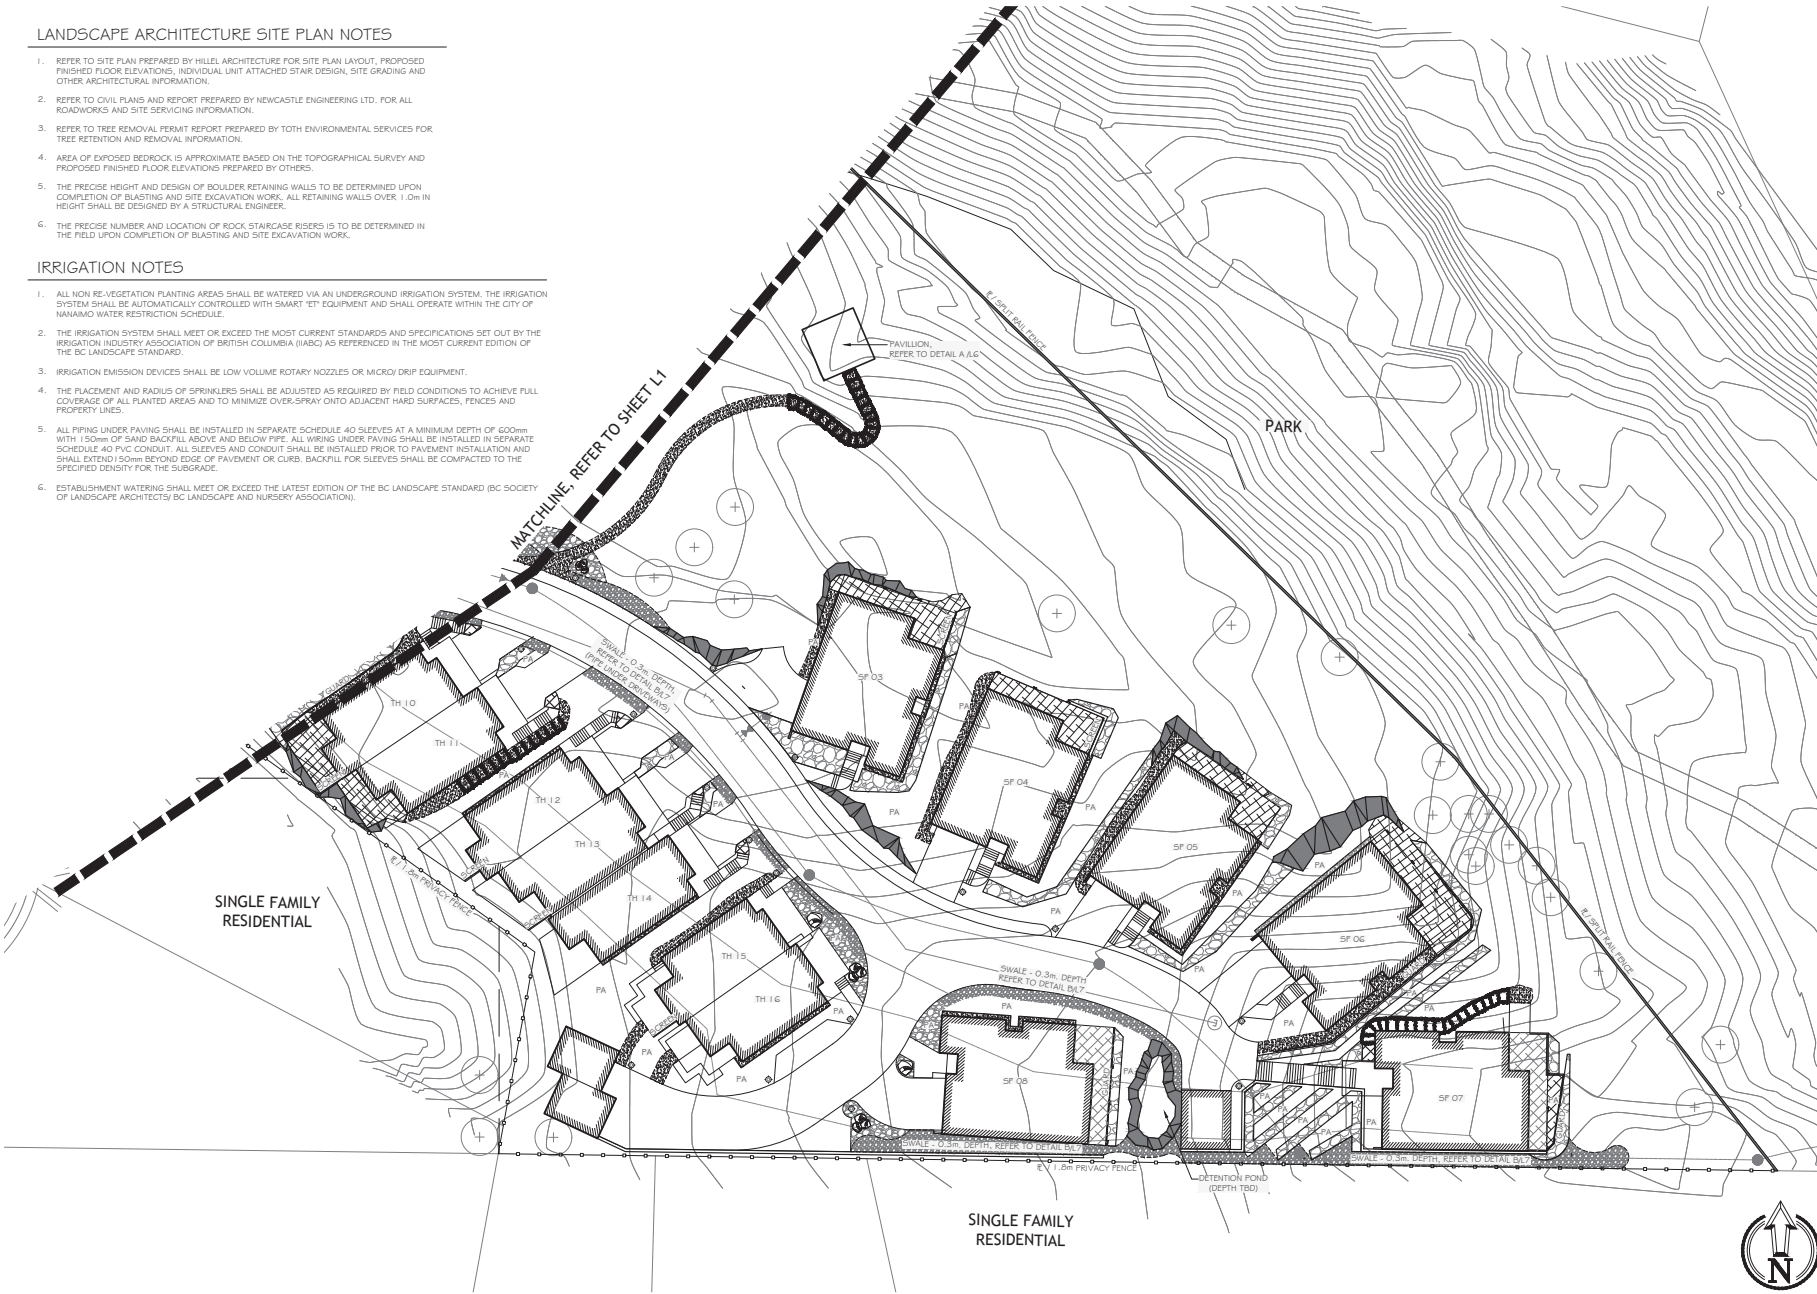

380 Cottle Place
Mödev
Nanaimo, BC

LANDSCAPE ARCHITECTURE SITE PLAN	
Date:	December 7, 2017
Drawn:	CW
Checked:	NG
Scale:	1:250 metric
Project Number:	17-0176
DRAWING NUMBER:	L2 of 7

#	REVISION	SCHEDULE	NOTES
0	25AUG2017	Pre-application	Review
1	26SEP2017	DP Submission	
2	07DEC2017	DP Re-submission	



RECEIVED
DP 1182
2020-APR-02
Current Planning



THIS DRAWING IS NOT FINAL AND SHALL NOT BE USED FOR CONSTRUCTION WORK UNTIL IT HAS BEEN STAMPED AND SIGNED BY THE LANDSCAPE ARCHITECT. THE COPYRIGHT TO ALL DESIGN AND DRAWINGS ARE THE PROPERTY OF AND RESERVED TO LANDSCAPE ARCHITECTURE INC. NO RE-PURPOSE OTHER THAN THAT AUTHORIZED BY MACDONALD GRAY LANDSCAPE ARCHITECTS.

380 Cottle Place
 Mōdev
 Nanaimo, BC

PLANTING PLAN	
Date:	December 7, 2017
Drawn:	CW
Checked:	NG
Scale:	1:250 metric
Project Number:	17-0176
DRAWING NUMBER:	L3 of 7

#	DATE	NOTES
0	25AUG2017	Pre-application Review
1	26SEPT2017	DP Submission
2	07DEC2017	DP Re-submission

RECEIVED
DP1182
 2020-APR-02
 Current Planning

PLANTING PLAN - EAST



THIS DRAWING IS NOT FINAL AND SHALL NOT BE USED FOR CONSTRUCTION WORK UNTIL IT HAS BEEN SIGNED AND SEALED BY THE LANDSCAPE ARCHITECT. THE COPYRIGHT TO ALL DESIGN AND DRAWINGS ARE THE PROPERTY OF MACDONALD GRAY LANDSCAPE ARCHITECTS INC. FOR ANY PURPOSE OTHER THAN THAT AUTHORIZED BY MACDONALD GRAY LANDSCAPE ARCHITECTS INC.



380 Cottle Place
 Mōdev
 Nanaimo, BC

PLANTING PLAN	
Date:	December 7, 2017
Drawn:	CW
Checked:	NG
Scale:	1:250 metric
Project Number:	17-0776
DRAWING NUMBER:	L4 of 7

#	REVISION SCHEDULE	NOTES
0	25AUG2017	Pre-application Review
1	26SEP2017	DP Submission
2	07DEC2017	DP Re-submission



RECEIVED
 DP1182
 2020-APR-02
 Current Planning


LANDSCAPING DETAILS



Typical Single Family Landscape

1:100 metric

Plan

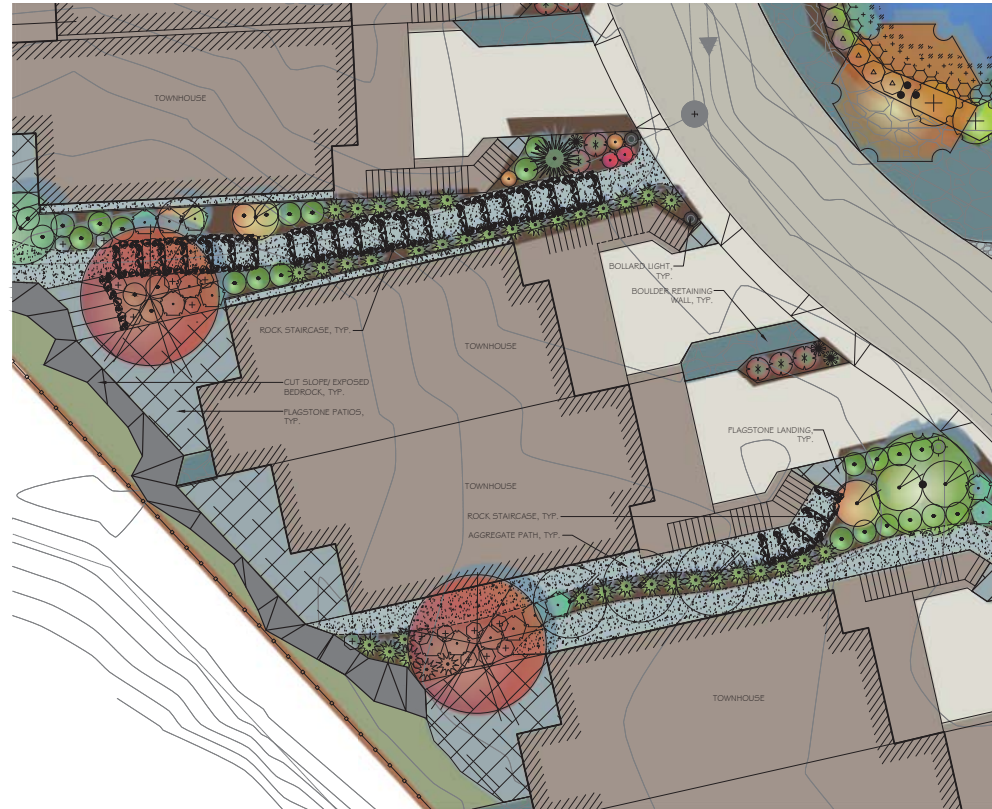

Typical Duplex/ Triplex Landscape

1:100 metric

Plan

PLANTING NOTES

1. ALL LANDSCAPE INSTALLATION AND MAINTENANCE SHALL MEET OR EXCEED THE MOST RECENT STANDARDS SET OUT BY THE BRITISH COLUMBIA NURSERY TRADES ASSOCIATION (BCNTA) / BRITISH COLUMBIA SOCIETY OF LANDSCAPE ARCHITECTS (BCSLA) BC LANDSCAPE STANDARD.
2. ALL TREES SHALL BE PLANTED WITH 300mm OF TOPSOIL OR AMENDED ORGANIC SOILS AROUND AND BELOW ROOTBALL.
3. SOIL DEPTHS: SHRUBS - 300mm
LAWN - 100mm
TREES - 300mm AROUND AND BELOW ROOTBALL.
4. MULCH SHALL BE COMPOST PER SECTION 10 MULCHING OF THE BCNTA/BCSLA BC LANDSCAPE STANDARD. MULCH DEPTH SHALL BE 75mm MINIMUM OVER ALL TREE AND SHRUB PLANTING AREAS.
5. PLANT MATERIAL QUALITY, TRANSPORT AND HANDLING SHALL COMPLY WITH BCNTA/BCSLA STANDARDS FOR NURSERY STOCK.
6. ALL PLANTING AREAS SHALL BE WATERED VIA AN UNDERGROUND AUTOMATIC IRRIGATION SYSTEM. IRRIGATION EMISSION DEVICES SHALL BE LOW VOLUME ROTARY NOZZLES OR MICRO/DRIP EQUIPMENT.
7. PLANT QUANTITIES ARE FOR INFORMATION ONLY. IN CASE OF ANY DISCREPANCY THE PLAN SHALL GOVERN.
8. ALL PLANT MATERIAL SHALL MATCH SPECIES AS INDICATED ON THE PLANTING LEGEND.
9. CONTACT THE LANDSCAPE ARCHITECT FOR APPROVAL OF ANY SUBSTITUTIONS. NO SUBSTITUTIONS WILL BE ACCEPTED WITHOUT PRIOR WRITTEN APPROVAL OF THE LANDSCAPE ARCHITECT.
10. CHECK FOR LOCATIONS OF WATER LINES AND OTHER UNDERGROUND SERVICES PRIOR TO DIGGING TREE PITS. EXCAVATED PLANT PITS SHALL HAVE POSITIVE DRAINAGE. PLANT PITS WHEN FULLY FLOODED WITH WATER SHALL DRAIN WITHIN ONE HOUR AFTER FILLING.
11. NO PLANTS REQUIRING PRUNING OF MAJOR BRANCHES DUE TO DISEASE, DAMAGE OR POOR FORM WILL BE ACCEPTED.
12. ALL CALIPRE-STOCK TREES SHALL BE B & B IN WIRE BASKETS.



THIS DRAWING IS NOT FINAL AND SHALL NOT BE USED FOR CONSTRUCTION WORK UNTIL IT HAS BEEN STAMPED AND SIGNED BY THE LANDSCAPE ARCHITECT. THE COPYRIGHT TO ALL DESIGN AND DRAWINGS ARE THE PROPERTY OF MACDONALD GRAY. CONSULT YOUR CONTRACTOR FOR ANY PURPOSE OTHER THAN THAT AUTHORIZED BY MACDONALD GRAY. CONSULTANTS TO BE ADVISED.

380 Cottle Place
Mōdev
 Nanaimo, BC

TYPICAL UNIT LANDSCAPE	
Date:	December 7, 2017
Drawn:	CW
Checked:	NG
Scale:	1:100 metric
Project Number:	17-0776
DRAWING NUMBER:	L5 of 7

REVISION SCHEDULE	
#	NOTES
0	25AUG2017 Pre-application Review
1	26SEP2017 DP Submission
2	07DEC2017 DP Re-submission

RECEIVED
DP1182
2020-APR-02
 Current Planning

PLANT LEGEND



SYMBOL	BOTANICAL / COMMON NAME	SIZE	SPACING	QUANTITY	NOTES
TREES					
		1.5m BUFFER			
	ACER CIRCINATUM VINE MAPLE	#5 POT	SEE PLAN	28	NATIVE SPECIES
	CERCIS CANADENSIS 'FOREST PANSY' FOREST PANSY EASTERN REDBUD	5cm CAL.	SEE PLAN	6	NATIVE CULTIVAR, STREET TREE
	CHAMAECYPARIS 'MOOKATENSIS' 'JUBILEE' JUBILEE WEeping ALASKAN CEDAR	2.0m HEIGHT	SEE PLAN	5	NATIVE CULTIVAR
	CORNUS KOUSA 'SATOMI' RED FLOWERING KOUSA DOGWOOD	5cm CAL.	SEE PLAN	8	SPECIMEN TREE
	MALUS FUSCA PACIFIC CRAB APPLE	#5 POT	SEE PLAN	3	NATIVE SPECIES
	PICEA ABIES CUPRESSINA COLUMBIAN NORWAY SPRUCE	2.0m HEIGHT	SEE PLAN	8	DROUGHT TOLERANT
	PYRUS CALLERYANA 'CHANTICLEER' REDSPIRE FLOWERING PEAR	5cm CAL.	SEE PLAN	8	STREET TREE

SYMBOL	BOTANICAL / COMMON NAME	SIZE	SPACING	QUANTITY	NOTES
SHRUBS					
	AMELANCHIER ALNIFOLIA SASKATOON	#5 POT	2.0m O.C.	25	NATIVE SPECIES
	GALUTHERIA SHALLON SALLAL	#1 POT	1.0m O.C.	203	NATIVE SPECIES
	HOLIDISCUS DISCOLOR OCEANSPRAY	#2 POT	1.5m O.C.	6	NATIVE SPECIES
	MAHONIA AQUIFOLIUM OREGON GRAPE	#2 POT	1.0m O.C.	124	NATIVE SPECIES
	POLYSTICHUM MUNITUM SWORDFERN	#1 POT	1.0m O.C.	197	NATIVE SPECIES
	ROSA GYMNOCARPA BALDHP ROSE	#2 POT	1.0m O.C.	120	NATIVE SPECIES
	SALIX SCOLLERIANA SCOLLER'S WILLOW	#1 POT	2.0m O.C.	10	NATIVE SPECIES
	SAMBUCUS RACEMOSA RED ELDERBERRY	#5 POT	1.5m O.C.	43	NATIVE SPECIES
	SPIRAEA DOUGLASHI HARDHACK	#1 POT	1.0m O.C.	24	NATIVE SPECIES

SYMBOL	BOTANICAL / COMMON NAME	SIZE	SPACING	QUANTITY	NOTES
PERENNIALS & GROUNDCOVERS					
	ACHILLEA MILLEFOLIUM YARROW	#1 POT	0.6m O.C.	86	NATIVE CULTIVAR: 30% YELLOW, 30% RED AND 30% ORANGE
	ARCTOSTAPHYLOS LVA-URSI KINKIKNICK	#1 POT	1.0m O.C.	290	NATIVE SPECIES, PLANT OVER TOP OF WALLS TO CASCADE
	CAREX OBNUPTA STIPTA SLOUGH / SAWBEAK SEDGE	#1 POT	0.5m O.C.	48	NATIVE SPECIES
	DIGITALIS PURPUREA COMMON FOXGLOVE	#1 POT	1.0m O.C.	27	NATIVE SPECIES
	JUNCUS EFFUSUS COMMON RUSH	#1 POT	0.5m O.C.	42	NATIVE SPECIES
	PENNISETUM ALOPECUROIDES 'HAMEL' DWARF FOUNTAIN GRASS	#1 POT	0.6 m O.C.	125	DROUGHT TOLERANT
	SCIRPUS MICROCARPUS SMALL FLOWERED BULRUSH	#1 POT	0.5m O.C.	60	NATIVE SPECIES
	LAWN	SOD		110 sq. m.	

SYMBOL	BOTANICAL / COMMON NAME	SIZE	SPACING	QUANTITY	NOTES
NATIVE SPECIES RE-VEGETATION MIXES (STEEP SLOPES, DISTURBED ROCK OUTCROPS & ROCK WALLS)					
	NORTH 4 EAST FACING DIGITALIS PURPUREA COMMON FOXGLOVE	9cm POT	TBD	25	WHERE THE SUBGRADE DOES NOT ALLOW FOR SOIL VOLUMES AND SPACING INDICATED IN THE PLANT LEGEND AND PLANTING NOTES (IE: DISTURBED ROCK OUTCROPS, ROCK WALLS AND CUT SLOPES): 1. PLANTS SHALL BE INSTALLED IN CRACKS, HOLES AND GAPS FILLED WITH IMPORTED GROWING MEDIUM WHERE FEASIBLE. 2. IRRIGATION WILL NOT BE REQUIRED IN THESE AREAS. 3. QUANTITIES ARE BASED ON 25% SUITABLE PLANTING AREAS AT 1.0m SPACING
	GALUTHERIA SHALLON SALLAL	9cm POT	TBD	25	
	LONICERA CLIOSA WESTERN TRUMPET HONEYSUCKLE	#1 POT	TBD	25	
	MAHONIA NERVOSA LONGLEAF OREGON GRAPE	#1 POT	TBD	25	
	MIMULUS GUTTATUS YELLOW MONKEY-FLOWER	#1 POT	TBD	25	
	POLYSTICHUM MUNITUM SWORDFERN	#1 POT	TBD	25	
	SOUTH 4 WEST FACING ACHILLEA MILLEFOLIUM YARROW	9cm POT	TBD	15	
	BRODIAEA HYACINTHINA FOOL'S ONION	10cm POT	TBD	15	
	HOLIDISCUS DISCOLOR OCEANSPRAY	#1 POT	TBD	15	
	LONICERA HISPIDULA HAIRY HONEYSUCKLE	#1 POT	TBD	15	
	MAHONIA AQUIFOLIUM OREGON GRAPE	#1 POT	TBD	15	
	MONTIA PARVIFOLIA SMALL-LEAVED MONTIA	9cm POT	TBD	15	
	ROSA GYMNOCARPA BALDHP ROSE	#1 POT	TBD	15	
	SEDUM SPATHULIFOLIUM BROAD-LEAVED STONECROP	9cm POT	TBD	15	
	LOWER (SOUTHERN) POND CAREX OBNUPTA STIPTA SLOUGH / SAWBEAK SEDGE	#1 POT	TBD	1	
	JUNCUS EFFUSUS COMMON RUSH	#1 POT	TBD	1	
	MIMULUS GUTTATUS YELLOW MONKEY-FLOWER	#1 POT	TBD	1	
	SALIX SCOLLERIANA SCOLLER'S WILLOW	#1 POT	TBD	1	
	SCIRPUS MICROCARPUS SMALL FLOWERED BULRUSH	#1 POT	TBD	1	
	SPIRAEA DOUGLASHI HARDHACK	#1 POT	TBD	1	

SYMBOL	DESCRIPTION	SIZE	SPACING	QUANTITY	NOTES
	CAREX OBNUPTA STIPTA SLOUGH / SAWBEAK SEDGE	#1 POT	0.5m O.C.	95	CENTRELINE OF SWALE
	JUNCUS EFFUSUS COMMON RUSH	#1 POT	0.5m O.C.	190	SIDE SLOPES OF SWALE
	SCIRPUS MICROCARPUS SMALL FLOWERED BULRUSH	#1 POT	0.5m O.C.	190	BOTTOM CORNERS OF SWALE
	EXISTING TREE RETENTION, PLANTING, SLOPES AND ROCK OUTCROPS TO REMAIN			4,885m ²	

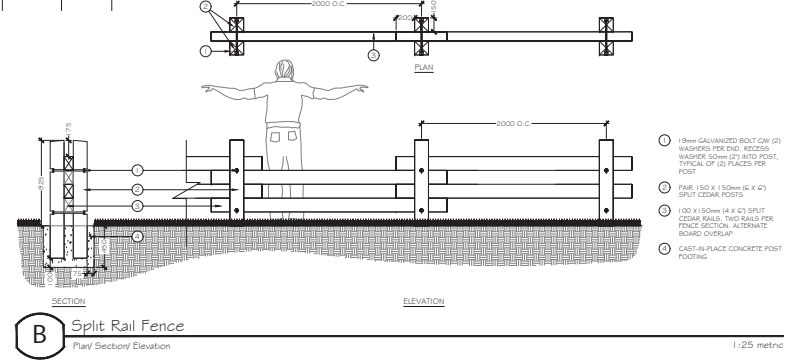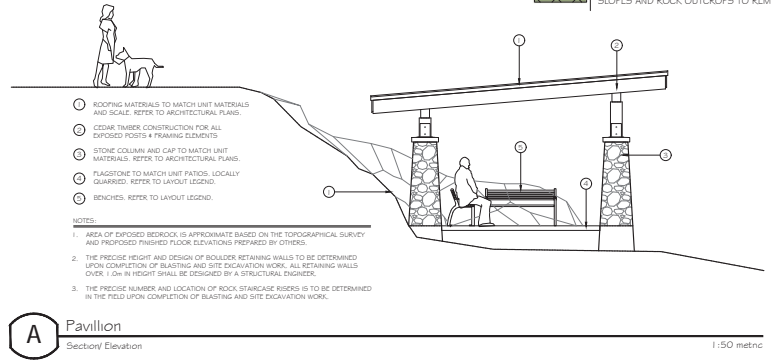

THIS DRAWING IS NOT FINAL AND SHALL NOT BE USED FOR CONSTRUCTION WORK UNLESS IT HAS BEEN SIGNED AND SEALED BY THE LANDSCAPE ARCHITECT. THE COPYRIGHT TO ALL DESIGN AND DRAWINGS ARE THE PROPERTY OF MACDONALD GRAY LANDSCAPE ARCHITECTURE INC. NO REPRODUCTION OR OTHER USES ARE PERMITTED WITHOUT THE WRITTEN CONSENT OF THE ARCHITECT.


380 Cottle Place
Mödev
Nanaimo, BC

PLANTING LEGEND & DETAILS


Date: December 7, 2017
Drawn: CM
Checked: NG
Scale: AS NOTED
Project Number: 13-0736
DRAWING NUMBER: L6 of 7

#	DATE	NOTES
0	25/AUG/2017	Pre-application Review
1	26/SEP/2017	DP Submission
2	07/OCT/2017	DP Re-submission

RECEIVED
DP1182
2020-APR-02
Current Planning

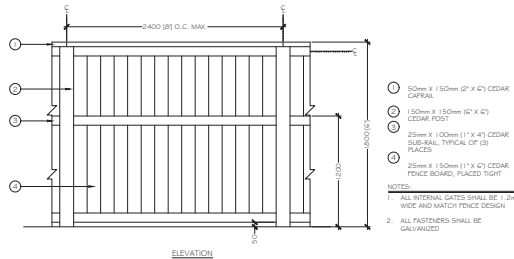

A 1.8m Privacy Fence
Section/Elevation 1:25 metric

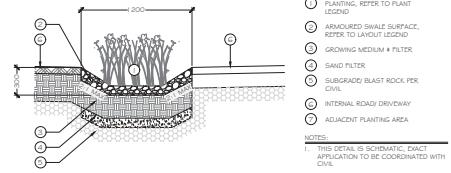

B Armoured Swale
Section 1:25 metric



Flagstone Patios
Photo



Flagstone Patios
Photo



Boulder Retaining Wall
Photo



Rock Staircase
Photo



Home in Rock Outcrop
Photo



Home on Rock Outcrop
Photo



Exposed Rock Outcrop
Photo



Re-vegetated Rock Outcrop
Photo



Armoured Swale
Photo



Armoured Swale
Photo



THIS DRAWING IS NOT FINAL AND SHALL NOT BE USED FOR CONSTRUCTION UNLESS IT HAS BEEN STAMPED AND SIGNED BY THE LANDSCAPE ARCHITECT. THE COPYRIGHT TO ALL DESIGN AND DRAWINGS ARE THE PROPERTY OF MACDONALD GRAY LANDSCAPE ARCHITECTS INC. NO PART MAY BE REPRODUCED OR TRANSMITTED IN ANY FORM OR BY ANY MEANS WITHOUT PERMISSION IN WRITING FROM MACDONALD GRAY LANDSCAPE ARCHITECTS INC.

380 Cottle Place
Mödev
Nanaimo, BC

DETAILS & MATERIALS	
Date:	December 7, 2017
Drawn:	CW
Checked:	NG
Scale:	1:250 metric
Project Number:	17-0776
DRAWING NUMBER:	L7 of 7

REVISION SCHEDULE		
#	DATE	NOTES
0	25AUG2017	Pre-application Review
1	26SEP2017	DP Submission
2	07DEC2017	DP Re-submission

RECEIVED
DP1182
2020-APR-02
Current Planning