

ATTACHMENT D BUILDING ELEVATIONS

Elevation - General Notes

1. ALL ALUMINUM SOFFIT, EAVES & RAINWATER LEADERS TO BE DARK GREY
2. ALL PRE-FINISHED METAL FLASHING TO MATCH ADJACENT FINISH


Elevation - Code Legend

- | | |
|----|--|
| 1 | CLEAR VISION GLASS |
| 2 | TINTED GLASS |
| 3 | SPANDREL PANELS |
| 4 | WHITE FIBRE CEMENT PANEL CLADDING, PANEL SIZES TO BE CONFIRMED |
| 5 | DARK GREY FIBRE CEMENT PANEL CLADDING, PANEL SIZES TO BE CONFIRMED |
| 6 | BRASS CANOPY FASCIA |
| 7 | RED PHENOLIC PANEL CLADDING, PANEL SIZES TO BE CONFIRMED |
| 8 | PAINTED METAL DOORS, DARK GREY ACCENT PAINT |
| 9 | ANNING WINDOW c/w TINTED GLASS |
| 10 | WHITE FIBRE CEMENT PANEL CLADDING MECHANICAL ROOF SCREEN SYSTEM |
| 11 | 1070 HIGH STEEL ROOF TERRACE GUARDRAIL, PAINTED DARK GREY |
| 12 | GLASS DOORS IN ALUMINUM FRAME |
| 13 | PRE-FINISHED GLAZED OVERHEAD DOOR |
| 14 | PRE-FINISHED BI-FOLD DOORS |
| 15 | NEW COMMUNICATION TOWER, 10m HIGH |
| 16 | BLACK ALUMINUM WINDOW FRAMING SYSTEM |
| 17 | RED ALUMINUM ACCENT WINDOW FRAME BOX |
| 18 | INSULATED ALUMINUM DOOR |
| 19 | OPERABLE CASEMENT WINDOW IN CURTAIN WALL |
| 20 | BUILDING SIGNAGE |
| 21 | GAS METER CHAINLINK ENCLOSURE |
| 22 | EXTERIOR STAIR c/w GUARD & HAND RAILS, PAINTED DARK GREY |
| 23 | PREFINISHED LOUVER, COLOUR TO MATCH ADJACENT EXTERIOR FINISH |
| 24 | ROOF LADDER, PAINTED TO MATCH ADJACENT EXTERIOR FINISH |



BUILDING ELEVATIONS
Nanaimo Fire Station #1 Replacement
 618 & 666 FITZWILLIAM STREET, NANAIMO, BRITISH COLUMBIA
 City of Nanaimo
 2/18/20

Proposed Building Height Variance

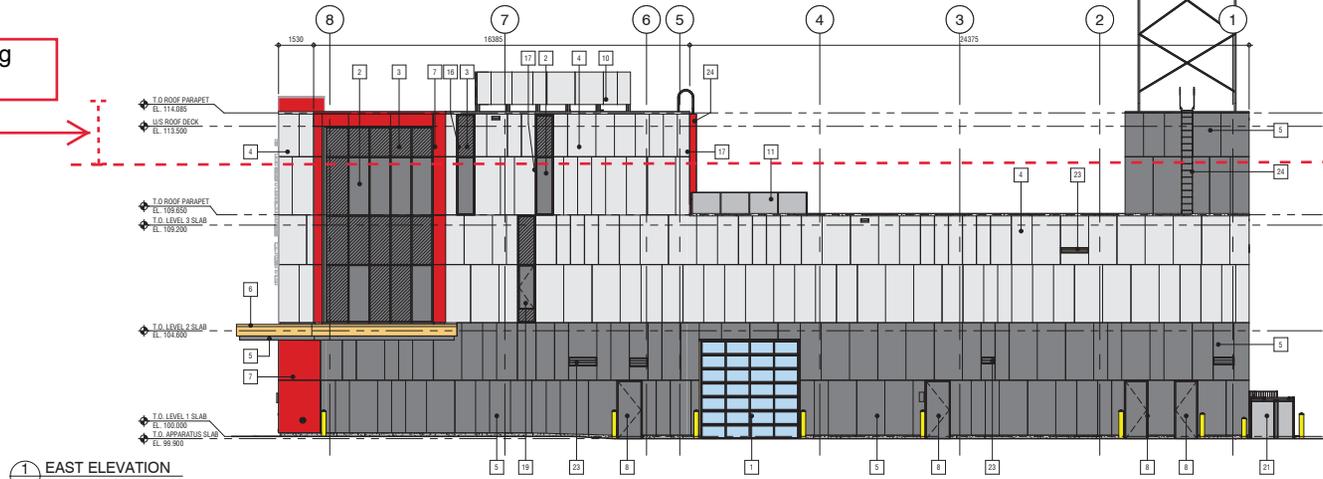

1 EAST ELEVATION
 DP3.07 SCALE: 1:100
 DPI.02

Proposed Building Height Variance



2 WEST ELEVATION
 DP3.07 SCALE: 1:100
 DPI.02

NOT FOR CONSTRUCTION

This drawing supersedes previous issues. Do not scale these drawings.
 Verify all dimensions, elevations and details, and report any discrepancies to the Architect prior to construction. Dimensions are taken to face of exterior cladding, face of concrete block, face of steel for stone partitions, and extrusion of masonry walls, unless noted otherwise on the drawing.
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REVISION	DATE
1	DEVELOPMENT PERMIT 16.08.2019
2	D.P. REVISION 14.01.2020

SCALE: As indicated
 DATE: 1/15/2020 7:51:47 AM
 DRAWN BY: GJO, MRL, MPT
 CHECKED BY: GJO


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 2020-JAN-17
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DRAWING NO. **DP3.01**

Proposed Building Height Variance




1 SOUTH ELEVATION
SCALE: 1 : 100
DPI1.02

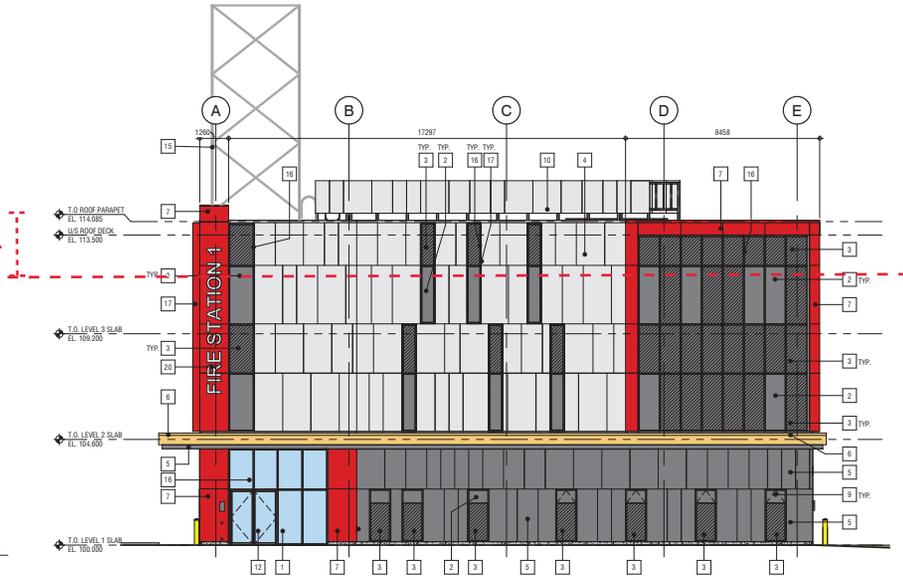

Proposed Building Height Variance



2 NORTH ELEVATION
SCALE: 1 : 100
DPI1.02

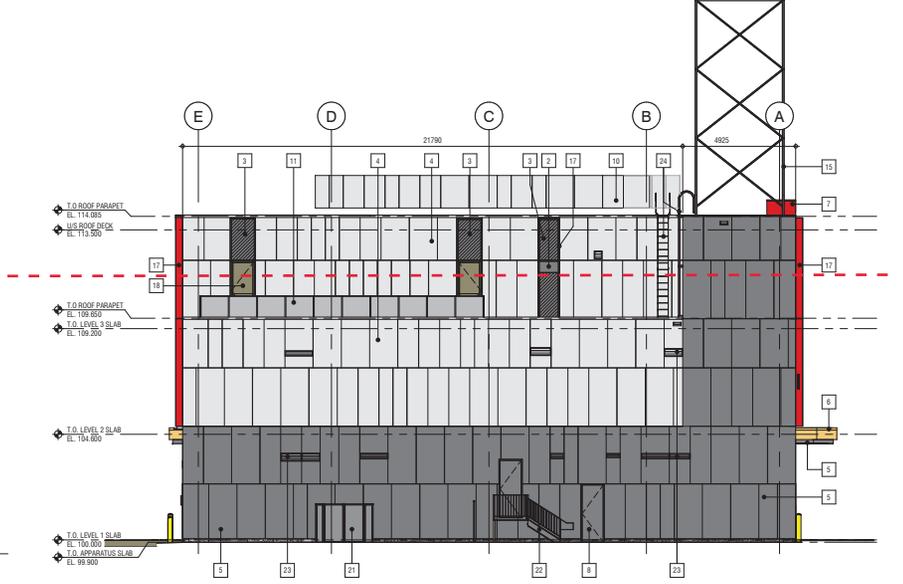

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- 7 RED PHENOLIC PANEL CLADDING, PANEL SIZES TO BE CONFIRMED
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- 24 ROOF LADDER, PAINTED TO MATCH ADJACENT EXTERIOR FINISH



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618 & 666 FITZWILLIAM STREET, NANAIMO, BRITISH COLUMBIA
City of Nanaimo

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REVISION	DATE
1 DEVELOPMENT PERMIT	16.08.2019
2 D.P. REVISION	14.01.2020

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DATE 1/15/2020 7:51:44 AM
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CHECKED BY G.J.O.

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CITY OF NANAIMO

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