

### AGENDA DESIGN ADVISORY PANEL MEETING

February 28, 2019, 5:00 PM
Board Room, Service and Resource Centre,
411 Dunsmuir Street, Nanaimo, BC

**Pages** 

- 1. CALL THE MEETING OF THE DESIGN ADVISORY PANEL TO ORDER:
- 2. ADOPTION OF AGENDA:
- 3. ADOPTION OF MINUTES:

a. Minutes 3 - 5

Minutes of the Open Design Advisory Panel meeting held in the Boardroom of the Service and Resource Centre, 411 Dunsmuir Street, Nanaimo BC on Thursday February 14, 2019.

#### 4. PRESENTATIONS:

a. Development Permit Application No. DP1129 - 4750 Rutherford Road

6 - 18

A development permit application was received from Shape Properties (Nanaimo) Corp., on behalf of 1854 Holdings Ltd., for the exterior redevelopment of a commercial rental unit (Unit 143) located within the Nanaimo North Town Centre Mall. The subject property is legally described as Lot A of Section 14 and District Lots 14 and 17 and Section 4, Range 4, Wellington District, Plan VIP66202.

b. Development Permit Application No. DP1126 – 560 Third Street

19 - 58

A development permit application was received from Wensley Architecture Ltd., on behalf of Third Street Nanaimo Holdings Ltd., for the development of a student housing complex comprised of two four-storey buildings (181 residential units and one commercial rental unit) to be located at 560 Third Street. The subject property is legally described as Section 33, Range 6, Section 1, Nanaimo District, Plan 630 except Part in Plan EPP32701.

#### 59 - 81

#### c. Development Permit Application No. DP1128 – 576/580 Rosehill Street

A development permit application was received from Raymond de Beeld Architect Inc., on behalf of Anayk Home Builders Ltd., for the development of a 13 unit multi-family building to replace two small residential dwellings located at 576/580 Rosehill Street. Lot consolidation is also underway. The subject properties are legally described as Lots 7 and 8, Suburban lot 32, Newcastle Townsite, Section 1, Nanaimo District, Plan 1505.

#### 5. ADJOURNMENT:

#### **MINUTES**

#### OPEN DESIGN ADVISORY PANEL MEETING SERVICE AND RESOURCE CENTRE BOARDROOM, 411 DUNSMUIR STREET, NANAIMO, BC THURSDAY, 2019-FEB-14, AT 5:00 P.M.

PRESENT: Members: Gur Minhas, Chair

Daniel Appell Kevin Krastel Charles Kierulf Will Melville

Absent: Frank Basciano

Martin Hagarty

Staff: Lainya Rowett, Manager, Current Planning

Dave Stewart, Planner, Current Planning Laurie Nielsen, Recording Secretary

#### 1. CALL THE OPEN DESIGN ADVISOR PANEL MEETING TO ORDER:

The Open Design Advisory Panel Meeting was called to order at 4:57 p.m.

#### 2. ADOPTION OF AGENDA:

It was moved and seconded that the Agenda, be adopted. The motion carried unanimously.

#### 3. <u>ADOPTION OF MINUTES:</u>

It was moved and seconded that the Minutes of the Regular Meeting of the Design Advisory Panel held in the Boardroom, 411 Dunsmuir Street, Nanaimo, BC, on Thursday, 2018-DEC-13 at 5:00 p.m. be adopted as circulated. The motion carried unanimously.

It was moved and seconded that the Minutes of the Regular Meeting of the Design Advisory Panel held in the Boardroom, 411 Dunsmuir Street, Nanaimo, BC, on Thursday, 2019-JAN-10 at 5:00 p.m. be adopted as circulated. The motion carried unanimously.

#### 4. PRESENTATIONS:

#### (a) <u>Development Permit Application No. DP1127 - 337 Robson Street</u>

Dave Stewart, Planner, Current Planning Section, introduced the project, a five-storey, multi-family residential building with 31 studio rental units. Mr. Stewart spoke regarding: modular construction form being the first of its kind in Nanaimo, site context, zoning, Schedule D amenity requirements, and the possible need for an encroachment agreement. Staff supports the proposed height variance. Historically, a development permit application of similar design was approved by Council in December of 2010.

Ivica Marinic, Architect of Omicron Architecture Engineering Construction Ltd., presented the project, accompanied by Mehdi Kamali, Construction Technologist of Meridian Group of Companies. Mr. Marinic spoke regarding site context; building design (modular building technology, construction methods, and product quality), floor plans, and, provided an overview regarding various landscape features. Mr. Marinic noted the following points:

- Pedestrian and vehicle access is from Robson Street.
- The building is a modular design which allows increased construction speed, as well as quality and consistency of build. Steel construction.
   Affordable for the market. Limited maintenance.
- Hallways, stairwells, elevators each module/two units across the hallways.
- Pipes and wiring run down the internal hallways.
- The fifth level has a complete setback on the southwest side that allows a patio for use by all building residents.
- The green roof includes solar panels and landscaping.
- Exterior building materials include: metal panels of different finishes and profiles.
- The only wood element is a trellis that will require some maintenance.
- An art piece is proposed for the south facade.
- Bicycle storage is proposed for the parking garage.

#### Panel discussions took place regarding:

- The possibility of leveling out the parking area.
- The possibility of re-orienting perhaps reversing the building plan/layout in order to step the building back from the street.
- The possible relocation (lowering) of the public art piece to ensure a more human scale.
- Directional traffic from Franklyn Street and possibly relocating the building entrance to the south side of the front façade.
- Appreciation was conveyed for providing wheelchair accessibility.
- The angular design of the entrance way roofline out of place for the rest of the building.
- It was also suggested the applicant have a representative at the Council meeting in order to provide any clarification regarding this project.
- It was recommended that communication with BC Hydro happen sooner than later to determine the location of the hydro service box.

It was moved and seconded that Development Permit Application No. DP1127 – 337 Robson Street be accepted as presented with support for the proposed building height variance. The following recommendations were provided:

- Look at flattening out the entrance roof to better match the character of the rest of the building.
- If the public art remains on the south side of the building, consider lowering it to a more human scale.

The motion carried unanimously.

MINUTES – DESIGN ADVISORY PANEL 2019-FEB-14 PAGE 3

#### 5. OTHER BUSINESS

(a) Member Term Completions

Lainya Rowett, Manager, Current Planning provided a brief overview of the process currently underway advertising for panel members, and invited the atlarge members to submit their applications to Legislative Services for Council consideration.

#### 6. <u>ADJOURNMENT:</u>

It was moved and seconded at 5:55 p.m. that the meeting terminate. The motion carried unanimously.

CHAIR			
CERTIFIED CORRECT:			
CORPORATE OFFICER			

#### STAFF DESIGN COMMENT

#### DEVELOPMENT PERMIT NO. DP001129 - 4750 RUTHERFORD ROAD, UNIT 143

Applicant Architect: MUSSON CATTELL MACKAY PARTNERSHIP

Owner: 1854 HOLDINGS LTD

Landscape Architect: PMG LANDSCAPE ARCHITECTS LTD

#### Subject Property:

Zoning	CC3 – City Commercial Centre
Location  The proposed development is located within Nanaimo Northtov Centre, on the northeast side of the mall facing Uplands Drive.	
Total Area	Subject property size: 24.7 ha
Official Community Plan (OCP)	Map 1 – Future Land Use Plans – City Commercial Centre; Map 3 – Development Permit Areas – DPA No. 9 – Commercial, Industrial, Institutional, Multi-family and Mixed Commercial / Residential Development
Relevant Design Guidelines	General Development Permit Area Design Guidelines

#### Site Context

The proposed development is located on the exterior of a vacant unit in the southeast quadrant of the existing commercial development, Nanaimo North Town Centre (NNTC). NNTC contains a variety of commercial businesses, and is surrounded by residential neighbourhoods.

#### PROPOSED DEVELOPMENT

The applicant proposes to renovate the exterior elevation of NNTC's Commercial Retail Unit (CRU) #143, which is 9,030ft<sup>2</sup> in size and located between London Drugs and Fairway Market. The application proposes to create a new exterior storefront in an area that currently functions as the back of the building.

The proposal also includes:

- updated pedestrian features;
- six new parking stalls;
- new landscape plantings; and,
- a new loading bay location.

#### Site Design

The application proposes to convert two existing loading bays and a landscaped area into an improved sidewalk area and six new parking spaces directly in front of the unit. The applicant proposes to move the loading bay from the front of the building to the side (northwest) of the store entrance. The new loading bay requires the existing sidewalk and crosswalk location to be altered, with the new layout resulting in a shorter crosswalk between wider sidewalks. Landscaping is proposed to separate the new loading bay from the sidewalk.

Because NNTC currently has a surplus number of parking spaces, the proposed parking is not required. However, the new parking spaces and loading bay will use permeable material, as per City of Nanaimo Parking Bylaw No. 7266.

#### Staff Comments:

- Consider ways to minimize potential conflicts between pedestrian/vehicle movement at the new loading bay location
- Consider reducing the number of surplus parking spaces to allow for further landscaping and/ or pedestrian space
- Consider incorporating accessible parking.

#### **Building Design:**

The exterior renovations will create a new storefront for an existing CRU, with an internal connection to the mall, in an area that currently acts as a "back of building" loading and waste management zone. The new design features glazed doors, large windows, and new exterior signage. Finishing materials include brick and an EIFS (exterior insulation finishing system) bulkhead with walnut wood soffit.

#### Staff Comments:

Consider adding weather protection over the entrance

#### Landscape Design

The landscaping plan proposes to add trees and concrete planters along the pedestrian area, and two landscape islands. The planters will screen the existing gas meter located on the exterior wall near the unit entrance, and the landscape islands provide separation and screening for the loading bay and garbage enclosure. Three trees will be placed in front of the new parking stalls, and there will be an additional three trees with a variety of shrubs in the raised landscape planters.

#### Staff Comments:

- Reconsider the use of specked Pachysandra terminalis (concern over invasive tendencies).
- Consider adding further space for programming of use outside the unit (e.g. public seating, display areas, etc.)
- Consider adding pedestrian scale lighting throughout the updated pedestrian area.

#### PROPOSED VARIANCES

No variances are proposed.

MK/



604.681.2358 info@shapeproperties.com shapeproperties.com 2020 One Bentall Centre 505 Burrard St., Box 206 Vancouver, BC, Canada V7X 1M6

#### UNIT 143 DEVELOPMENT PERMIT - DESIGN RATIONALE

We are pleased to provide the Development Permit Application for the new exterior storefront of Unit 143 at Nanaimo North Town Centre.

#### Site Works

The pedestrian experience will now be enhanced by transforming what is now a "back of house" area into part of the public realm and creating more continuous pedestrian experience from the mall entrances between London Drugs and Fairway Market.

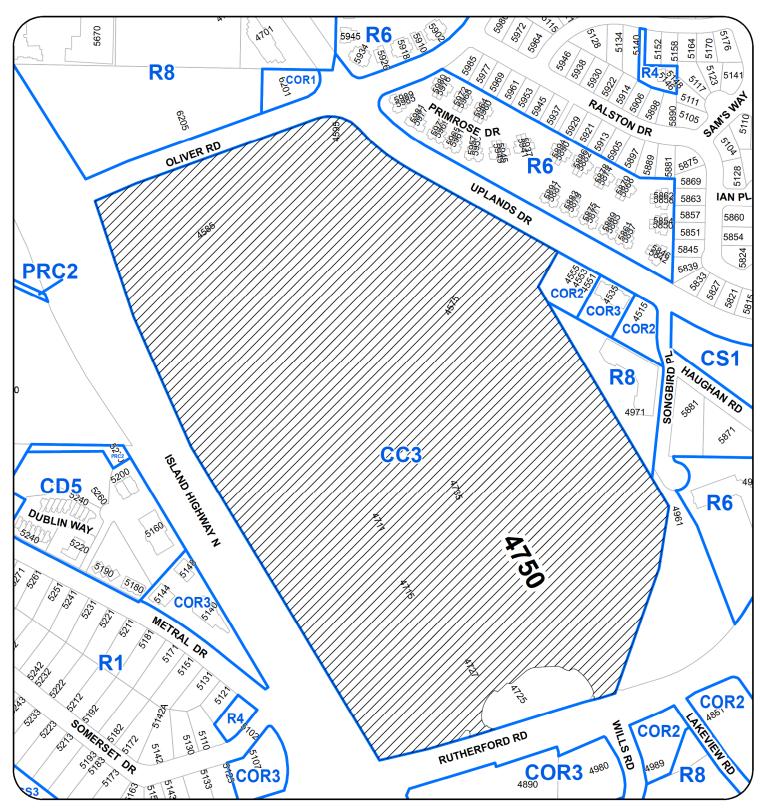
#### Form & Character

The form and character of the new exterior storefront remains consistent with other new storefronts that have been done on site over the past years.

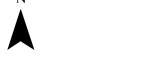
#### Material & Colour

The design of this storefront uses mainly neutral colours with a touch of wood for warmth and ties in the new storefront with existing tenant Fairway Market with the use of the same brick colour while creating a striking modern look with the black EIFS bulkhead.

#### **LOCATION PLAN**



## DEVELOPMENT PERMIT NO. DP001129 LOCATION PLAN



Subject Property

Civic:4750 Rutherford Road Legal: LOT A OF SECTION 14 AND DISTRICT LOTS 14 AND 17 AND SECTION 4 RANGE 4 WELLINGTON DISTRICT PLAN VIP66202







Musson Cattell Mackey Partnership

SHAPE

NANAIMO NORTH TOWN CENTRE

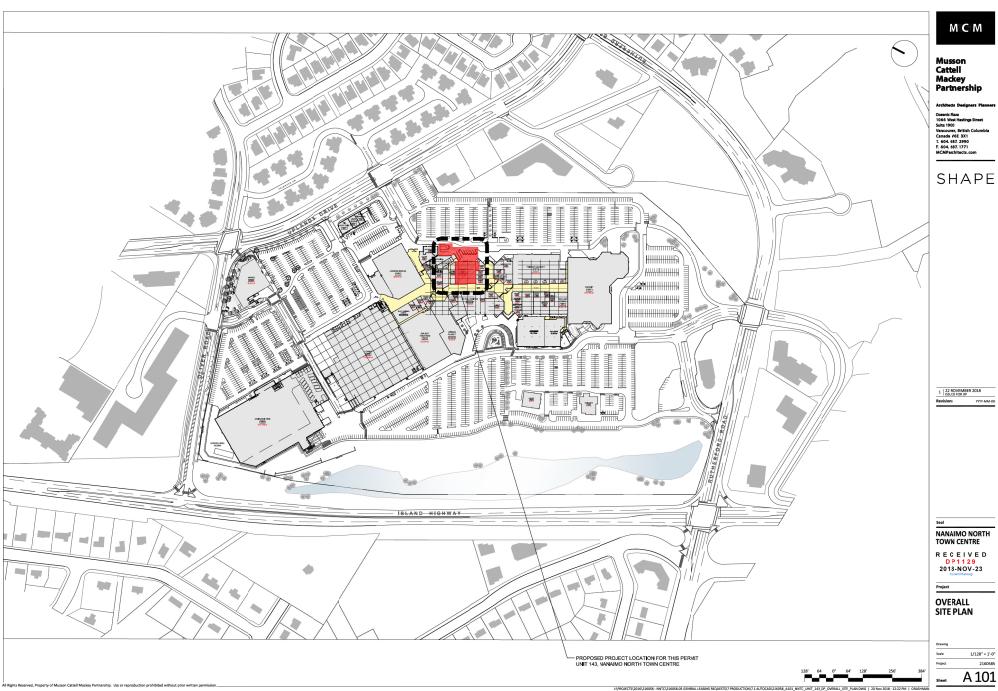
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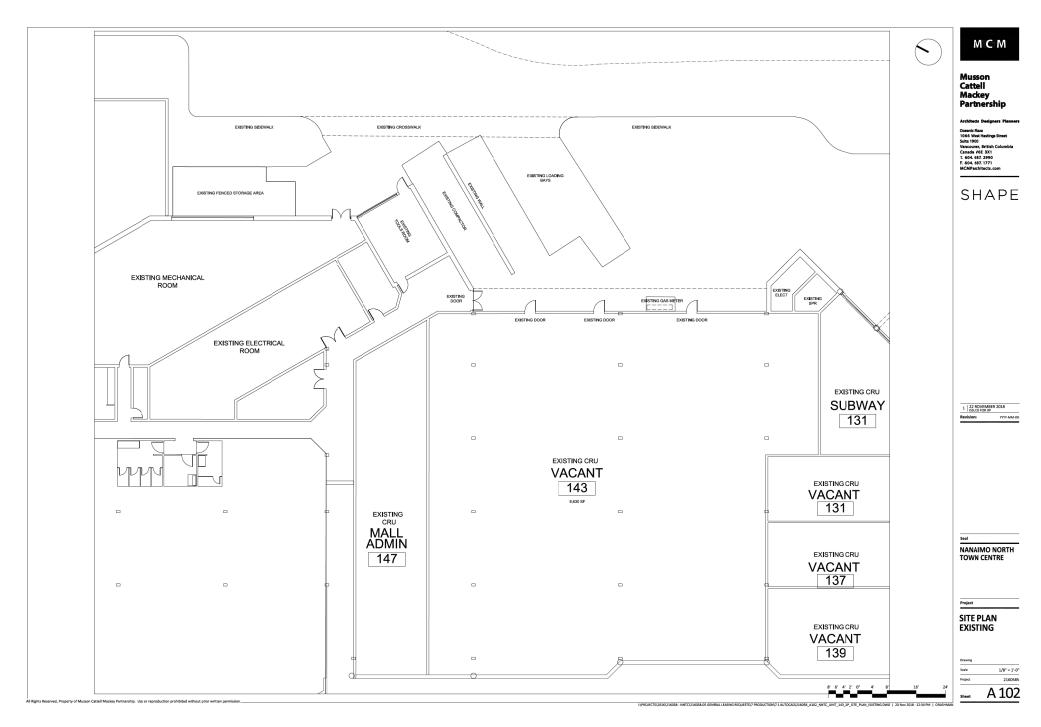
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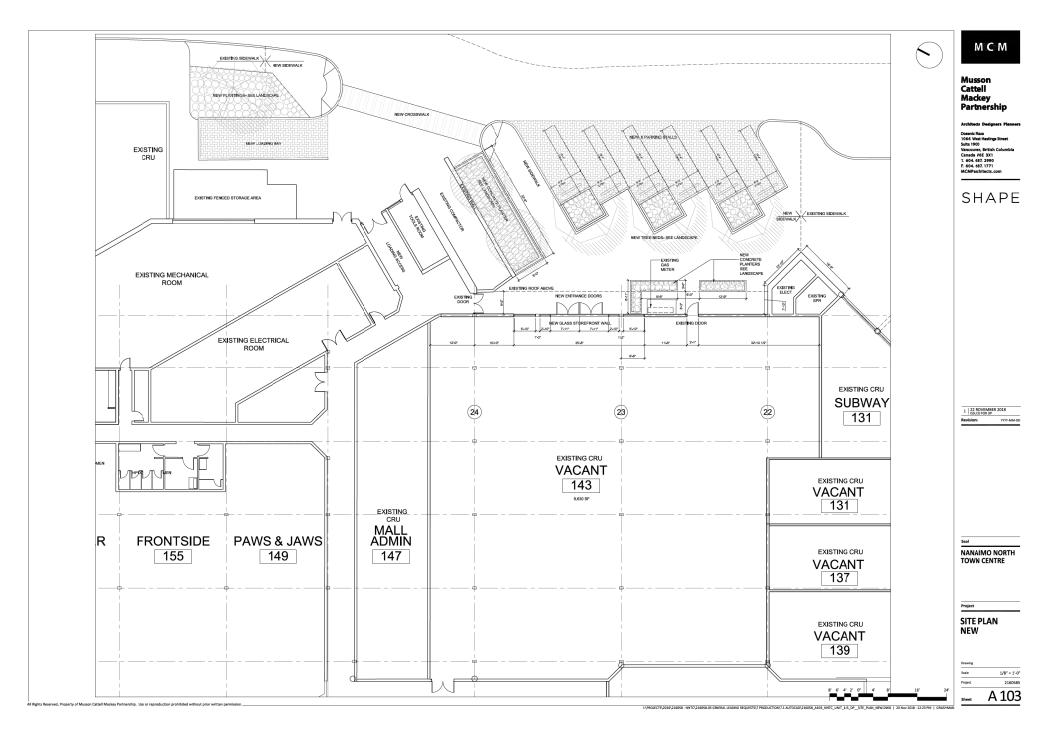
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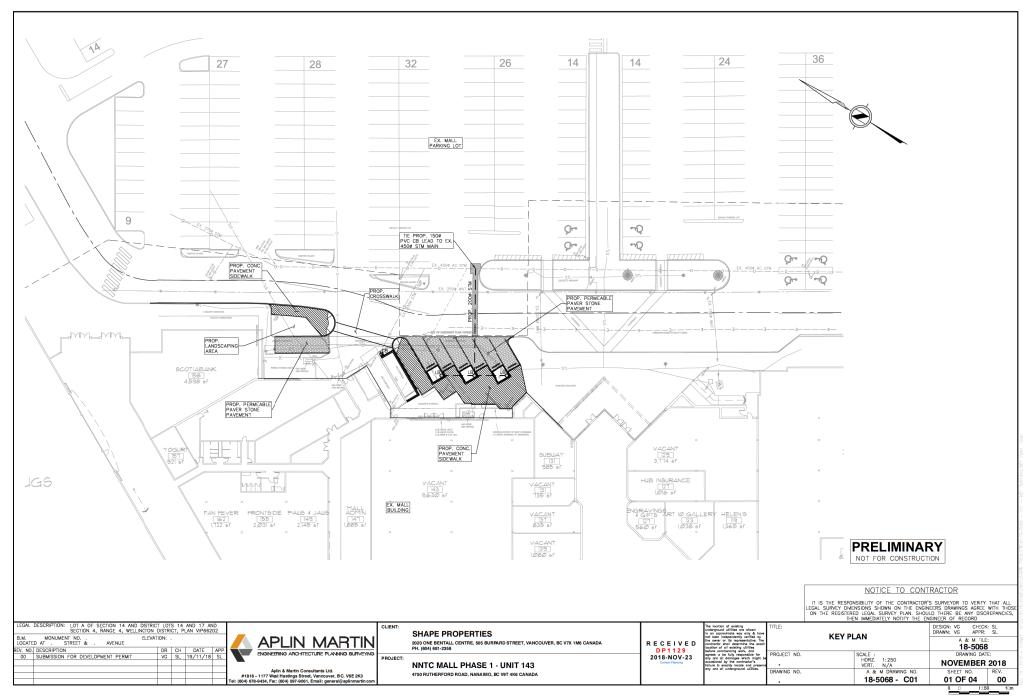
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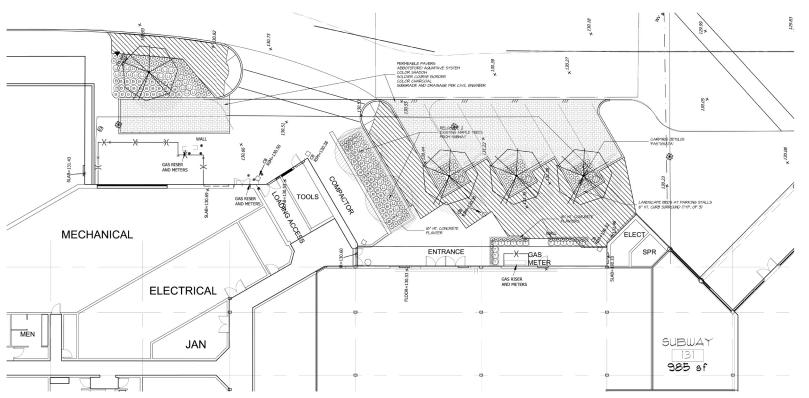
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PLANT SCHEDULE - UNIT 143 PMG JOB NUMBER: 9x-xxx							
KEY	QTY	BOTANICAL NAME	COMMON NAME	PLANTED SIZE / REMARKS			
TREE	4	CARPINUS BETULUS 'FASTIGIATA'	PYRAMIDAL EUROPEAN HORNBEAM	7CM CAL; 1.8M STD; B&B			
В	61	BUXUS 'GREEN VELVET'	GREEN VELVET BOXWOOD	#2 POT; 25CM;			
T	15	TAXUS X MEDIA 'HICKSII'	HICK'S YEW	1.2M HT.; B&B			
GC							
L1	43	LONICERA PILEATA	PRIVET HONEYSUCKLE	#2 POT; 25CM			
X	187	PACHYSANDRA TERMINALIS	JAPANESE SPURGE	#1 POT; 15CM			

NOTES \* PLANT SIZES IN THIS LIST ARE SPECIFED ACCORDING TO THE BELL ADMOCRATE STANDARD AND CANDIANI LANDSCAPE STANDARD AND CANDIANI LANDSCAPE STANDARD AND CONTAINER SIZES SPECIFIED AS PER CHILD ASTRONOMY OF THE THE LANDSCAPE AND CONTAINER SIZES SPECIFIED AS PER CHILD ASTRONOMY OF THE THAT SIZE AND CONTAINER SIZES ARE THE MINIMUM ACCEPTABLE SIZES. \* REFERT TO SPECIFICATIONS FOR DEFINING DOMINANCE MESONAL PROPERTY OF THE THAT AND CONTAINERS AND CONTAINERS. \* SANDARD AND CONTAINERS AN

NOTES:

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2. CONTRACTOR TO PROVIDE DESIGN-BUILD AUTOMATIC IRRIGATION SYSTEM. SHOP DRAWINGS TO BE REVISIBLED AUTOMATIC IRRIGATION SYSTEM SYSTEM IF FEASI

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Suite C100 - 4185 Still Creek Dri Burnaby, British Columbia, V5C 6 p: 604 294-0011; f: 604 294-0022

EAL:

NO. DATE REVISION DESCRIPTION C.

PROJECT

UNIT 143 NANAIMO NORTH TOWN CENTRE MALL NANAIMO, BC

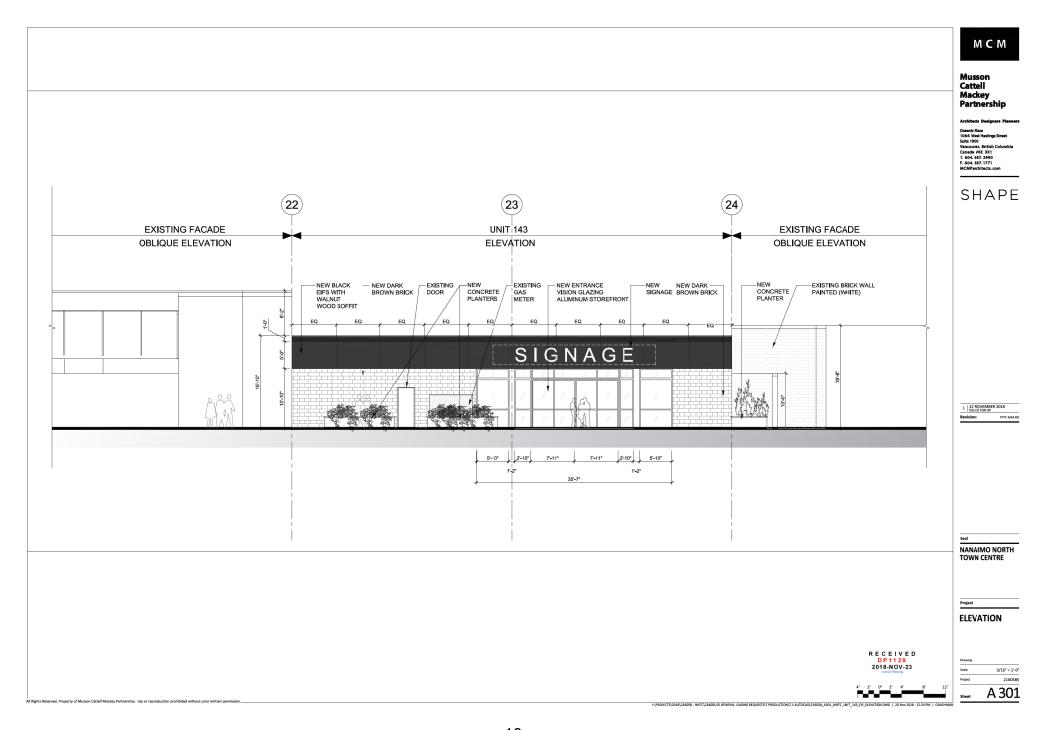
LANDSCAPE PLAN

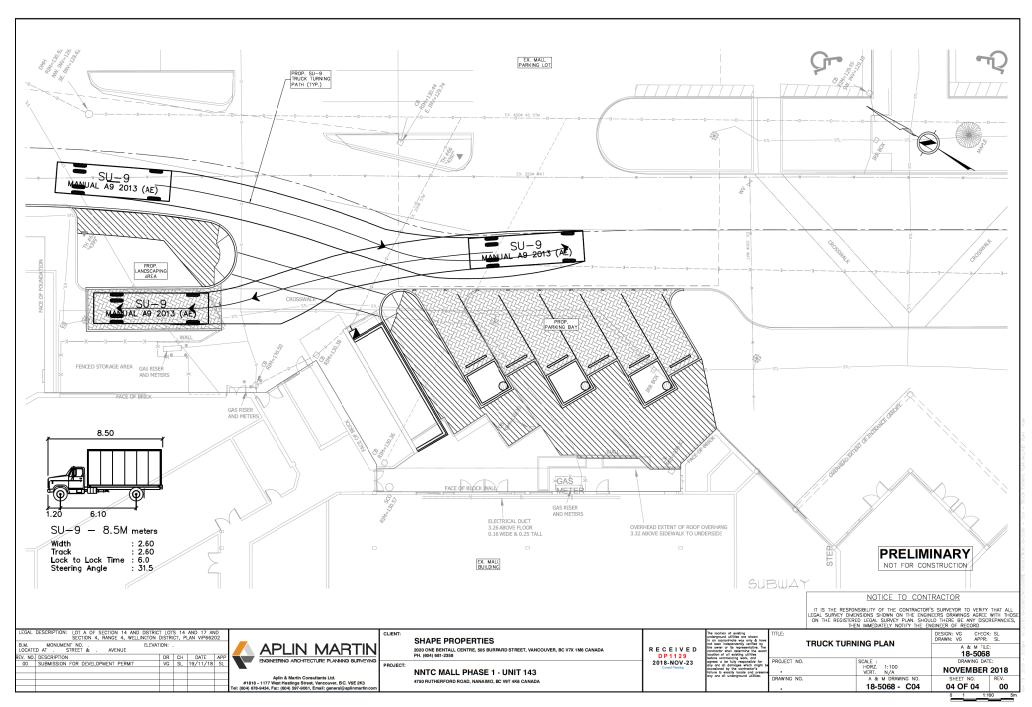
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SCALE: 1/8" = 1'-0"
DRAWN: BA
DESIGN: BA
CHKD:

L1

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11220-UNIT143.ZIP PMG PROJECT NUMBER:





#### **AERIAL PHOTO**





#### **DEVELOPMENT PERMIT NO. DP001129**



#### DEVELOPMENT PERMIT NO. DP001126 -560 THIRD STREET

Applicant Architect: DEVON SKINNER, WENSLEY ARCHITECTURE LTD.

Owner: THIRD STREET NANAIMO HOLDINGS LTD.

Landscape Architect: MACDONALD GRAY

#### Subject Property:

Zoning	COR 2 – Mixed Use Corridor
Location	The proposed development fronts on Third Street, with Lambert
Location	Avenue and Howard Avenue flanking the subject property.
Total Area	1.3ha
	Map 1 – Future Land Use Plan – Corridor;
Official Community	Map 3 – Development Permit Area DPA No. 9 – Commercial,
Plan (OCP)	Industrial, Institutional, Multi-family and Mixed Commercial /
	Residential Development
Relevant Design	General Development Permit Area Design Guidelines; Harewood
Guidelines	Neighbourhood Plan Urban Design Guidelines

#### Site Context

The site is located on Third Street, between Howard Avenue and Lambert Avenue in the University District. The lot is rectangular in shape and slopes down towards the north, with a significant grade change from west to east. At present, the lot contains an orchard of mature fruit trees remaining from the lot's historic use as a farm. There are no buildings or structures on the lot.

The property is immediately surrounded by residential uses, including single residential dwellings to the north and west, and townhouses to the east. To the south are single residential dwellings, and a new development under construction at 525 Third Street which contains student housing, multi-family units/ townhouses and ground-level commercial along Third Street.

#### PROPOSED DEVELOPMENT

The applicant proposes to construct two four-storey apartment buildings, one of which is mixed use, with a total of 181 residential condominium units.  $511m^2$  of commercial space is proposed adjacent to the plaza between the two buildings, mid-block on the Third Street frontage of Building B. The proposed residential units include  $\pm 30m^2$  micro units,  $\pm 42m^2$  studio units,  $\pm 57m^2$  one bedroom units,  $\pm 87m^2$  two bedroom units, and one and two bedroom loft units ranging in size from  $\pm 63m^2$  to  $\pm 102m^2$ .

#### Background

In 2012, the site was rezoned and the lots to the north were subdivided and developed with single residential dwellings.

Development Permit Application DP1126 – 560 Third Street Staff Design Comment Page 2

#### Site Design

The proposed apartment buildings are configured to build a streetscape along Third Street, Lambert Avenue, and Howard Avenue. A plaza is proposed between the two buildings on the Third Street frontage.

Because of the lot's sloping topography, retaining walls are proposed to create three tiered parking areas. 188 parking spaces are required under the City of Nanaimo Parking Bylaw No. 7266, and 211 are proposed, a surplus of 24 parking spaces. Of the proposed parking spaces, 188 are surface parking spaces and 24 are under-the-building parking spaces (beneath Building A). Each building has a loading space, and a total of 100 bicycle parking spaces are provided, with 50 spaces in each building.

The plaza between the two buildings is accessible from Third Street by both stairs and a ramp, and a walkway leads from the courtyard to an existing pedestrian path that was created as part of the subdivision of the single residential lots to the north.

#### Staff Comments:

- The Harewood Neighbourhood Plan suggests that buildings with four storeys or more should use underground or under-the-building parking. Consider opportunities to reduce surface parking / increase under-the-building parking.
- The Harewood Neighbourhood Plan encourages urban agriculture within the community.
   Consider opportunities to retain existing mature fruit trees, preserve existing site soils, and create opportunities for a community garden and/or other forms of urban agriculture.
- The proposed plaza and onsite walkway are misaligned with the existing pedestrian path to the north, and Watfield Avenue to the south. Consider whether there are opportunities to bring these features into alignment.
- Consider opportunities to create cohesion between this development and the new development across Third Street.

#### Building Design:

The two buildings are four storeys in height, with a rectilinear form and a series of "white boxes", intended to break up the building mass and add visual interest. Finishing materials include stucco, Hardie panel, metal cladding and concrete. Balconies are included on most building elevations, and either ground level or raised patios are included with street accesses to connect to Third Street. Building A is located on a significant slope, and has been broken into two sections to follow the grade change. Building entrances are provided on all street frontages and from the northern parking area.

The commercial unit is located on the ground floor of Building B, and is accessible from the courtyard through glass doors with a steel and glass awning. The unit's design features uniform storefront glazing and metal sign lettering mounted to Hardie panel siding.

The buildings also include vertical circulation towers with corrugated metal cladding and windows into the stairwells. The towers extend over the roof to accommodate the stairs, elevator and enclosed mechanical equipment space.

Development Permit Application DP1126 – 560 Third Street Staff Design Comment Page 3

The ground level units in Building A have balconies with glazed railings set atop a retaining wall to mitigate the grade change.

The units in Building B fronting on Lambert Avenue are described by the applicant as having a "townhome-like feel", and are differentiated from other units in the development by having substantial glazing, and an increased ceiling height to accommodate loft spaces within these units. Patio spaces on a retaining wall, raised above street level and accessible by concrete stairs, are included for each of these units.

#### Staff comments:

- The Harewood Neighbourhood Plan encourages development of properties with historic interest in a manner that respects the site's history. Housing forms, designs, and materials that respect and celebrate the rural/agricultural traditions of Harewood are encouraged by the Plan. At present, the proposal does not appear to include any elements that reflect the site's agricultural heritage.
  - Consider opportunities to celebrate the site's history as a five acre farm through building design elements, architectural features, public art, and landscaping
- The Harewood Neighbourhood Plan encourages the use of natural building materials including wood, stone, brick and metal. Consider incorporating more natural materials into the building finishes.
- Consider further ways to break up the rectilinear building form along the Third Street frontage e.g. breaks in the roofline; more pronounced building entrances; and further distinguish the commercial use.
- Consider further design detail at the corner of Third Street and Howard Avenue.
- Consider ways to better transition the building elevations toward the plaza space between Buildings A and B:
  - o increase interaction between the plaza and the adjacent apartment units, particularly for the units in Building B:
  - o break up blank wall building elevations, particularly Building B's east-facing wall;
  - redesign the stairwell exit doors to function as welcoming entrance/exit points for the buildings that interface with the plaza space.
- The Harewood Neighbourhood Plan encourages multi-family building massing to respect
  adjacent building forms, and states that upper storeys should be stepped back when
  placed next to single residential development and walkways.
  - Consider opportunities to step down the building massing to ease the transition from single family to multi-family densities.

#### Landscape Design

The landscaping plan can be broken down into three categories:

#### The parking area includes:

- Trees in shrub filled landscape islands throughout the parking area:
- A hedge comprised of Japanese holly and emerald arborvitae lining the drive aisle to screen the single residential dwellings to the north;
- Shrub filled planters lining the north drive aisle.

#### The street frontage includes:

- Street trees along the Third Street and Howard Avenue frontages;
- A lawn area surrounding the street trees on either side of the plaza's Third Street frontage, including the area in front of the commercial unit;
- Shrub filled landscape planters at the building corners, and surrounding a number of the street trees.

#### The plaza includes:

- Trees with grates;
- Interlocking paving stones;
- Shrub filled planters:
- Picnic tables;
- Benches:
- Bollard lights.

#### Staff Comments:

- In recognition of the site's history and the Harewood Neighbourhood Plan's policy for urban agriculture, consider the use of edible landscaping, retention of existing mature fruit trees, and/or the introduction of a community garden space;
- More details are required to better illustrate the retaining walls and corresponding landscape screening;
- Consider whether the proposed hedge will provide sufficient screening for properties to the north;
- Consider opportunities to enhance the interface between the plaza, the adjacent commercial unit, and the apartment entrances;
- Consider opportunities to enhance the interface between the plaza and the apartment entrances;
- Reconsider the use of Heavenly Bamboo (concern over toxicity to birds).

#### PROPOSED VARIANCES

A building height variance is proposed for Building B. The applicant is to confirm the extent of the proposed variance at the Design Advisory Panel meeting.



October 30, 2018

City of Nanaimo Community Development 41 Dunsmuir Street Nanaimo BC V9R 0E4

Re: 560 Third Street "DLX on Third", Nanaimo BC
Architectural Design Rationale & Variance Rationale

Wensley Architecture Ltd., on behalf of WDC Nanaimo Developments Ltd., is pleased to submit this development permit application for the property located at 560 Third Street. The intent of the application is to construct two new 4 storey buildings containing 181 residential units and a ±5500 ft² commercial retail unit (CRU). The units are a mix of micro-suites, studios, as well as 1- and 2-bedroom units, for a total of ±97,611 ft² of residential area.

#### **Site Information**

The site is located on the north side of 560 Third Street, spanning between Howard Avenue to the east and Lambert Avenue to the west. The north side of the site is bordered by single family residential, and the south side faces Third Street. The site forms a rectangular shape and features a significant grade change from west to east. The site is approximately 12,600.4m² in area and is currently zoned COR 2.

#### **Massing and Siting**

The two buildings (A & B) are placed on the site adjacent to Third Street, Lambert Ave, and Howard Ave. Each building is 4 storeys and is proposed to be built with a combination of concrete suspending slab and wood frame construction. Building A is split into A1 and A2 by a firewall.

Surface parking has been located on the north side of the site, with the parking ramp adjacent to the northern property line. Retaining walls and a landscape buffer will be utilized to transition between the proposed development and the existing developments. Due to the nature of the topography, any development here would require retaining structures. To minimize the height of these structures and avoid creating overwhelmingly large areas of pavement, the parking areas have been broken into 3 tiers. Each tier provides convenient access to one of the buildings.

Architecturally, the building form steps up with the natural site grades to mitigate the amount of cut and fill required and to maintain as much of the natural character of the site and topography as possible. To avoid the creation of a monolithic building form over the length of Third Street, the two buildings have been broken up using a series of "white boxes" that pop up and out from the primary faces of the buildings. The design intent is to break up the length of the buildings by creating varied elements marching down the street and provide a livelier experience for pedestrians and vehicles passing by.

In addition, we have proposed a central amenity space between Buildings A and B. This space provides a common gathering area for the site, access to the main entrance of the CRU, and acts as the destination point for the pedestrian passthrough from the north side of the site.

- 1. Variance: Building B is over height based on Average Grade
  - a. **Rationale:** Main floor of Building B is 16'. This is proposed to provide a more generous main floor height for the CRU (16' floor height) to attract and retain commercial tenants. As a side benefit, it

allows for the opportunity to introduce unique loft units at the main level of building B that have a "town home-like" feel along Third and Lambert. This contributes to the activity and vibrancy along Third Street especially.

#### Streetscape & Relationship to the Street

#### 1. North Elevation -

The parking access lane runs along north property line with vehicular access from Lambert and Howard Avenues. We are also proposing connecting the existing pedestrian connection on the north side of the site through to the central plaza on Third Street.

To minimize the height of the retaining walls required along the north side, a balance between the building main floor geodetic elevations and the parking areas had to be negotiated. To keep the units as accessible as possible from Third Street, Lambert Ave. and Howard Ave., retaining walls are required at the north side of the site to be able to access the parking areas and keep the slopes of the ramps within acceptable parameters. A 1m planted landscape buffer is proposed between the retaining walls and the property line to soften the interface and provide screening for the adjacent properties. Refer to landscape.

Building A and B have accessible main entrances to the lobby from the northern parking area. Building B's loading area, residential, and commercial garbage are also accessed from this side.

#### 2. East Elevation (Howard Ave) -

Building A's main entrance faces Howard Avenue with access to the lobby and bicycle racks adjacent to the main doors. The loading areas and residential garbage is accessed from this side as well. These areas are screened with landscaping.

The main floor patios are elevated from the sidewalk due to the grade change along Howard Ave, but glass guardrails and planting is utilized to maintain visual interest and soften the interface between the raised patios and streetscape.

#### 3. South Elevation (Third Street) -

Along Third Street, the intent is to break up the length and mass of the building by creating varied forms that march along the street. Building A features as many at grade patio entrances with sidewalks as possible to relate to the streetscape and public realm. Each patio is screened with landscaping to ensure a comfortable level of privacy for the owners.

Building B features a higher main level (16') to accommodate the Commercial unit. The CRU has large storefront windows and landscape trees spaced to allow views to and from the inside space from Third Street. The residential portion of the main floor of Building B features a series of "town home" units. These have denser landscaping to provide privacy and contribute to the street frontage. These units also take advantage of the higher floor height to create unique loft style units with increased glazing and generous outdoor patios with access from the street.

A central public plaza is proposed between Buildings A2 and B. We have proposed interlocking paving stones with landscaping, lighting and public street furniture to enhance the quality of the space. Additionally, there will be steps and an accessible ramp from the pedestrian sidewalk along Third Street to provide easy access to the plaza and commercial unit. This space is a gathering point on the site and forms an important part of the cross connection through the site.

#### 4. West Elevation (Lambert Ave) -

The residential portion of Building B's main floor continues around the corner of Third and Lambert. These units feature large outdoor patios with stairs to access Lambert Avenue. Each set of stairs is terminated with an architectural concrete post with lighting and unit number. The street entries are also landscaped to soften their interface with the property line. One of the main entrances to Building B is also located off Lambert Avenue. It features a wider stair with planters on either side as well as a steel and glass canopy over the door.

#### **Exterior Finishes**

Exterior cladding materials were selected based to satisfy three primary factors:

- Visually appealing for the current and future markets
- Materials to be durable
- Low Maintenance

As discussed above, the lengths of the buildings are broken up using a series of rectangular white boxes. Smooth acrylic stucco is the proposed cladding. This will provide a high quality and durable finish. The inside faces of the white boxes introduce white horizontal cementitious siding as the primary material, with balcony insets being clad with vertical wood grain siding. The upper inside soffit will match this wood grain. Balconies feature black picket guardrails. Flashings and trims will be coloured to match adjacent finishes.

The portions of the buildings that are set back from the white boxes are clad with dark grey vertical siding. The juxtaposition of the white boxes against the dark backdrop make the building more visually interesting and deemphasizes the length of the site. The white boxes punctuate the dark backdrop and create a more lively and animated building form. To further distinguish the light areas from the dark, we have opted for different mullion patterns for the windows and have proposed glass guardrails at the balconies instead of picket guardrails. A light grey stucco provides a visual cue at the inset balconies on the upper floors.

Vertical circulation towers are clad with corrugated metal and feature windows into the stairwells where appropriate. The towers wrap up on to the top of the roof to create enclosed mechanical spaces.

Where the building meets the grade, natural concrete bases are proposed for durability. These will be completed with complimentary landscaping. Town homes along the main floor of building B feature concrete stairs with metal picket guardrails. Lighting and unit numbers will be incorporated at main level entrances and patios.

The Commercial Unit in Building B features large storefront glazing with black frames and a glass and black steel canopy above.

The central plaza features landscape planting beds, public street furniture, decorative rock adjacent to the foundations of the buildings, and a higher quality paver for the ground treatment.

#### Safety & Security (CPTED)

The programming and configuration of the buildings provide healthy opportunities for natural surveillance. While privacy is maintained for individual dwellings, the parking areas, common areas, and outdoor spaces have sightlines from multiple dwelling units.

#### Page 4 of 4

Landscaping has been utilized to create a sense of ownership for residents on the site. Symbolic barriers in hard and soft landscaping create a sense of place when entering the site and provide visual screening for at grade patios. Additionally, the outdoor plaza and benches provide a central place for residents to meet and interact.

Authorized by:

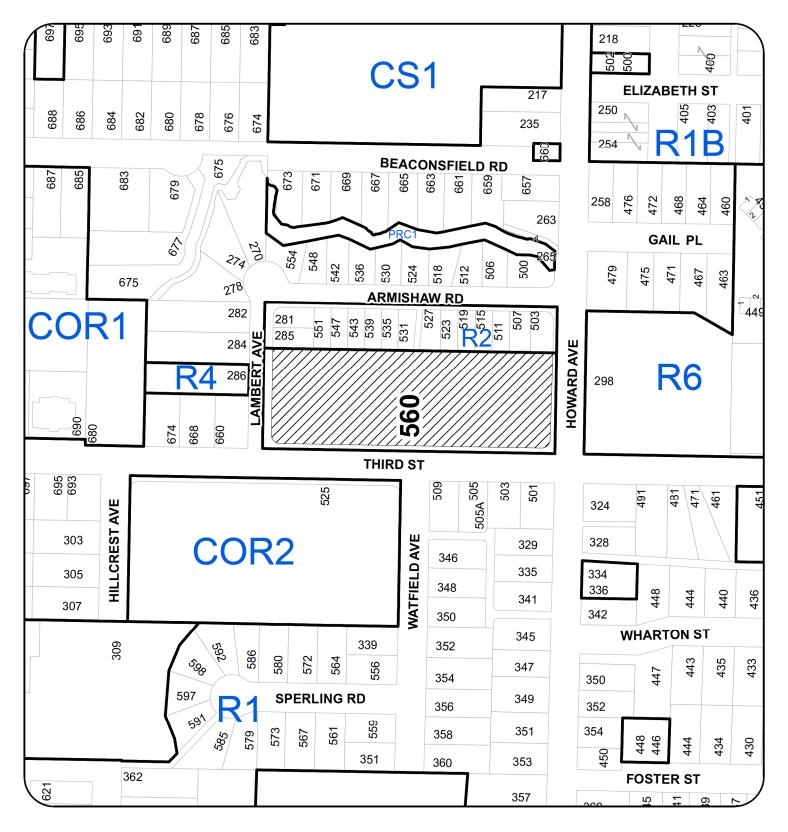
Devon Skinner, Architect AIBC, AAA, SAA

Please Print Name and Title

**Authorized Signature** 

Date: OCTOBER 30, 2018

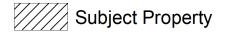
#### **LOCATION PLAN**



## DEVELOPMENT PERMIT NO. DP001126 LOCATION PLAN

N

Civic: 560 THIRD STREET Legal: SECTION 33, RANGE 6, SECTION 1 NANAIMO DISTRICT, PLAN 630 EXCEPT PART IN PLAN EPP32701





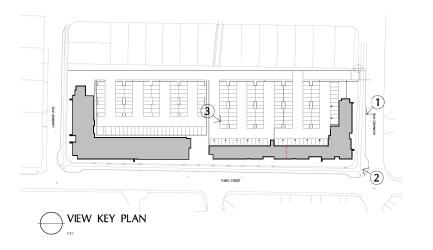
1 BLDG A1 - VIEW OF HOWARD AVE. SIDE



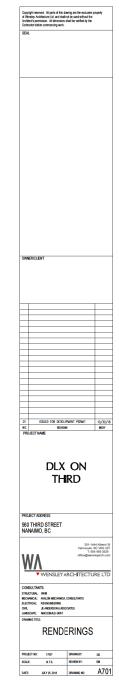
3 BLDG A1 / A2 - VIEW OF NORTH SIDE



2 BLDG A1 / A2 - VIEW FROM CORNER OF THIRD & HOWARD



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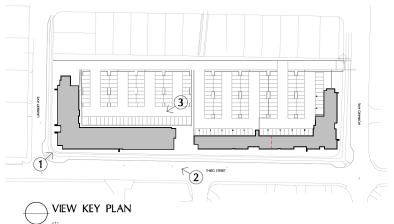
1 BLDG B - VIEW FROM LAMBERT AVE. & THIRD ST.



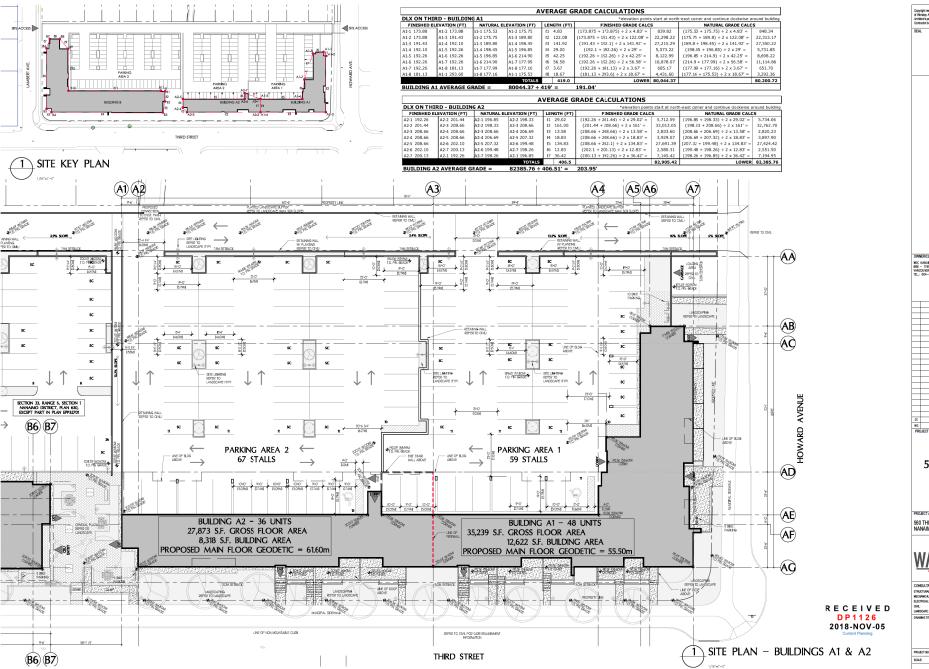
3 BLDG B - VIEW OF NORTH SIDE



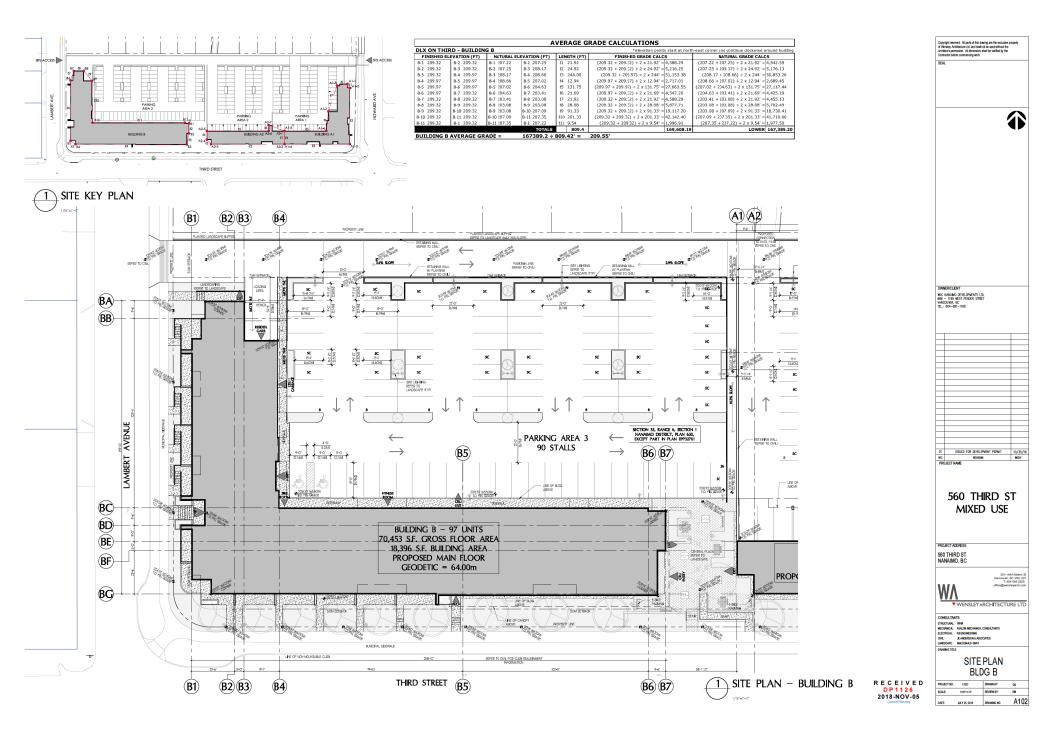
2 BLDG B - VIEW ALONG THIRD STREET

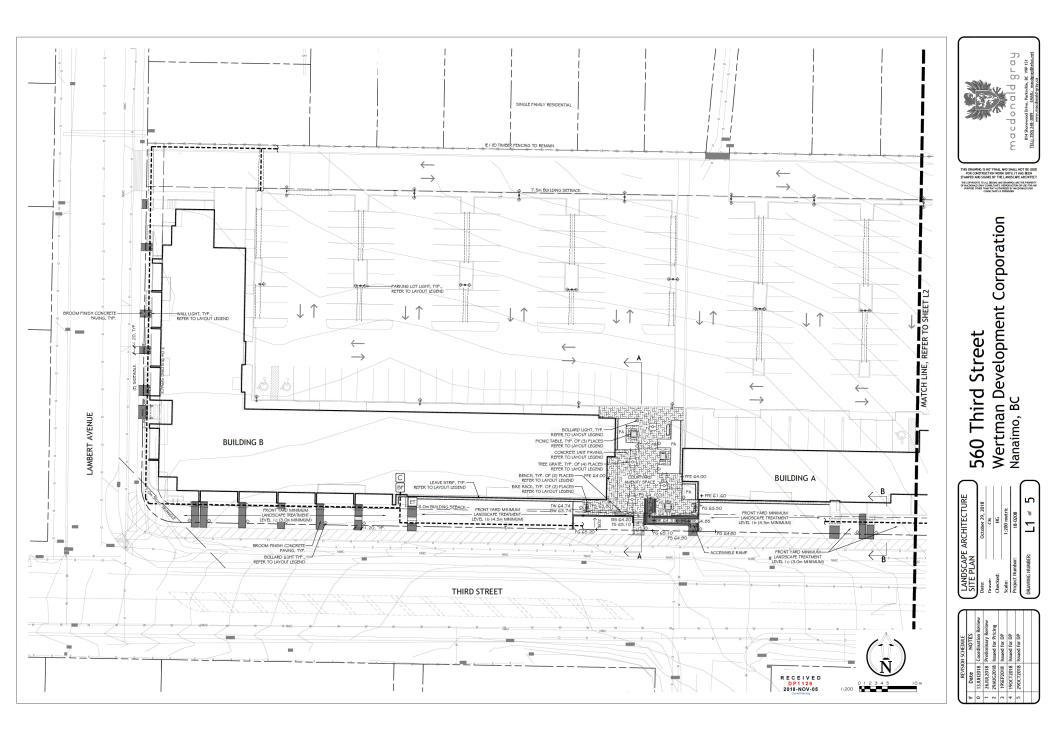


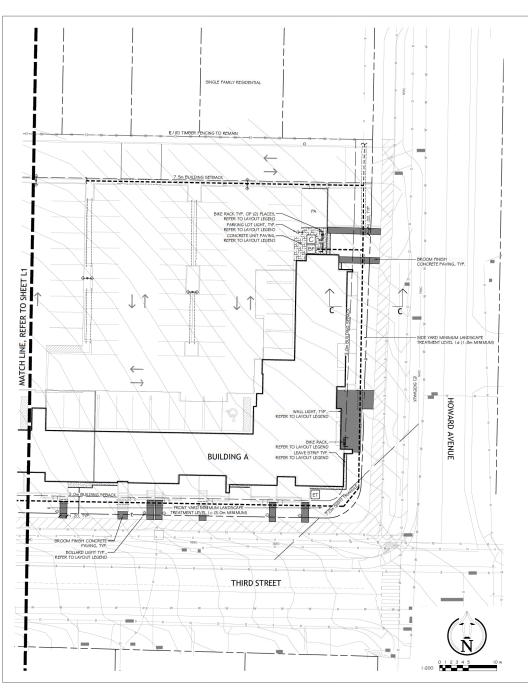
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2018 - NOV - 05
Current Placering











#### LANDSCAPE ARCHITECTURE SITE PLAN NOTES

- 1. THE LANDSCAPING CHARACTER AREA FOR THE SITE IS: HAREWOOD
- REFER TO SITE PLAN PREPARED BY WENSLEY ARCHITECTURE LTD. FOR SITE PLAN LAYO JT, PROPOSED PHISHED PLOOR LEVATIONS, STREET PRONTAGES, BUILDING ENTRANCES STARS, WALLS AND OTHER ASCHITECTURAL INFORMATION.
- REFER TO CIVIL PLANS AND REPORT PREPARED BY J.E. ANDERSON & ASSOCIATES FOR ALL SITE SERVICING, GRADING AND STORM WATER MANAGEMENT INFORMATION.

SERVICING, GRADING AND STORM WATER MANAGEMENT INFORMATION.					
LAYOUT	LEGEND				
ABBREVIATIONS	DESCRIPTION				
(E) E PA	EXISTING PROPERTY LINE PLANTING AREA				
TYP.	TYPICAL				
SYMBOL	DESCRIPTION				
	PROPERTY LINE				
-0	EXISTING TIMBER FENCING TO REMAIN				
	CONCRETE RETAINING WALL TO MATCH ARCHITECTURAL FINISH				
	BROOM FINISH CONCRETE PAVING				
	CONCRETE UNIT PAVING: MANUFACTURER: ARBOTSFCRD CONCRETE STULE: 3:1 STANDARD FILIDA STANDARD SOLDIER COURSE COLOUR: CHARCOLA, WITH INTURAL SOLDIER COURSE PATTERN: 3:1 OFFSET RUAINES BOND PATTERN 3:1 OFFSET RUAINES BOND				
	LEAVE STRIP WITH TIMBER EDGE: 0.45m MIN, WIDTH OF 50mm (2") MINUS, WASHED RIVER ROCK OVER LANDSCAPE PABRIC				
-0-	TREE GRATE: CTY: 4 MANUFACTURER: WELLINGTON FOUNDRY STYLE: 1.2m (4) SQUARE				
	BENCH, SUPPACE MOUNTED ON 1.6m X 0.5m BROOM FINISH CONCRETE FAD: OTY: 2 MANUFACTURER: MISHBONES SITE FURNISHINGS STYLE: DESELT FARS BENCH: A LIL METAL. MODEL BAL-5 COLOURE BALA-5 COLOURE BALA-5 COLOURE BALA-5 FOR TECURE				
	PICHIC TALE, IN-GROUND MOUNT: OTY: 3 MANUFACTURER, WISHERDIK SITE FURNISHINGS STALE SHALE TO FORM CTALE MODEL (2) SPYTGS-40 4 (1) SPYTMCGP-40 (ACCESSIBLE ONE SIDE) SLAT COLOUR HARBOUR GEFY				

#### FRAME COLOUR: BLACK SUPER TEXTURE

(6) STALL BIKE RACK: OTY: 5
MANUFACTURER: CORA CANADA
STYLE: MULTI RACK
MODEL: W5808
COLOUR: BLACK

BOLLARD LIGHTING: CTY: 24 MANUFACTURER: KING LUMINAIRE OR APPROVED EQUAL STYLE: SILOUETTE LED MOOPLE KL.A-S COLOUR: STANDARD BLACK

PARKING LOT LIGHT (FULL CLT OFF, LED FLAT LENS): MANUFACTURER: KING LUMIWAIRE OR AFFROVED EQUAL STYLE: CENTURION LED MODEL: K92 COLOUR: STANDARD BLACK

LED STEP LIGHT/ WALL LIGHT/ ENTRY MARKER:
MAKE AND MODEL AND COLOUR TO BE COORDINATED WITH ARCHITECTURAL LIGHTING
SCHEME

FINAL PARKING LOT LIGHTING, BOLLARD LIGHTING AND STEPWALL LIGHTS MAKE MODELS, LOCATIONS, QUANTITIES AND PHOTOMETRIC ANALYSIS SHALL BE BY PROJECT ELECTRICAL ENGINEER.

#### IRRIGATION EQUIPMENT LEGEND

SYMBOL	MANUFACTURER	MODEL	DESCRIPTION
C	HUNTER	TBD	(2) AUTOMATIC IRRIGATION CONTROLLERS IN MECHANICAL ROOMS OF BUILDINGS
ET	HUNTER	WS6-SEN	(2) WIRELESS SOLAR-SYNC SENSORS ON SOUTH-FACING EAVES
BF	BY MECHANICAL	BY MECHANICAL	(2) 38mm (1.5") DOUBLE CHECK BACKFLOW PREVENTERS AND WATER SUPPLY
		SCHEDULE 40	(2) 38mm (1.5") PVC MAINLINES
		SCHEDULE 40	PICS SLEEVES UNDER ALL PAVING AND THROUGH WALLS MIN. TYP:  MAILINE & LATERALS: I COmn (4)  LATERALS ONLY: 75mm(2)  CONTROL WRE: 50mm(2)  BURIAL DEPTH TO MATCH DEPTH OF CARRIED PIPE

#### RECEIVED 2018-NOV-05

#### GRADING LEGEND

SYMBOL	DESCRIPTION
+ FFE 10.00	FINISHED FLOOR ELEVATION
+ FS 10.00	FINISHED SURFACE
+ FG 10.00	FINISHED GRADE
+ TW 10.00	TOP OF WALL
+ BW 10.00	BOTTOM OF WALL
+T5 10.00	TOP OF STAIR
+ 85 10.00	BOTTOM OF STAIR
+ TR 10.00	TOP OF RAMP
+ BR 10.00	BOTTOM OF RAMP
2% MIN.	DRAINAGE DIRECTION AND SLOPE

SYMBOL	DESCRIPTION
FFE 10.00	FINISHED FLOOR ELEVATION
FS 10.00	FINISHED SURFACE
FG 10.00	FINISHED GRADE
TW 10.00	TOP OF WALL
BW 10.00	BOTTOM OF WALL
T5 10.00	TOP OF STAIR
BS 10.00	BOTTOM OF STAIR
TR 10.00	TOP OF RAMP
BR 10.00	BOTTOM OF RAMP

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THIS DRAWING IS NOT F FOR CONSTRUCTION STAMPED AND SIGNEE B	WORK UN	TIL IT HAS	BEEN
THE COPYRIGHTS TO ALL DISIG OF MACDONALD GRAY CONSILT PURPOSE OTHER THIN THAT CONSILTS	ANT'S, REPRO	BY MACEON	USE FOR

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# 560 Third Street Wertman Development Corporation Nanaimo, BC

#### IRRIGATION NOTES

- THE IRRIGATION SYSTEM SHALL BE AUTOMATICALLY CONTROLLED WITH SMART "ET" EQUIPMEN" AND SHALL OPERATE WITHIN THE CITY OF NANAIMO WATER RESTRICTION SCHEDULE.
- 2. THE IRRIGATION SYSTEM SHALL MEET OR EXCEED THE MOST CURRENT STANDARDS AND SPECIFICATIONS SET OUT BY THE IRRIGATION HOUSETY ASSOCIATION OF PRETISE COLLIMBIA (IMAGO, AS RETERENCED IN 1'S MOST CURRENT EDITION OF THE CANDIAN LANGEOUT STANDARD PREFARED BY THE CANDIAN SOCIETY OF LANGEOUT ARTHUR THE CANDIAN SOCIETY OF LANGEOUT ARTHUR TO (ICLA). 4 CAMBIAN INJERIEY LANGEOUT ARTHUR (ICLA)
- IRRIGATION EMISSION DEVICES SHALL BE LOW VOLUME ROTARY NOZZLES OR MICRO/ DRIP EQUIPMENT.
- THE PLACEMENT AND RADIUS OF SPRINNERS SHALL BE ADJUSTED AS REQUIRED BY FIELD CONDITIONS TO ACHIEVE FULL COVERAGE OF ALL PLANTED AREAS AND TO MINIMAZE OVER-SPRAY ONTO ADJACEST HARD SURFACES, PENCES AND PROPERTY LINES.
- 5. ALL PIPMG UNDER FAVING SHALL DE INSTALLED IN SEPARATE SOME OF STAND ACCEPTANT STAND ACCEPTANT STAND ACCEPTANT ACC
- ESTABLISHMENT WATERING SHALL MEET OR EXCEED THE LATEST EDITION OF THE CANADIAN LANDSCAPE STANDARD.

LANDSCAPE ARCHITECTURE SITE PLAN	October 29, 2018	WU	NG	1:200 metric	18-0208	L2 º 5
LANDSCAPE A SITE PLAN	Date:	Drawn.	Checked:	Scale:	Project Number:	DRAWING NUMBER:

ON SCHEDULE

NOTES

Coordination Review
Preliminary Review
Issued for Pricing
Issued for DP
Issued for DP
Issued for DP
Issued for DP
Issued for DP REVISION

Date
13JUN2018
26JUL2018
29AUG2018
19SEP2018
19OCT2018
29OCT2018







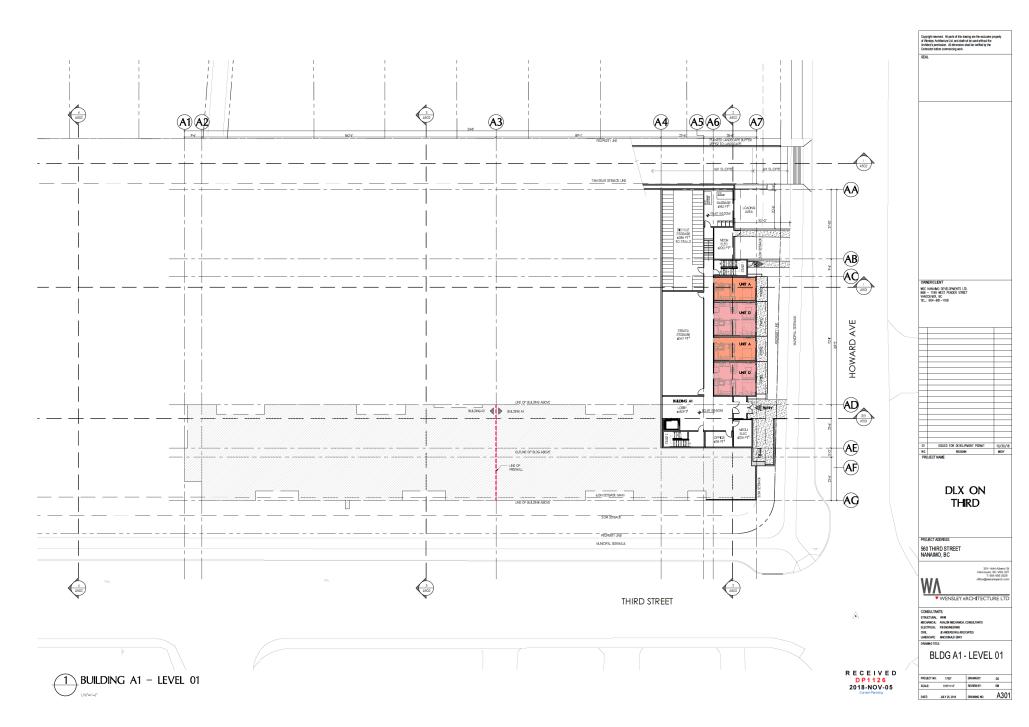


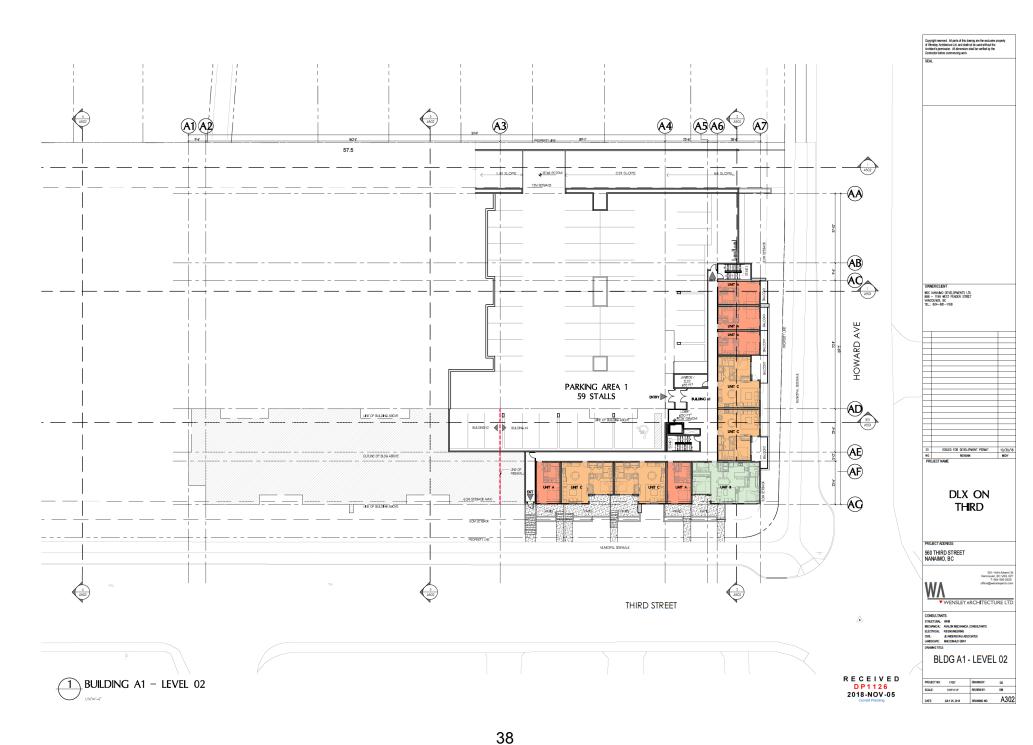


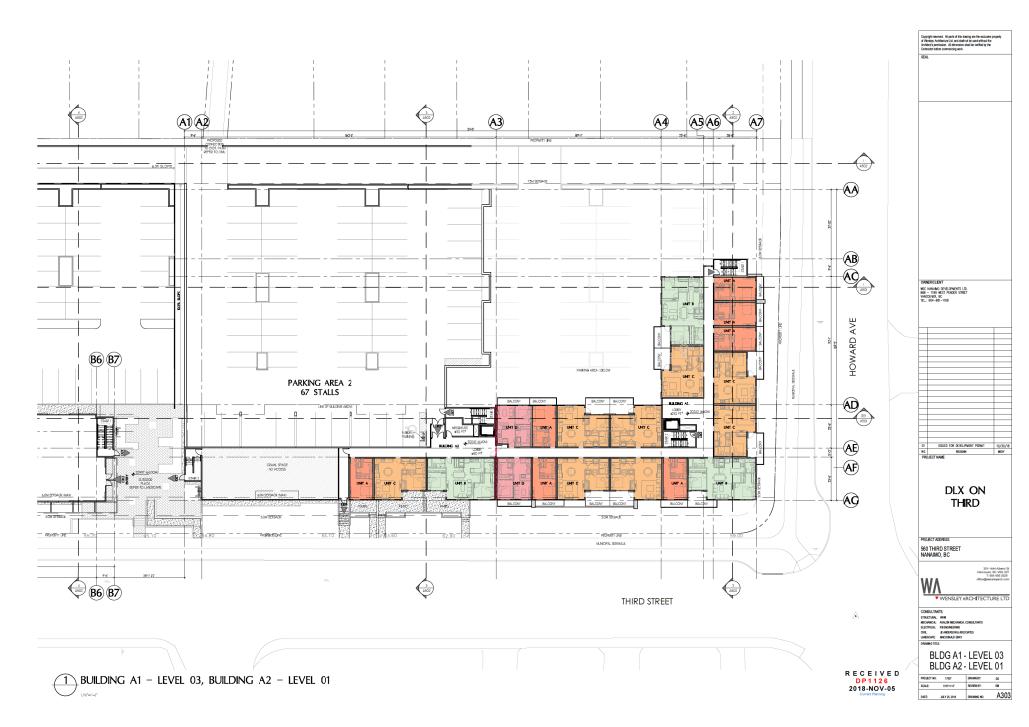
## 560 Third Street Wertman Development Corporation Nanaimo, BC

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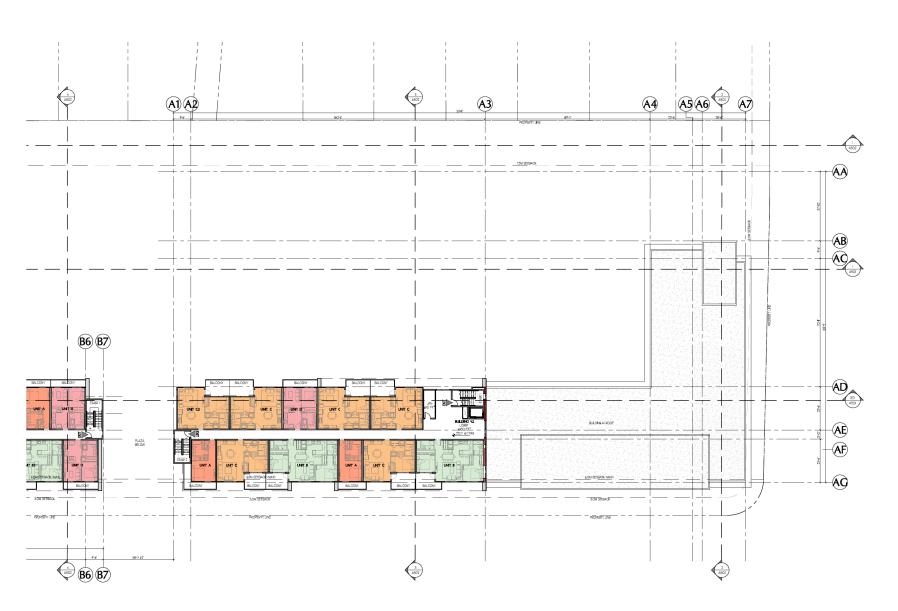


BUILDING A1 – LEVEL 04, BUILDING A2 – LEVEL 02

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2018-NOV-05



JULY 25, 2018 DRAWING NO: A304



BUILDING A1 - ROOF, BUILDING A2 - LEVEL 03

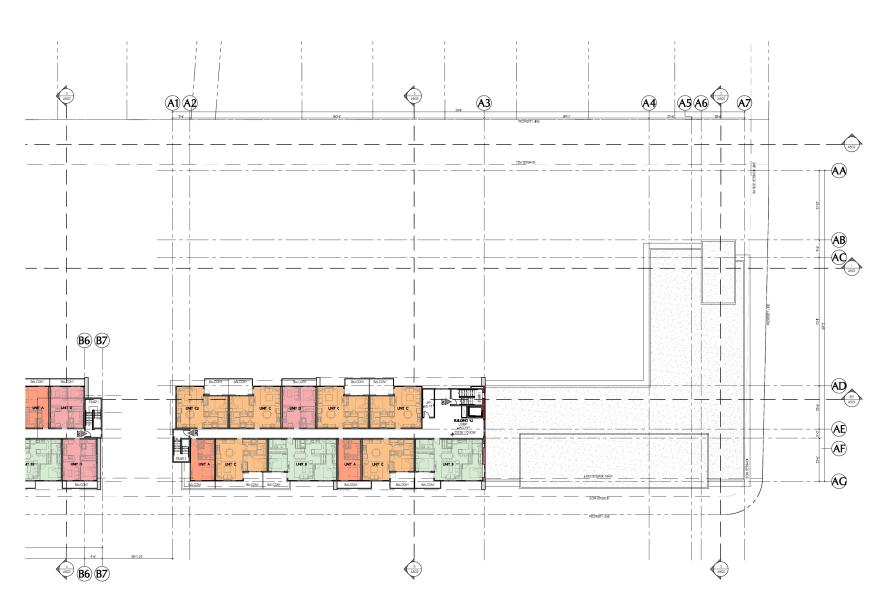
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DP1126
2018-NOV-05

Current Planning

OT ISSUED FOR DEVELOPMENT PERMIT 10/30/18
NO. REVISION MIDTY
PROJECT NAME DLX ON THIRD PROJECT ADDRESS: 560 THIRD STREET NANAIMO, BC CONSULTANTS:
STRUCTURAL: WHI
MECHANICA: ANALON MECHANICA, CONSULTANTS
ELECTRICAL: REBMINEERING
OVAL: & MODERSON & ASSOCIATES
LAMBSCAPE: MICCONALD GRAY BLDG A2 - LEVEL 03

A305

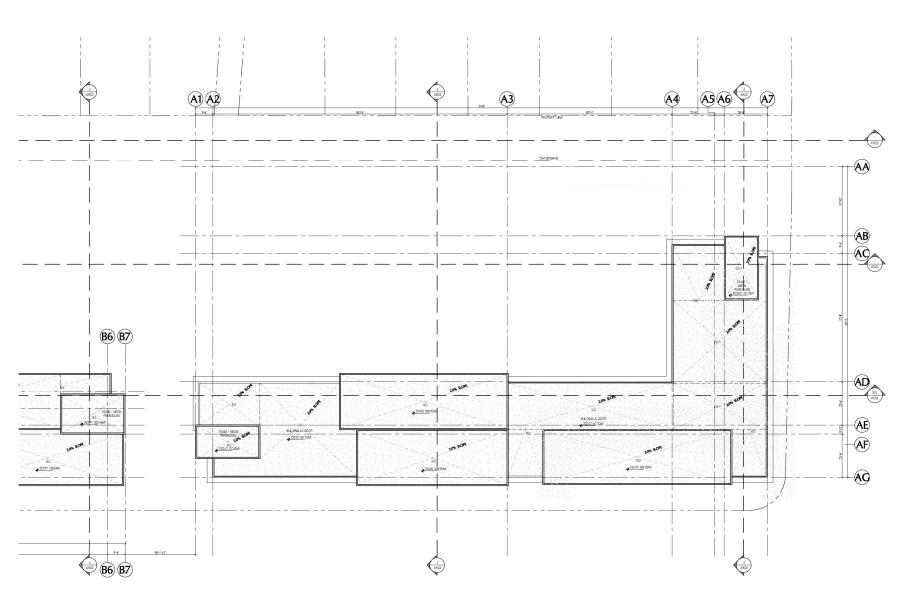


BUILDING A2 - LEVEL 04

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2018-NOV-05
Current Planning



A306



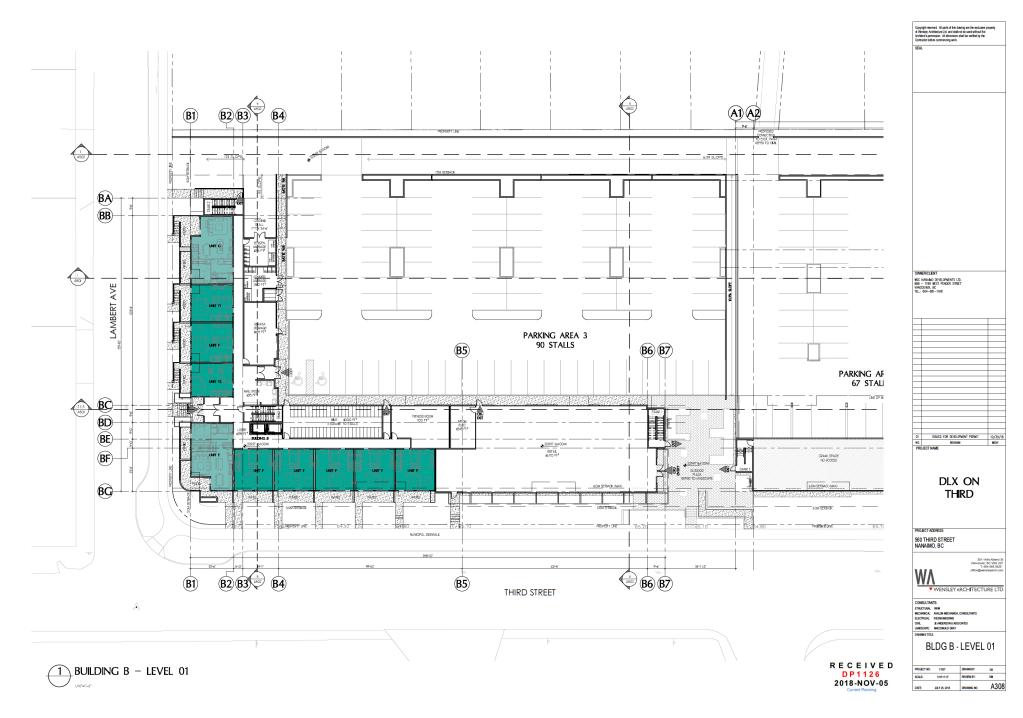
BUILDING A2 - LEVEL 04

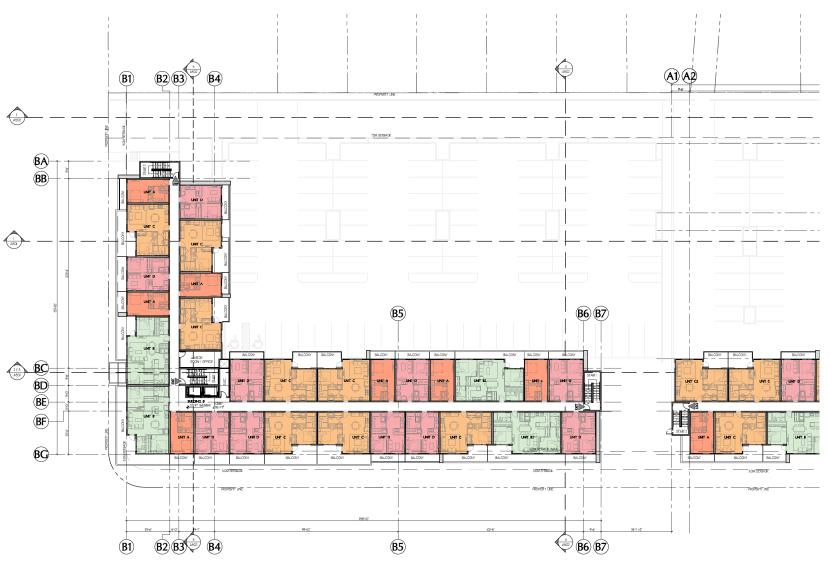




A307

DATE: JULY 25, 2018 DRAWING NO.



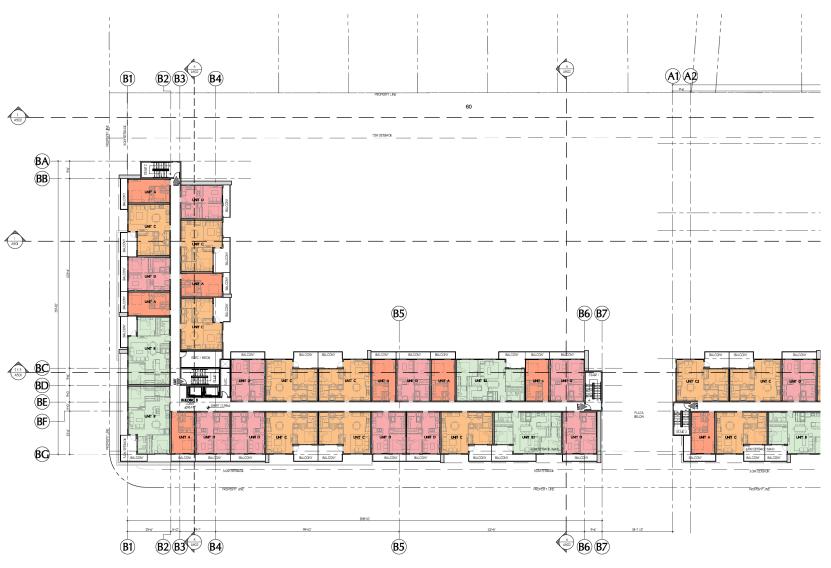


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STRICTURAL: WHM
MECHANICA: AMALON MECHANICA CONSULTANTS
ELECTRICAL: REENSINEERING
CALL: JE AMORESION A ASSOCIATES
LANGSGAPE: MACCONALD GRAY BLDG B - LEVEL 02 A309

DATE: JULY 25, 2018 DRAWING NO.

BUILDING B - LEVEL 02

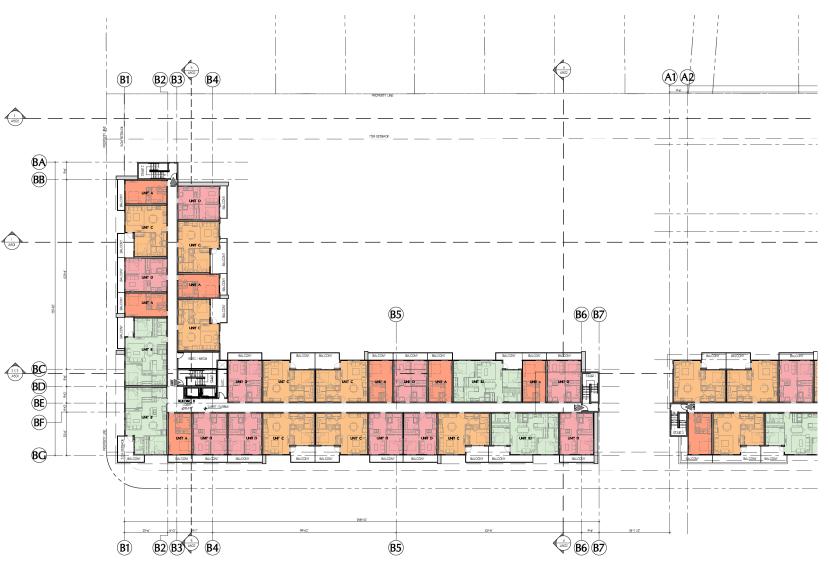
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STRICTURAL: WHM
MECHANICA: AMALON MECHANICA CONSULTANTS
ELECTRICAL: REENSINEERING
CALL: JE AMORESION A ASSOCIATES
LANGSGAPE: MACCONALD GRAY BLDG B - LEVEL 03 A310

BUILDING B - LEVEL 03

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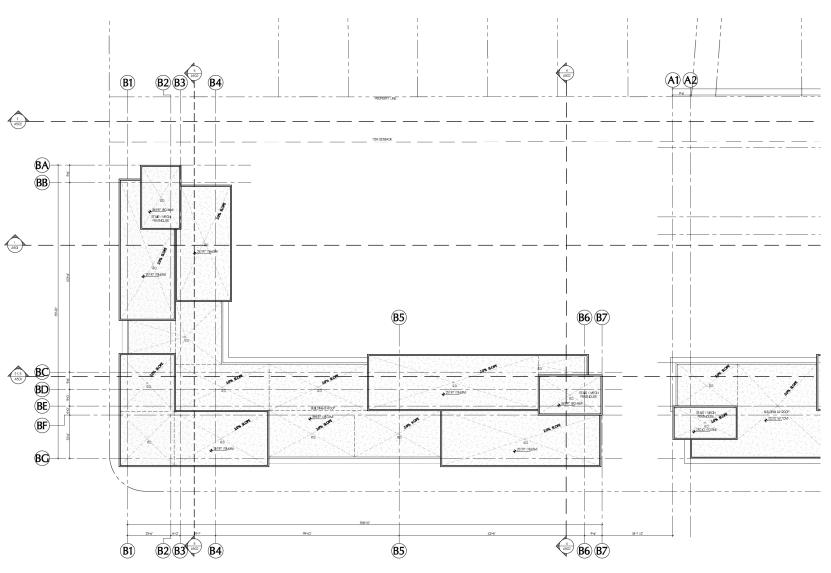
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STRICTURAL: WHM
MECHANICA: AMALON MECHANICA CONSULTANTS
ELECTRICAL: REENSINEERING
CALL: JE AMORESION A ASSOCIATES
LANGSGAPE: MACCONALD GRAY BLDG B - LEVEL 04

A311

DATE: JULY 25, 2018 DRAWING NO.

BUILDING B - LEVEL 04

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BUILDING B - ROOF LEVEL

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OVAL: A PROPERIOR A RESIDANTES
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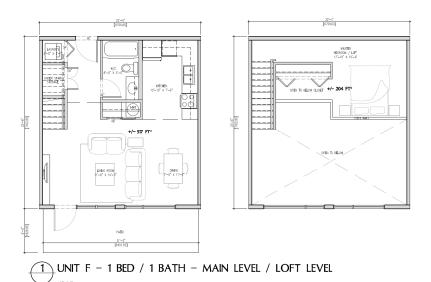
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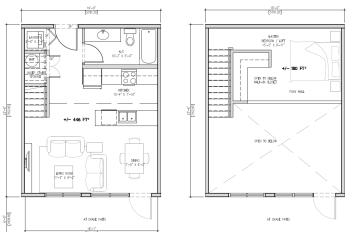
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560 THIRD ST NANAIMO, BC

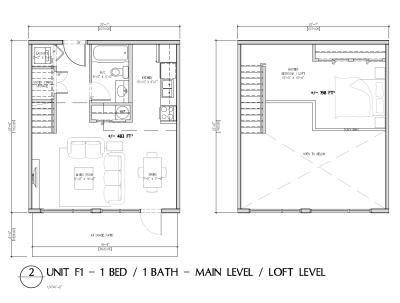
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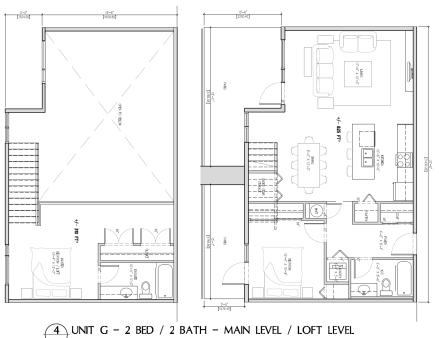
> 560 THIRD ST MIXED USE

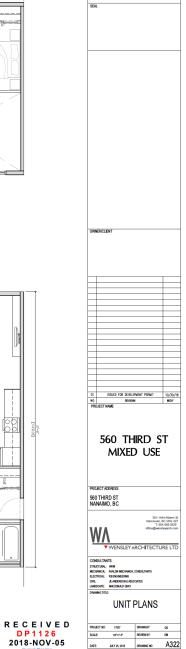














1 BLDG A1 - HOWARD AVE. ELEVATION (EAST)



2 BLDG A1 - PARKING ELEVATION 1 (WEST)



3 BLDG A1 - PARKING ELEVATION (NORTH) 3/32"=1"-0"



4 BLDG A1 - THIRD STREET ELEVATION 1 (SOUTH)

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LEGEND OF FINISHES 1 HARDIFAREL VERTICAL SIDNIG, SELECT CEDARNILL, IRON GRAY STUGGO, SMOOTH AGRYLG, GRANITE GRAY 3) STUCCO, SMOOTH ACRYLC, SUPER WHITE A HARDIPANEL SHOOTH PANEL BY HARDLER'S FALL BOX SRAY (5) HARDIPLANK LAP SIDING SHOOTH, ARCTIC HHITE 6 SAGIFER VERTICAL SIDIES, V-GROOVE PROFILE, HAZEL OAK CORRUGATED HETAL CLADDING, ANCOURD

(8) PRE-FINISHED HETAL PLISHING, ARTHRACTIE

(S) ALUMBUM CLAD PVC MIDCHS, MITTE FRAMES IN CLEAR SLAZING

(6) STOREFRORT GLAZING, BLACK FRAMES IN CLEAR GLAZING (T) METAL DOOR CANFULL LITE, TEMPTIFIED, CLEAR (8) METAL DOOR SOLID PANIED TO HATCH (9) SECTIONAL OVERHEAD DOOR, PRE-FINISHED TO MATCH (20) PICKET SUARD RAIL, FRE-FINISHED BLACK (2) CLEAR GLASS GUARD HEHBLACK POSTS, TEMPERED 22 OBSCURED GLASS PROVACY SCREEN IN FRE-FINISHED FRANCE (23) SIGNAGE - METAL LETTERS ON 5.5. STANDOFFS - LIGHTING TED

(9) PRE-FINSHED HETAL FLASHING, WHITE (0) HARDITRIM \$ BOARDS, SHOOTH, COLDUR TO HATCH ADJACENT (1) SAGIPER VENIED SOPHIS, NAZEL CAK 2 --- RESERVED -(B) CONCRETE NATURAL SACK RUBBED

(A) ALUMBIH CLAD PAC MIDONS, BLACK FRAMES W CLEAR SLAZINS 24) PRE-FINISHED BLACK STELL & GLASS CANCPY - TEMPERED, CLEAR OWNER/CLIENT 01 ISSUED FOR DEVELOPMENT PERMIT 10/30/16 NO. REVISION
PROJECT NAME DLX ON THIRD 560 THIRD STREET NANAIMO, BC ▼ WENSLEY ARCHITECTURE LTD CONSULTANTS:
STRUCTURAL: WHM
MECHANICA: AWALON MECHANICA CONSULTANTS
ELECTRICAL: REPOINBERRY
CVIL: JE ANDERSON A RESCRITES
LANDSCAPE: MICCORALD GRAY

**ELEVATIONS** 

PROJECT NO: 17007 DRAWN BY: DS

JULY 25, 2018 DRAWING NO.

A401

SCALE: 3037\*F-0" REVIEW BY:



1 BLDG A2 - PARKING ELEVATION 1 (NORTH)



2 Bldg A2 - Third Street Elevation 1 (South)



3 BLDG A2 - PLAZA ELEVATION (WEST)

OWNER/CLIENT 01 ISSUED FOR DEVELOPMENT PERMIT 10/30/18
NO. PREVISION MIDY NO. REVISION
PROJECT NAME DLX ON THIRD 560 THIRD STREET NANAIMO, BC ▼ WENSLEY ARCHITECTURE LTD CONSULTANTS:
STRUCTURAL: WHIM
MECHANICA: AUMLIN MECHANICA CONSULTANTS
ELECTRICAL: REPONDEERING
COLL: JE ANDERSON A JASSICIATES
LANDSCAPE: MACCONALD GRAY

**ELEVATIONS** 

 PROJECT NO:
 17007
 DRAWN BY:
 DS

 SCALE:
 3507+7-0"
 REVIEW BY:
 DM

A402

DATE: JULY 25, 2018 DRAWING NO.

#### LEGEND OF FINISHES

- TUCCO SHOOTH ACRYLG SPANTE SPAY
- 3 STUCCO SHOOTH ACRYLG SUPER WHITE
- 4 HARDIPANEL, SHOOTH PANEL NV HARDI REVEAL, IRON GRAY
- 3 HARDIPLANK LAP SIDING SHOOTIL ARCTIC HHITE: (6) SAGIFTER VERTIKAL SIDINS, V-GROOVE PROFILE, HAZEL OAK
- (7) CORRUGATED HETAL CLADDING, ANCOUZED
- 8 PRE-FINSHED HETAL FLASHING, ANTHRACITE
- 9 PRE-FINSHED HETAL FLASHING, WHITE (10) HARDITRIM \$ BOARDS, SHOOTH, COLOUR TO MATCH ADJACENT
- (1) SASIPER VEHIED SOFFIES HAZEL DAK
- (12) - RESERVED -
- (B) CONCRETE NATURAL SACK RUBBED
- (ALIMBIM CLAD PVC NIDOMS, BLACK FRAMES W CLEAR GLAZING (B) ALUMBUM CLAD PVC HIBOOMS, MITTE FRAMES IN CLEAR GLAZING
- (6) STOREFRONT GLAZING, ELACK FRAMES NV CLEAR GLAZING
- (7) METAL DOOR CAN FULL DITE, TEMPTIRED, CLEAR
- (8) HETAL DOOR, SOLID, PARTED TO HATCH
- (9) SECTIONAL OVERNEAD DOOR, PRE-HINSHED TO MATCH
- 20 PICKET GUARD RAIL, PRE-FINISHED BLACK
- (21) CLEAR GLASS GUARD HITH BLACK POSTS, TEMPERED
- 22) CRESCURED GLASS PROVICT SCREEN N/ PRE-FINISHED FRAME
- (23) SIGNAGE METAL LETTERS ON 5.5. STANDOFFS LIGHTING TED 24 FRE-FINEHED BLACK STELL & GLASS CANCEY - TEMPERED, CLEAR

RECEIVED 2018-NOV-05



LEGEND OF FINISHES

- TUCCO. SHOOTH ACRYLC, GRANTE GRAY 3 STUCCO SHOOTH ACRYLC SUPER WHITE
- 4 HARDIPANEL, SHOOTH PANEL NV HARDI REVEAL, IRON GRAY
- 3 HARDIPLANK LAP SIDING SHOOTIL ARCTIC HHITE: (6) SAGIFTER VERTIKAL SIDINS, V-GROOVE PROFILE, HAZEL OAK
- (7) CORRUGATED HETAL CLADDING, ANCOUZED
- (8) PRE-FINSHED HETAL FLASHING, ANTI-RACITE
- 9 PRE-FINSHED HETAL FLASHNS, HHITE
- (10) HARDITRIM \$ BOARDS, SHOOTH, COLOUR TO MATCH ADJACENT
- (1) SASIPER VEHIED SOFFIES HAZEL DAK
- (12) - RESERVED - -
- (B) CONCRETE NATURAL SAOK RUBBED
- (ALIMBIM CLAD PVC NIDOMS, BLACK FRAMES W CLEAR GLAZING (S) ALUMBUM CLAD PICC HIRDOMS, MITTE FRAMES IN CLEAR GLAZING
- (6) STOREFRONT GLAZING, ELACK FRAMES NV CLEAR GLAZING
- (7) METAL DOOR CANFULL DITE, TEMPTRED, CLEAR
- (B) HETAL DOOR SOLID PANTED TO HATCH
- (9) SECTIONAL OVERNEAD DOOR, PRE-HINSHED TO MATCH
- 20 PICKET GUARD RAIL, PRE-FINISHED BLACK
- (21) CLEAR GLASS GUARD HITH BLACK POSTS, TEMPERED 22) CRESCURED GLASS PROVICT SCREEN IN PRE-FINISHED FRAME
- 33 SIGNAGE METAL LETTERS ON 5.5. STANDOFFS LIGHTING TBD
- (24) FRE-FINISHED BLACK STELL I SLASS CANCEY TEMPERED, CLEAR

RECEIVED DP1126 2018-NOV-05

OWNER/CLIENT 01 ISSUED FOR DEVELOPMENT PERMIT 10/30/18
NO. PREVISION MIGHT NO. REVISION
PROJECT NAME DLX ON THIRD 560 THIRD STREET NANAIMO, BC ▼ WENSLEY ARCHITECTURE LTD CONSULTANTS:
STRUCTURAL: WHIM
MECHANICA: AUMLIN MECHANICA CONSULTANTS
ELECTRICAL: REPONDEERING
COLL: JE ANDERSON A JASSICIATES
LANDSCAPE: MACCONALD GRAY **ELEVATIONS**  
 PROJECT NO:
 17007
 DRAWN BY:
 DS

 SCALE:
 3507+7-0"
 REVIEW BY:
 DM
 A403 DATE: JULY 25, 2018 DRAWING NO.



1 BLDG B - PLAZA ELEVATION (EAST)



2 BLDG B - LAMBERT AVE. ELEVATION (WEST) 3/32"=1"-0"

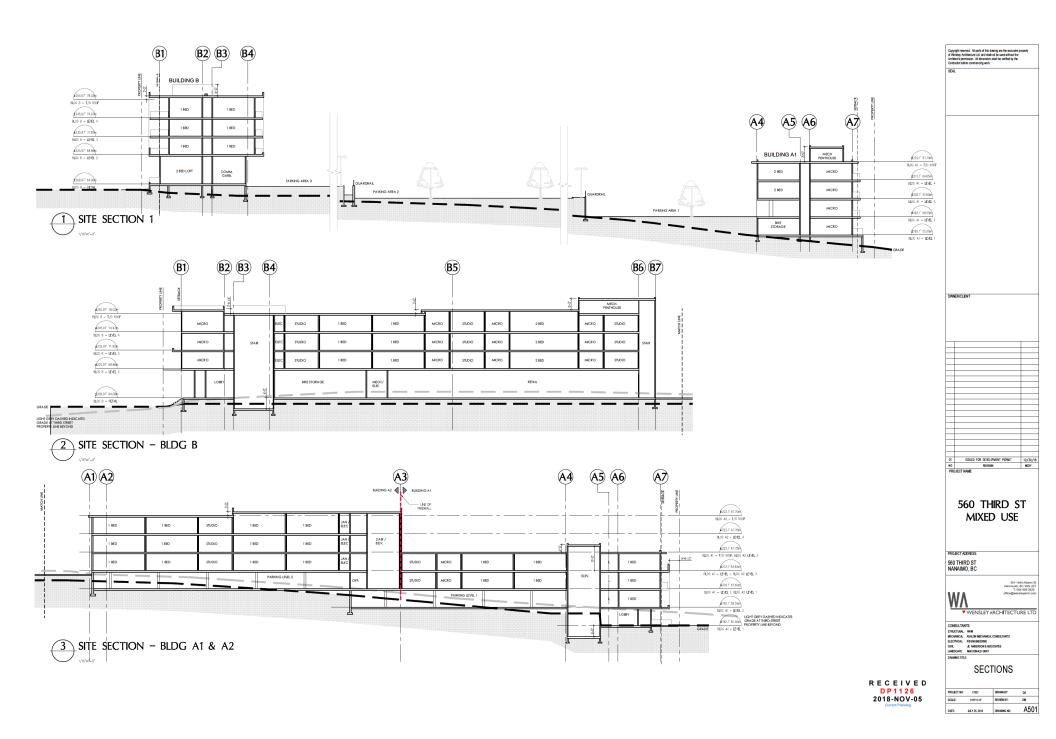
> RECEIVED DP1126 2018-NOV-05

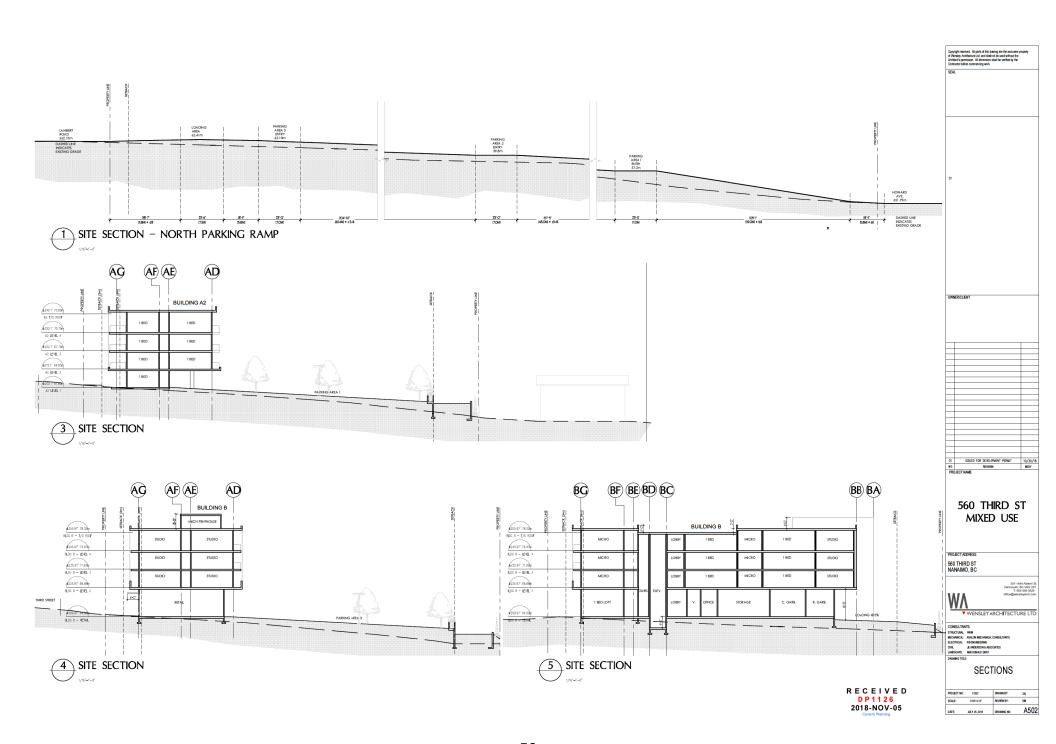
#### LEGEND OF FINISHES

- TUCCO SHOOTH ACRYLG SPANTE SPAY
- 3 STUCCO SHOOTH ACRYLG SUPER WHITE
- 4 HARDIPANEL, SHOOTH PANEL NV HARDI REVEAL, IRON GRAY
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- (B) CONCRETE NATURAL SACK RUBBED
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PROJECT NAME DLX ON THIRD 560 THIRD STREET NANAIMO, BC ▼ WENSLEY ARCHITECTURE LTD CONSULTANTS:
STRUCTURAL: WHIM
MECHANICA: AUMLIN MECHANICA CONSULTANTS
ELECTRICAL: REPONDEERING
COLL: JE ANDERSON A JASSICIATES
LANDSCAPE: MACCONALD GRAY **ELEVATIONS**  
 PROJECT NO:
 17007
 DRAWN BY:
 DS

 SCALE:
 3507+7-0"
 REVIEW BY:
 DM
 A404 DATE: JULY 25, 2018 DRAWING NO.



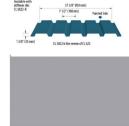




BUILDING B - CORNER OF THIRD AND LAMBERT



BUILDING A - HOWARD AVE



VERTICAL METAL SIDING COLOUR - VICWEST SILVER













CONCRETE - NATURAL

HARDIE PLANK LAP SIDING SMOOTH - COLOUR PLUS ARTIC WHITE



FASCIA & SOFFIT COLOUR - SUPER WHITE



SAGIPER VERTICAL SIDING AND SOFFIT



COLOUR - REF#6 HAZEL OAK



SACK RUBBED

**DP1126** 



#### COLOUR SCHEDULE

1) HARDIE PANEL VERTICAL SIDING

2) STUCCO FINISH SMOOTH

STUCCO FINISH SMOOTH

HARDIE REVEAL PANEL

HARDIE PLANK LAP SIDING

SAGIPER VERTICAL SIDING

VERTICAL METAL CLADDING

PRE-FINISHED METAL FLASHINGS

HARDIE TRIM BOARDS

10) SAGIPER SOFFIT

11) VINYL WINDOWS & DOORS

12) VINYL WINDOWS & DOORS

13) STOREFRONT

14) PICKET GUARD RAIL

15) GLAZING GUARD

16) CONCRETE

SELECT CEDARMILL COLOUR PLUS - IRON GRAY

ACRYLIC - GRANITE GRAY

ACRYLIC - SUPER WHITE

SMOOTH - COLOUR PLUS - IRON GRAY

SMOOTH - COLOUR PLUS - ARTIC WHITE

SAGIPER #6 HAZEL OAK

VICWEST - ARGENT 6724 SILVER

COLOUR TO MATCH ADJACENT

SMOOTH - COLOUR WATCH ADJACENT

SAGIPER #6 HAZEL OAK

BLACK FRAMES WI/CLEAR GLAZING

WHITE FRAMES W/CLEAR GLAZING

BLACK FRAMES W/CLEAR GLAZING

PRE-FINISHED FRAME-BLACK

PRE-FINISHED FRAME-BLACK

NATURAL SACK RUBBED

RECEIVED 2018-NOV-05

DLX ON THIRD PROJECT ADDRESS 560 THIRD STREET NANAIMO, BC MATERIALS **BCARD** 

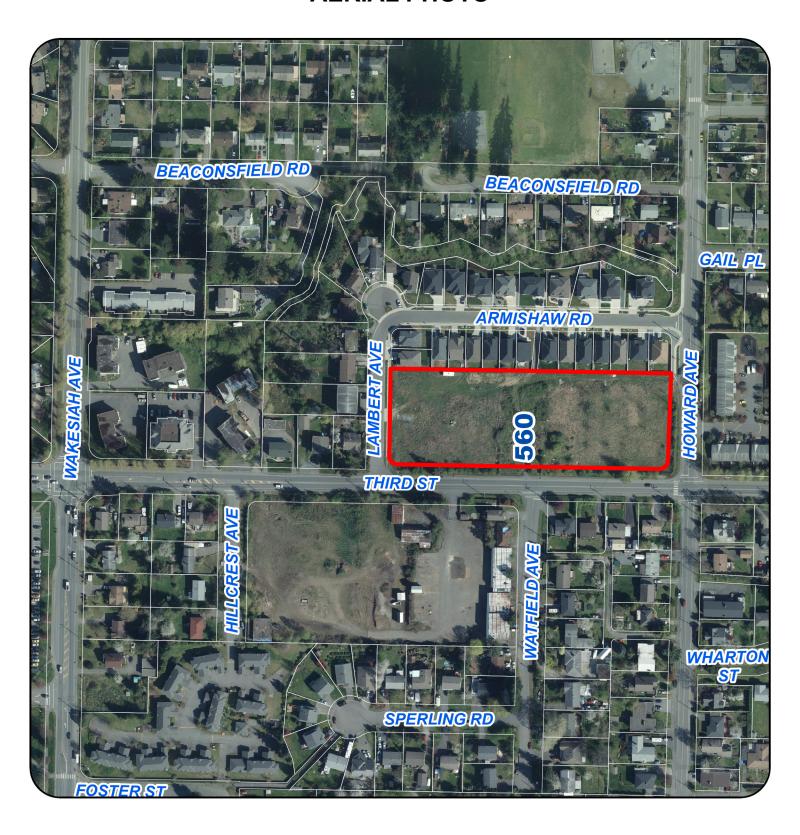
STEEL CANOPY

PRE-FINISHED BLACK

VINYL WINDOW

PRE-FNISHED - BLACK PRE-FINISHED - WHITE

# **AERIAL PHOTO**





# **DEVELOPMENT PERMIT NO. DP001126**

### STAFF DESIGN COMMENT

#### DEVELOPMENT PERMIT NO. DP001128 - 576/580 ROSEHILL STREET

Applicant/Architect: RAYMOND DE BEELD ARCHITECT INC.

Owner: ANAYK HOME BUILDERS LTD.

Landscape Architect: LANARC

#### Subject Property:

Zoning	R8- Medium Density Residential
Location	The subject properties are located on the north side of Rosehill Street, within the
	Townsite neighbourhood.
Lot Area	576 Rosehill- 558m <sup>2</sup>
	580 Rosehill- 558m <sup>2</sup>
	Total area- 1,116m <sup>2</sup>
Official	Map 1 – Future Land Use Plan – Neighbourhood
Community Plan	Map 3 –Development Permit Area No. 9 - Commercial, Industrial, Institutional,
(OCP)	Multiple Family and Mixed Commercial/Residential development
Relevant Design	General Development Permit Area Design Guidelines
Guidelines	

#### **BACKGROUND**

The subject area includes two separate properties which will be consolidated into a single lot as a condition of the Development Permit.

### Site Context

The subject properties are long narrow lots with rear yard lane access. Each property currently includes a single residential dwelling which will be removed.

The area between Townsite Road and Bradley Street, inclusive of the subject properties, includes a number of small narrow lots which are zoned Medium Density Residential (R8). A number of these lots have been consolidated in order to construct multiple family housing developments; as such, the area includes a range of residential densities and lot sizes.

A small commercial plaza located at the corner of Townsite Road and Millstone Avenue provides local services within the neighbourhood. Bowen Park and the Millstream River are approximately 200m directly south of the subject properties. The properties are located approximately 15 minutes (1.2km) from 1 Terminal Avenue, considered the northernmost downtown property.

#### PROPOSED DEVELOPMENT

The proposed development is a four-storey (13 unit) multiple family development.

The R8 Zone permits a base floor area ratio (FAR) of 1.25 with an additional 0.1m FAR available by achieving Tier 1 of the Schedule 'D' Amenity Requirements for Additional Density in

DP001128 – 576/580 Rosehill Street Staff Design Comment Page 2

Zoning Bylaw 4500. The proposed FAR is 1.33 and as such, the applicant proposes to provide the amenities required for the additional density such as the following:

- a letter from a mechanical engineer confirming the building exceeds ASHRAE 90.1 2010
   Energy Standards by 5% or more;
- public art;
- plumbing features which use 35% less water than the BC Building Code standard;
- a water efficient irrigation system;
- a green roof; and,
- at least 50% of the site will be covered with a permeable surface area.

The applicant will be rewarded with additional points required to achieve Tier 1, due to the subject property location.

#### Site Design

Site layout was partially dictated by the existing grade of the properties as well as by lot orientation, daylighting, security and access. The applicant notes, the existing grade drops diagonally 3.25m across the site. To address the grade and avoid basement units, the pedestrian access to the apartment building will be via a set of stairs from Rosehill Street. Low height landscaped retaining walls are included within the front yard setback. An accessible ramp is provided to the rear entry of the street. Short term bicycling parking is available adjacent to the stairway; and, long term bicycle parking is provided within the lower floor of the building.

Vehicle access to the site will be from the rear laneway. Surface and under-the-building parking is provided at-grade. Fifty percent of the parking provided is located under-the-building with the remaining 50% is located behind the building. The proposed site configuration requires variances to the front yard setback, lot coverage and off-street parking requirement.

#### **Building Design**

The proposed building is a four-storey building with the fourth floor set back from the lower wall faces on all sides. A green roof and rooftop deck space are provided above the third storey. While the Townsite neighbourhood does not have any area specific design guidelines, setting back the upper storey of a four-storey building is encouraged within other recently developed neighbourhood plan design guidelines. Setting back the upper storey allows for additional amenity space, reduces the scale of the building, and increases the availability of daylight to adjacent properties. Due to the sloped lot conditions and the preferred 2.74m (9 ft.) ceiling height in units, the applicant is requesting a 0.31m height variance.

The front façade of the building is enhanced with a varied building form, a mixture of colours and materials and the inclusion of corner balconies. The centre of the front façade is recessed from the adjacent wall face and includes a covered building entrance. The front entryway is raised above the street and accessed by a stairway. Building materials are predominately Hardi-plank with some tile used on either side of the building entrance.

The lower rear portion of the building includes under-the-building parking supported by concrete pillars. Approximately 50% of the lower portion of the structure is open air.

#### Staff Comments:

- The raised entryway presents challenges in establishing a direct connection to the street for the building. The applicants have worked to address this challenge by reducing the front yard setback and including strong entry features and a central stairway.
- The design of the building and related site lighting needs to address Crime Prevention through Environmental Design (CPTED) concerns related to the under-the-building parking area and the front façade. Consideration needs to be given to ensuring that illumination of parking area is adequately screened and the appropriate light intensity used to avoid negative impacts on neighbours.

#### Landscape Design

The landscape plan is coordinated with the onsite storm water management plan. A rain garden is provided along the eastern property side lot line. Landscaping along either side of the paved parking area was designed to accommodate surface flow of water. The green roof also provides additional storm water retention.

A water fountain is included within the front yard setback adjacent to the stairway. The water feature takes advantages of the grade by allowing water to cascade down a series of decorative retaining walls (tiled mosaic with sculptural metal salmon silhouettes) before being pumped back up for re-circulation. The tiled mosaic feature continues within the adjacent retaining wall and stairwell. The two tiers of retaining walls will include landscaping on both levels with trees (Red Japanese maple) and patio paving on the upper level.

A low height wooden fence, trees and hedge will screen the parking area from the side property lines. Due to the parking layout and access, no parking is provided along the rear property line adjacent to the laneway. Two separate garbage enclosures will be provided on either side of the parking area, directly adjacent to the lane.

#### Staff Comments:

- Consider additional design or landscape opportunities to add visual interest or screen the front yard retaining walls.
- Consider lighting within the fountain to add a point of interest to the streetscape.
- Details on building/site lighting to be provided.

#### PROPOSED VARIANCES

The following variances are for DAP consideration:

Maximum Allowable Lot Coverage

The maximum allowable lot coverage within the R8 zone is 40%. The proposed lot coverage is 46%, a proposed variance of 6%.

DP001128 – 576/580 Rosehill Street Staff Design Comment Page 4

### Maximum Allowable Building Height

The maximum allowable building height within the R8 zone is 14m. The proposed building height is 14.31m, a proposed variance of 0.31m.

#### Front Yard Setback

The minimum front yard setback is 6m. The proposed setback is 4.58m, a proposed variance of 1.42m.

The following variance is technical in nature and is not a form and character discussion:

### Off-street Parking

The required parking is 20 parking spaces. The proposed parking is 16 parking spaces, a proposed variance of 4 parking spaces.



755 Terminal Avenue North, Nanaimo, BC V9S 4K1

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Nov 02, 2018

### Design Rationale - 576/ 580 Rosehill Street Multi Family

#### Project:

New multi family condominium residences with under building parking.

#### Project Background:

Replace two small rundown single family homes and consolidate two small lots for a mid value multifamily condo development.

#### Site Layout:

Site layout dictated by existing grades, accessibility, security, daylighting, and lot orientation. Existing grade drops 3.25m diagonally across the 80ft x 150ft site, with an existing retaining wall and tall fence along the east side yard. Lane provides access to efficient parking layout and garbage/ recycling. Main floor height determined by accessibility access from the street and cross slope of parking lot. Below grade suites avoided. Height of the main floor provides definition of public/ private space. layering of landscaping to reduce building mass, and simplifies underground storm water detention tanks under front yard patios. Required side yard setbacks respected to allow landscaping, suite daylighting, and privacy from adjoining properties.

#### Parking:

Vehicle parking provide at grade under building to minimize cost and maximize stalls. Given transient neighbourhood, parking area secured from lane and side yards for security. Secured covered storage provided for bikes/ scooters with access to lane or street.

#### Vehicular Circulation:

Off-street parking/ drop off provided along street. Resident vehicular access provided from the lane. An automatic steel picket sliding gate along the lane is provided for security. To maximize parking, highly detailed/ durable garbage/ recyling enclosures are provided in the side yards.

#### Pedestrian Circulation:

Main pedestrian/ visitor access provided to the main entry from the street. Vehicular access provided from the lane with full or partial weather protection. An accessible ramp is provided to the rear entry from the street. Rear under building pedestrian walkway defined by changes in colour/ material and provides a buffer for vehicle movement away from the building facade.

D61198.

#### Form:

Majority of units take advantage of two facades for daylighting, views and privacy. Large balconies at building corners provide a transition of building mass with adjacent properties. Street facade enhanced with variegated form/ balconies, mix of materials, and colours to provide interest and break down the building mass to better fit with the mix of low rise apartment buildings and single family dwellings. Building form is contemporary, a bit more upscale, but compatible with neighbourhood box form rental apartment buildings. A flat roof form is provided to limit building mass and allow more daylighting onto adjacent lots. A defined base, middle, and top is provided to provide a reduced scale and interest. Roof deck, amenity space, and 4<sup>th</sup> floor unit setback from main building perimeter to obscure presence and increase daylighting of adjacent properties.

#### Materials & Colour:

Colour scheme incorporates softer neutral/ natural colours to blend with the existing neighbourhood of mixed single family and multi family buildings. Upscale materials and details provided on street facade, but minimized on side yards that are less visible. Changes in vertical and horizontal materials/ colours/ textures break down the mass economically and fit the building better with the older single family dwellings. Smooth finished rod and cone formed concrete retaining walls are provide along the street. Retaining walls are terraced to break the scale and avoid guard rails on patios. A top level reveal in the concrete retaining wall adds interest between any gaps of landscaping that will water fall over the walls. Garbage/ recycling enclosure incorporates materials/ colours of retaining walls, fencing, and building cladding to provide an integrated composition.

#### **Exterior Lighting:**

Ground level lighting provided in yards to minimize impact of lighting on adjacent single family dwellings. Under building parking features indirect lighting on concrete columns, with scone wall lights at recessed building entry from parking lot. Bollard lighting along accessible sidewalk ramp and in parking area beyond building. Step lights and at grade accent lighting provided at main entry/ water feature from street. Balconies provided with pot light or wall scone with unit controlled dimmers. Exterior lighting with daylight and/ or motion sensor controls for energy efficiency, dark sky, and light spillage control.

#### Features:

Large exterior functionally shaped balconies provide useable outdoor space to enjoy the natural environment as well as provide 'eyes on the street' and yard. Common roof top deck with ocean/downtown/ Bowen Park views provided for socialization, recreational use, and urban food production. Roof top amenity room, storage for tools/ seasonal furniture, and roof canopy provided to ensure functional use. Roof top deck provides environmental benefits such as storm water retention, wildlife habitat and reduce heat island effect, as well as compensate for the higher zoning lot coverage.





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Nov 23, 2018

### 576/ 580 Rosehill Street - Development Permit Rationale for Variances

### Front Yard Setback:

Requirement: 6.0m.

Provided: 4.58m (excluding main entry canopy).

Variance: 1.42m.

- · Rationale:
  - Only living rooms and open balconies encroach within the setback.
  - Open balconies at building corners provide transition to adjacent structures with minimal side yard windows.

#### Lot Coverage:

- Requirement: 40%.
- Provided: 46%.
- Variance: 6%.
- Rationale:
  - Small lot size
  - Maximize quantity of ground level units, common indoor spaces, and affordable surface parking.
  - Provide a private/ secure common outdoor area with surrounding distant views and good solar exposure.
  - Increased lot coverage compensated with roof top deck.

#### Parking:

- Requirement:
  - Total: 1.62 stalls for 2 bedrooms & 1.26 for 1 bedroom = 20
  - 33% (40%) max small cars = 7
  - Designated Visitor: 1/22 units = 1
  - Accessible Parking: 21- 100 stalls (12'2"x19'0") = 2
  - EV Parking Level 2 Charging 10% of required parking = 2
  - EV Parking Level 2 rough-in, additional 20% of required parking = 4
  - Bicycle Long Term (secured/ covered) = 6.5



- Bicycle Short Term (visitor/ uncovered) = 0.13
- Scooter Long Term (secured/ covered) = 0

#### Provided:

- Total = 12
- Small cars = 2
- Designated Visitor = 1.
- Accessible Parking: 1 + oversized stall shared with level sidewalk.
- EV Parking Level 2 Charging 10% of required parking = 2
- EV Parking Level 2 rough-in, additional 20% of required parking = 4
- Bicycle Long Term (secured/ covered) = 16
- Bicycle Short Term (visitor/ uncovered) = 2
- Scooter Long Term (secured/ covered) = 3

#### Variance:

- Total: 4 stalls.
- Accessible Parking: 1.

#### Rationale:

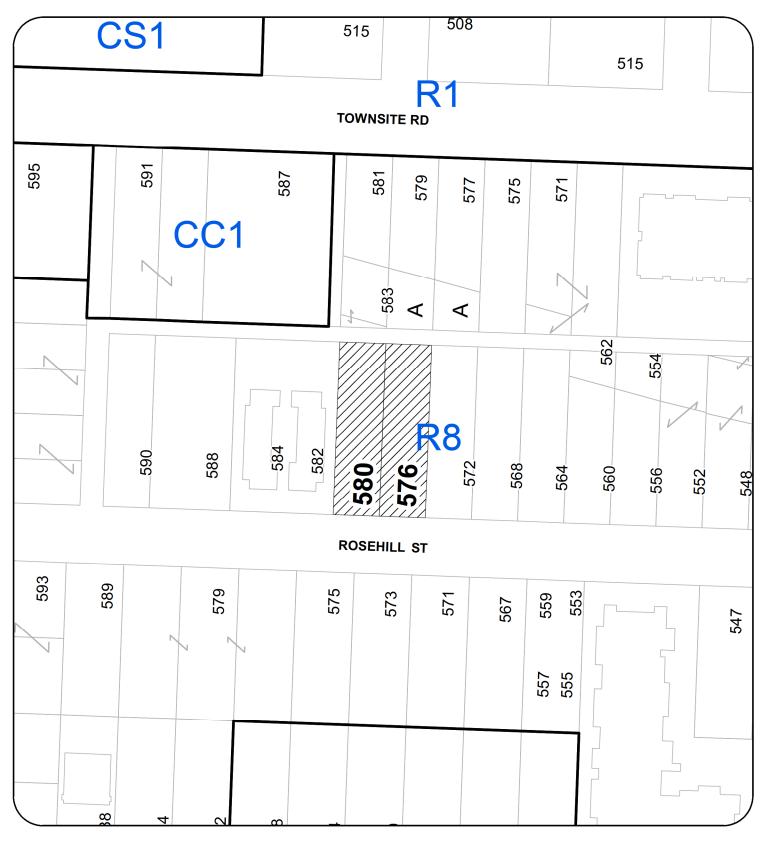
See also Traffic consultant report by Watt Consulting Group, dated Sept 18, 2018.

### **Building Height Variance:**

- · Requirement:
  - 14m.
- Provided:
  - 14.305m
- Variance: 0.305m
- Rationale:
  - •Minimum Roof Slope provided @ 1:12 for L4.
  - •Preferred Ceiling Height at 9'0" clear for floor levels.
  - Sloped Lot

Raymondide Beeld, Architect AIBC

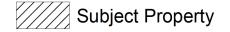
## **LOCATION PLAN**



# DEVELOPMENT PERMIT NO. DP001128 LOCATION PLAN

N

Civic: 576 & 580 ROSEHILL STREET Legal: LOT 7 & 8, SUBURBAN LOT 32 NEWCASTLE TOWNSITE, SECTION 1, NANAIMO DISTRICT, PLAN 1505 67





DRAWING LIST

ARCHITECTURAL 

| Drg. No. | Drawing Name | - | Coversheet |
D1 | Offsite services & Roadwork and Onsite Parking Grading |
D2 | Onsite stormwater retention, road details, notes and sedime

(1) CONSULTANTS LIST

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Parking Study:
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Tim Shah
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Tel:778 313.1014 act 436
Tel:250.388.0677 act 430
Email: dahir@attoonsultinggroup.com
Email: tshah@wattoonsultinggroup.com

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**ROSEHILL CONDOS** A0.0 576 Rosehill St, Nanaimo Coversheet Nov 22, 2018





2 Left Front Isometric Scale: Actual Size





3 Left Rear Isometric Scale: Actual Size

**ROSEHILL CONDOS** 

Right Rear Isometric
Scale: Actual Size



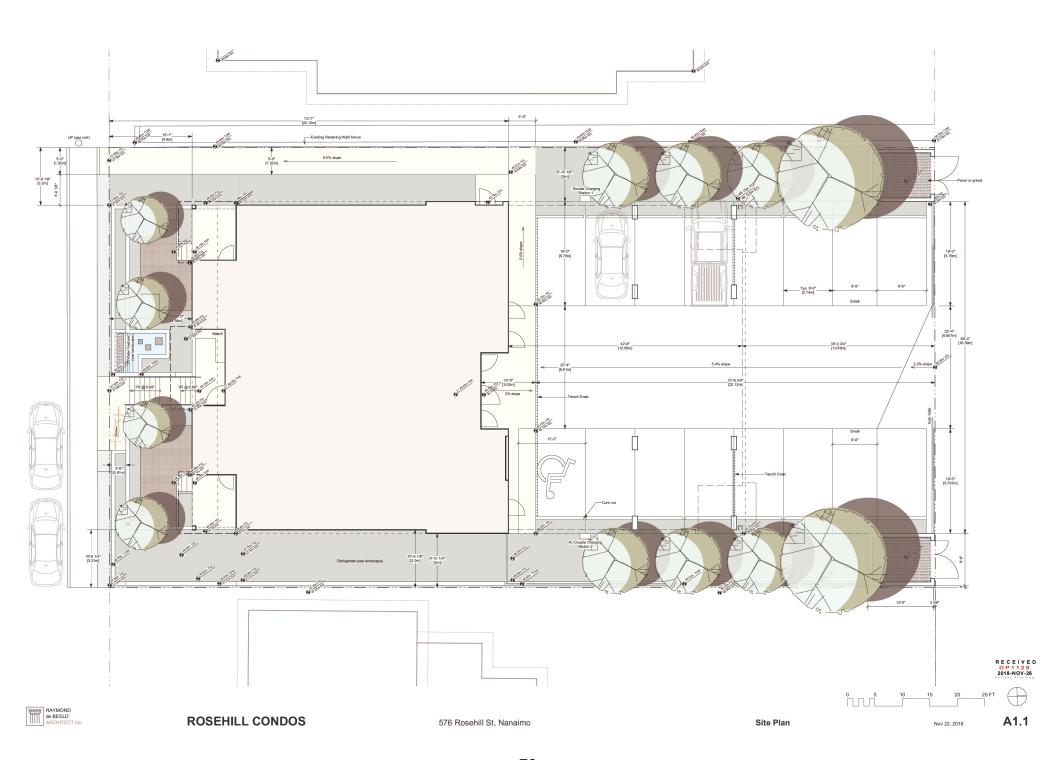
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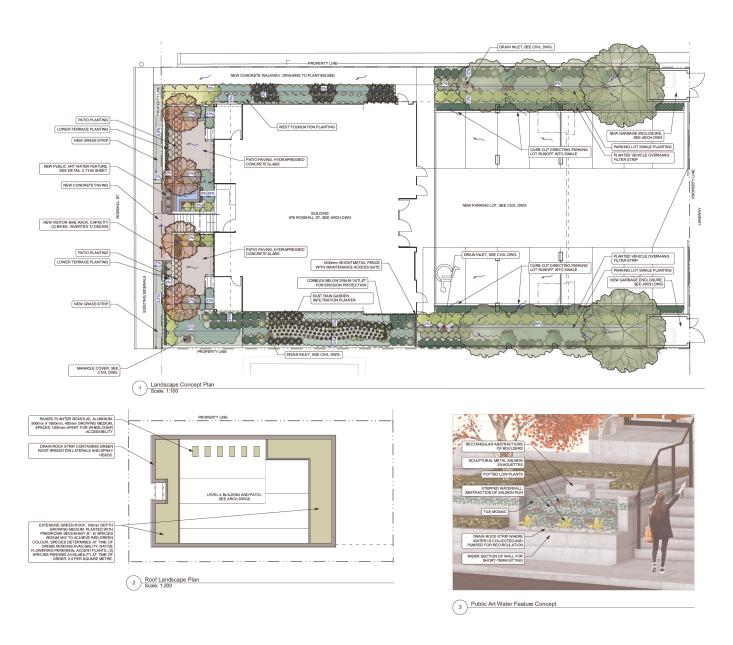
576 Rosehill St, Nanaimo

Perspectives

Nov 22, 2018

F0.1





#### DESIGN NARRATIVE

LOWER TERRACE PLANTING:

The planted lower terrace reduces the height of the retaining wall, resulting in a more comfortable enrormment for pedestrians travelling on the adjacent sidewalk. The planting palette includes even shrubs, ornamental grasses and flowering perennials to cascade over the lower wall.

SOUTH PATIO FLANTING:

The front patip planting frames the view of the building from the street, and creates a low, all season garden for residents in the ground floor units. The airly deciduous-lapanese maples cast dappled shade over the patio areas. This creates as cooler microclamate in the bot summer months, while allowing surgifyst to pass through in the writer. The low shrub and perennial borders maintain views between the street and building. A feature builder arrangement creates a visual archive near the building entrance.

#### WEST FOUNDATION PLANTING:

A low, shade tolerant planting bed follows the west walkway. Evergreen species create all season foliage.

EAST RAIN GARDEN INFILTRATION PLANTER: The east bioswale filters stormwater from the parking lot. Plant species are shade tolerant and can survive wet and dry conditions.

PARKING LOT INFILTRATION BEDS:
The parking bit planting beds create shade and all-season interest, while conveying stormwater runoff into the east ran garden. Evergreen species are balanced by deciduous shrubs with colourful branches or berries to provide interest in the winter months. Columnar maples trees frame the building and maples with a wider cancepy provide shade over the uncovered section of the parking lot.

#### GREEN ROOF PLANTING:

The extensive green roof consists of a sedum mat with perennial accent plantings to provide a visual ammently to building residents in the level 4 ammently area. The plant material will reduce the local urban heat slant effect and provide habitat for polinator insects and british.

#### PUBLIC ART WATER FEATURE:

The water feature provides an abstract interpretation of a salmon run, paying tribute to the volunteer efforts of Nanaimo residents in 2007 in constructing the Coho salmon side-channel in the nearby Millistone River.

ROOFTOP RAISED PLANTER BOXES:
The raised planter boxes in the rooftop ammenity area aim to improve food security by providing an opportunity for residents to grow food.

The plant species selected are drought tolerant and will be watered by a low-flow drip irrigation system. The green roof plantings will be irrigated by a low-flow matched precipitation spray system.

#### CANDIDATE PLANT SPECIES - GROUND LEVEL

SYMBOL	KEY	BOTANICAL NAME	COMMON NAME	SIZE	SPACING
DECIDUOUS TREES					
	ACE	Acer palmatum 'Emperor l'	Red Japanese Maple	6cm Cal.	SEE PLAY
	ACF	Acer x freemanii 'Jeffersred'	Auturm Blaze Maple	6cm Cal.	SEE PLAY
	ACS	Acer x freemanii 'Scarlet Sentinet'	Scarlet Sentinel Maple	6cm Cal.	SEE PLAY
DECIDUOUS SHRUBS					
0	cs	Comus seriosa 'Kelseyi'	Kelsey's Dwarf Red-Osier Dogwood	#2 Pot	120cm O.0
***	SA	Symphoricarpos albus	Snowberry	#1 Pot	70cm O.C
EVERGREEN SHRUBS					
	AR	Arbutus unedo 'Compacta'	Dwarf strawberry tree	#2 Pot	
0	LP	Lonicera pilesta	Honeysuckle	#2 Pot	100cm O.0
0	MN	Mahonia nervosa	Dull Oregon Grape	#1 Pot	60cm O.C
GROUNDCOVERS					
GROUNDCOVERS	AU	Arctostaphylos uva-ursi 'Vancouver Jade'	Vancouver Jade Kinnikinick	10cm Pot	30cm O.C
0	PS	Phlox subulata	Moss phlox	#1 Pot	70cm O.C
		1 1800 Standards	Inches brievy	#.F0	7 00.11 0.0
PERENNIALS					
0	VH	Vancouveria hexandra	American Barrenwort	#1 Pot	30cm O.C
GRASSES					
0	CA	Calamagrostis x acutiflora 'Karl Foerster'	Feather Reed Grass	#1 Pot	60cm O.C
0	ST	Stipa tenuissima	Feather Grass	#1 Pot	45cm O.C
BULBS					
4	т	Iris tenax	Oregon Iris	10cm Pot	SEE PLAN
	-				

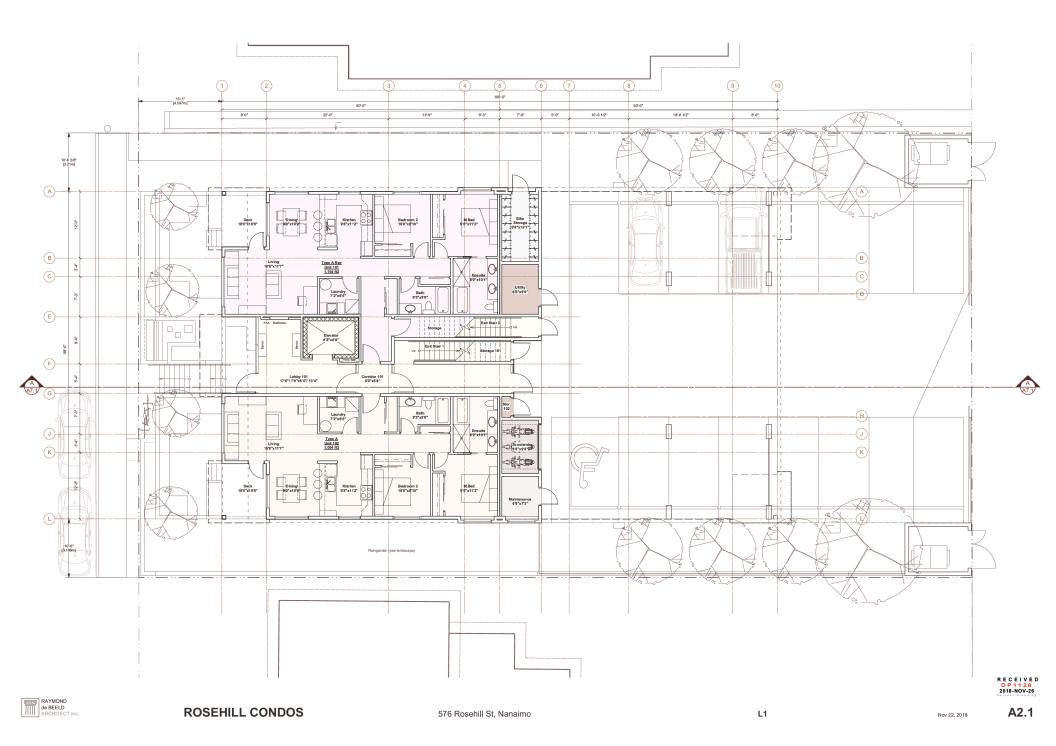


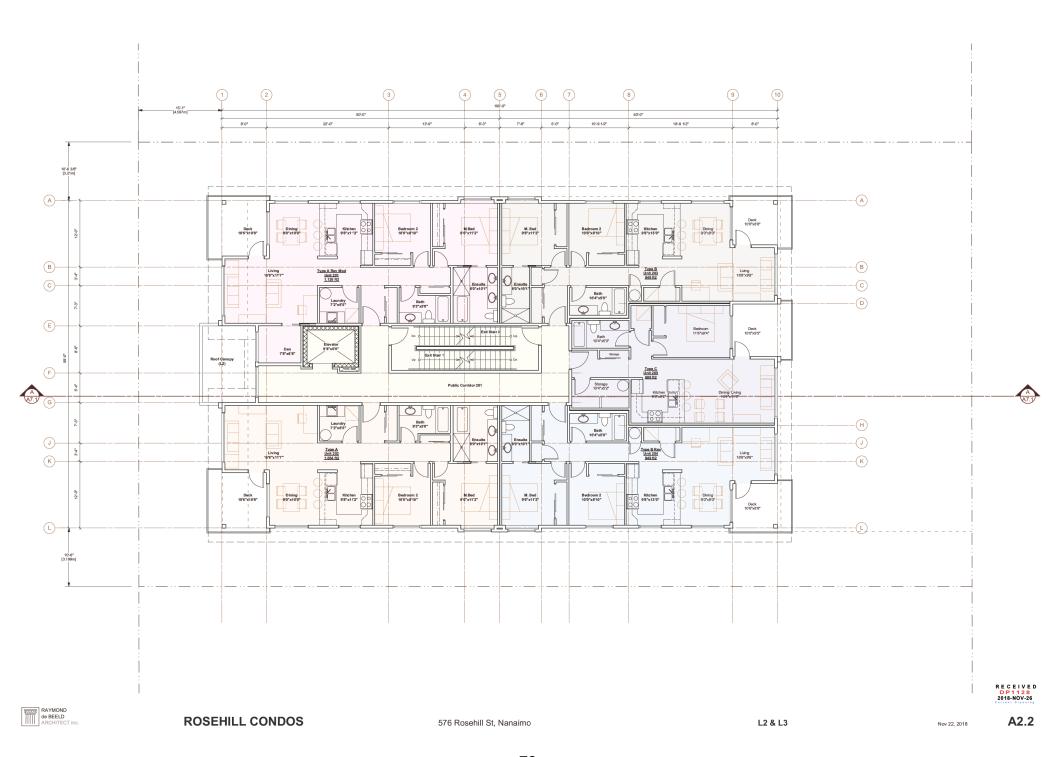


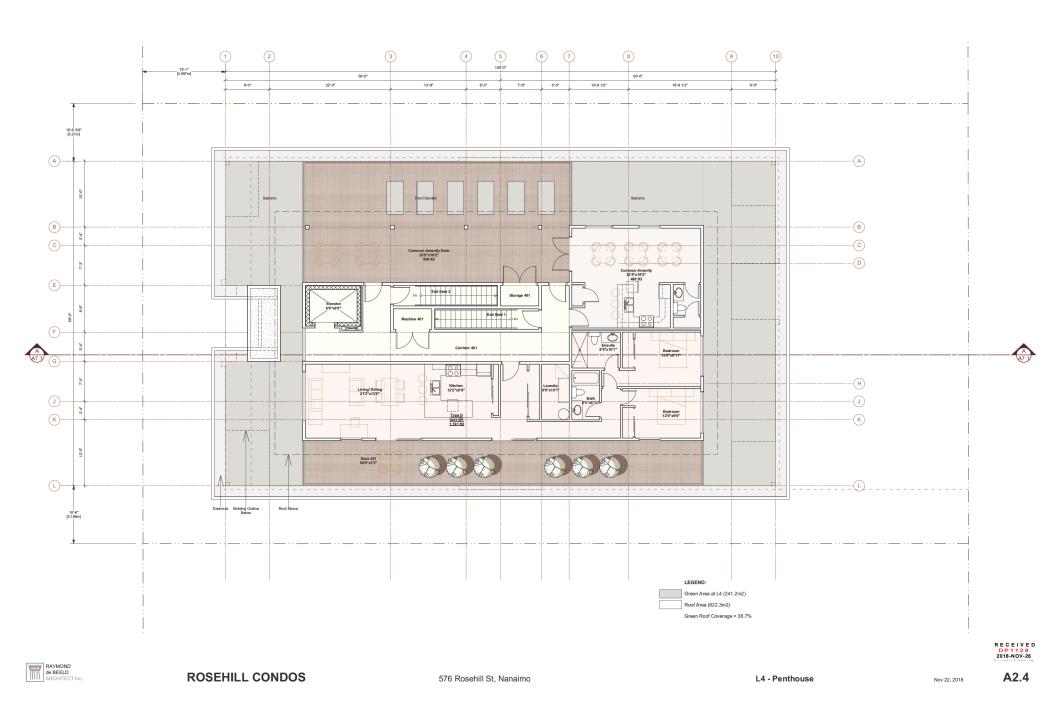
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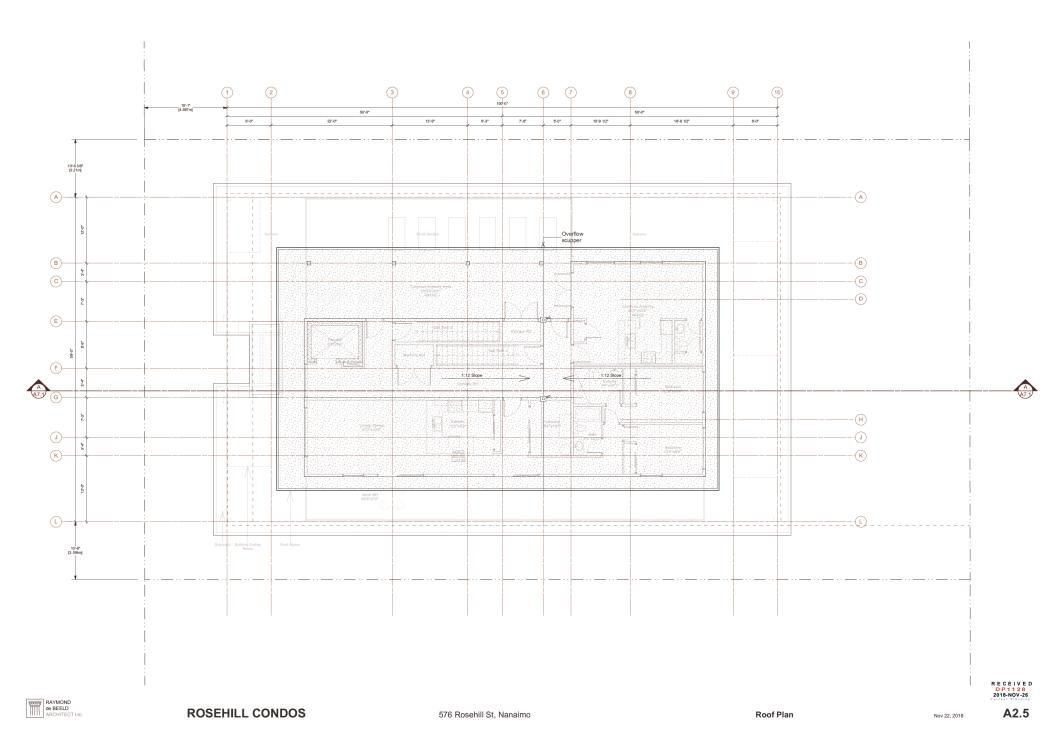
Landscape Concept Plan

Nov 22, 2018

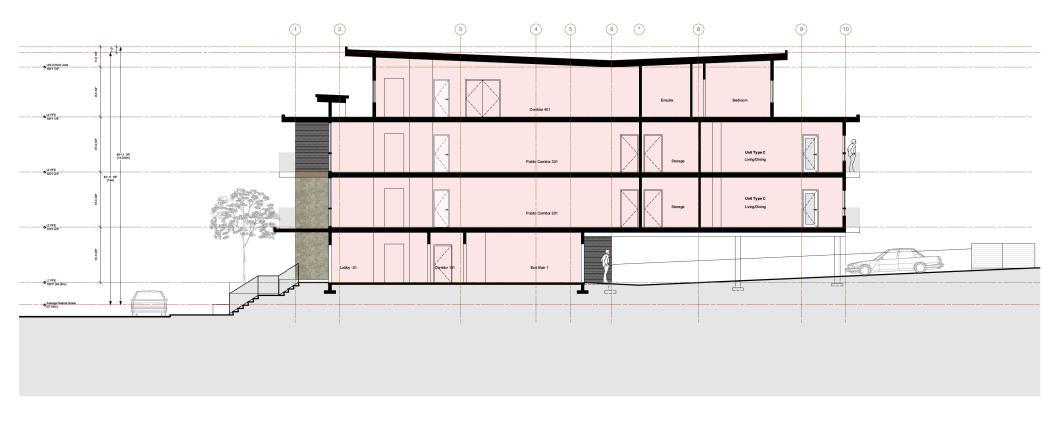












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**ROSEHILL CONDOS** 

576 Rosehill St, Nanaimo

Section 1

Nov 22, 2018 **A7.1** 

















3) Apartment across site

5) Apartment at Bradley St











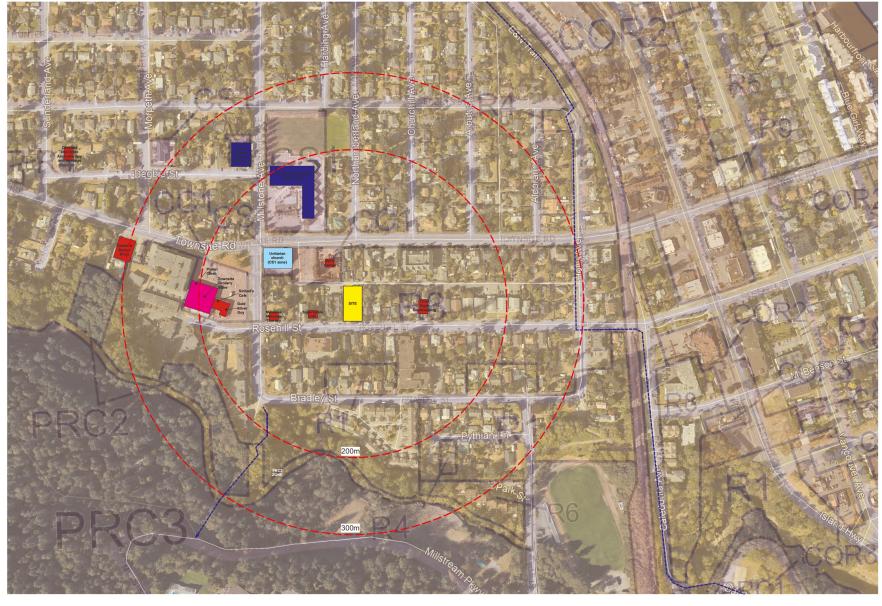


**ROSEHILL CONDOS** 576 Rosehill St, Nanaimo Context / Project Data

Nov 22, 2018

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ROSEHILL CONDOS

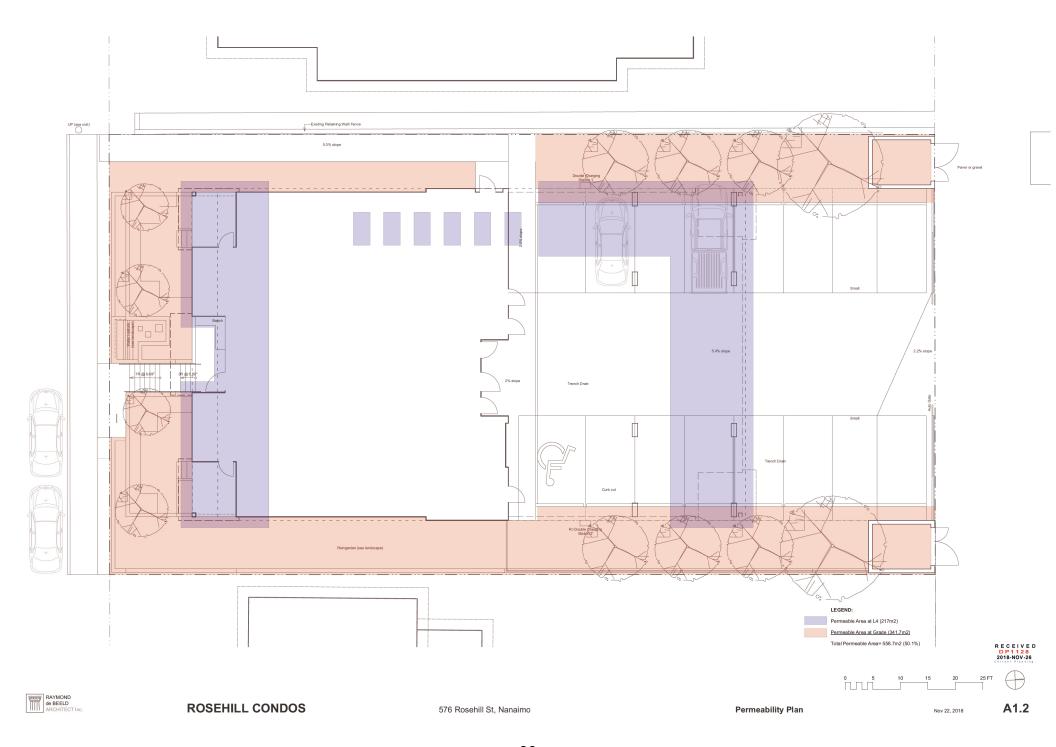
576 Rosehill St, Nanaimo

Neighbourhood Plan/ Amenity Tiers - Site Selection

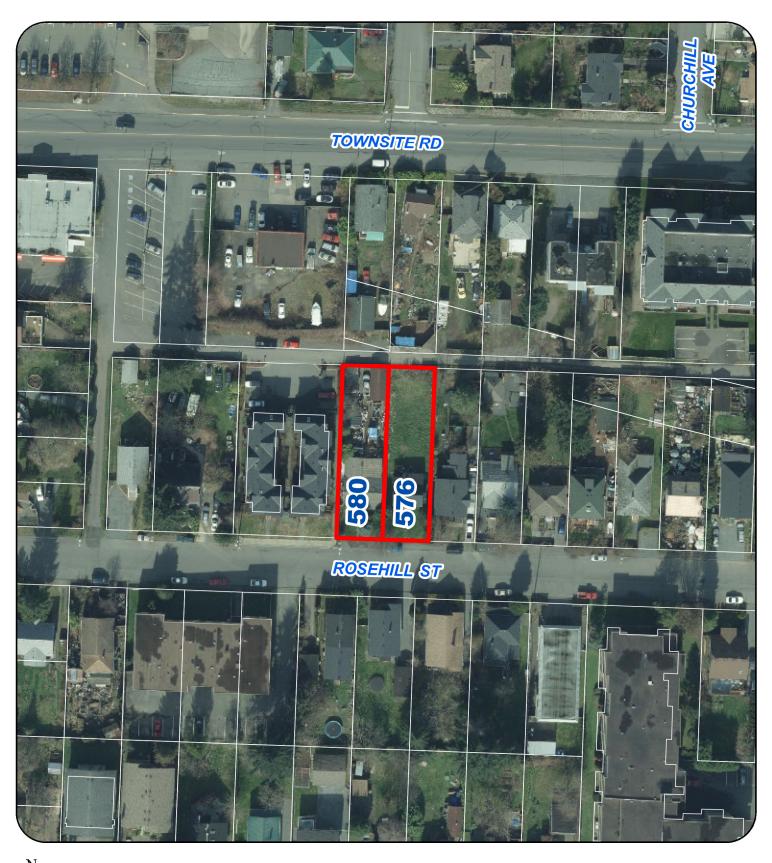
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# **AERIAL PHOTO**





# **DEVELOPMENT PERMIT NO. DP001128**